


1E	AREA IN AOI	PERCENT IN AOI
CENT SLOPES	14.5	34.5%
B PERCENT SLOPES	0.0	0.0%
ERCENT SLOPES	2.6	6.3%

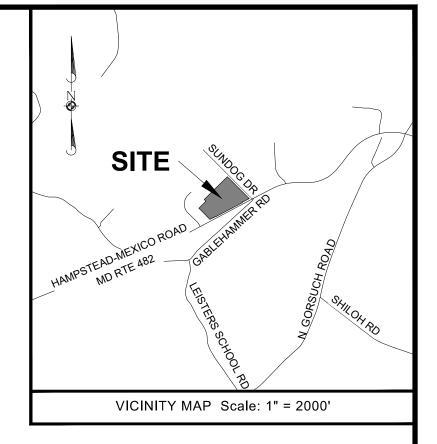


100 - YEAR FLOOD PLAIN						
RIVER STATION	EXISTING / PROPOSED W.S. ELEV. FT.					
100	744.68					
101	745.29					
102	745.98					
103	747.06					
104	747.86					
105	751.15					
106	751.29					
107	752.53					
108	754.13					
109	754.71					
110	754.89					


		ST		FER TRANSI		CALCULATI	ON		
TRANSECT #	ELEV @ STREAM BANK	ELEV @ 100 FT OFFSET	AVE SV SLOPE	MIN WIDTH	EXTENSION	WET-LANDS	> 25% SLOPE	TOTAL TRANSECT WIDTH	WRPE WIDTH
	(FT)	(FT)	(FT)	(FT)	(FT)	(FT)	(FT)	(FT)	(FT)
'RIGHT LOOKING DOWN STREAM									
XS100	741	745.2	4.2%	50	8	48	0	106	106
XS101	741.8	745	3.2%	50	6	43	0	99	99
XS102	741.9	745.7	3.8%	50	8	21	0	79	79
XS103	744	746	2.0%	50	4	44	0	98	98
XS104	744.6	748	3.4%	50	7	10	0	67	67
XS105	744.5	748.7	4.2%	50	8	78	0	136	136
XS106	746.5	752.5	6.0%	50	12	39	0	101	101
XS107	749	753	4.0%	50	8	16	0	74	74
XS108	749.7	753	3.3%	50	7	14	0	71	71
XS109	751.2	753	1.8%	50	4	11	0	65	65
XS110	752.0	758	6.0%	50	12	0	0	62	62

			ST	REAM BUFF	ER TRANSI		CALCULATI	NC		
-	TRANSECT #	ELEV @ STREAM BANK	ELEV @ 100 FT OFFSET	AVE SV SLOPE	MIN WIDTH	EXTENSION	WET-LANDS	> 25% SLOPE	TOTAL TRANSECT WIDTH	WRPE WIDTH
		(FT)	(FT)	(FT)	(FT)	(FT)	(FT)	(FT)	(FT)	(FT)
	'LEFT-SIDE LOOKING DOWN STREAM									
" [	XS100	N/A	N/A	N/A	N/A	N/A	0	0	0	0
	XS101	N/A	N/A	N/A	N/A	N/A	8	0	8	8
	XS102	N/A	N/A	N/A	N/A	N/A	28	0	28	28
	XS103	N/A	N/A	N/A	N/A	N/A	33	0	33	33
	XS104	N/A	N/A	N/A	N/A	N/A	12	0	42	42
	XS105	N/A	N/A	N/A	N/A	N/A	14	0	49	49
	XS106	747.5	752.5	5.0%	50	10	22	0	82	82
-	XS107	748.5	755	6.5%	50	13	15	0	78	78
	XS108	749.7	759	9.3%	50	19	25	0	94	94
	XS109	751.2	756.5	5.3%	50	11	54	0	115	115
· [	XS110	752.0	757.5	5.5%	50	11	0	0	61	61

	FLOOD PLAIN / STREAM BUFFER COWABUNGA FARM 2202 HAMPSTEAD MEXICO ROAD					
	8th EL	ECTION DISTRICT TAX MAP - 40			COUNTY, MARYLAND NRCEL - 527	
	DATE	REVISIONS	BY			
OWNER/ DEVELOPER						
Richard Sobbott and Brenda Sobbott 2202 Hampstead Mexico Road	Surveyed By DCI Computed By RLS Drawn By	PROFESSIONAL CERTIFICATION: I HEREBY CERTIFY THAT THESE DOCUMENTS WERE PREPARED OR APPROVED BY ME, AND THAT I AM A DULY LICENSED PROFESSIONAL ENGINEER UNDER THE LAWS OF THE STATE OF MARYLAND, LICENSE NO. 15222, EXPIRATION DATE: 1/4/2027		2202 Hamps Westminste	obbott, PE, RLS stead Mexico Road r, Maryland 21157 410-300-6350)	
Westminster, MD 21157 Phone: 410 - 300 - 6530	REZ	_		Date: 5/15/2025	Scale: AS SHOWN	
Filone. 410 - 300 - 0330	Checked By RLS	-		SHEET NO.	2 OF 9	
	Drawing No. XX-XXX-XXX	5/15/2025 DATE			5-0008	

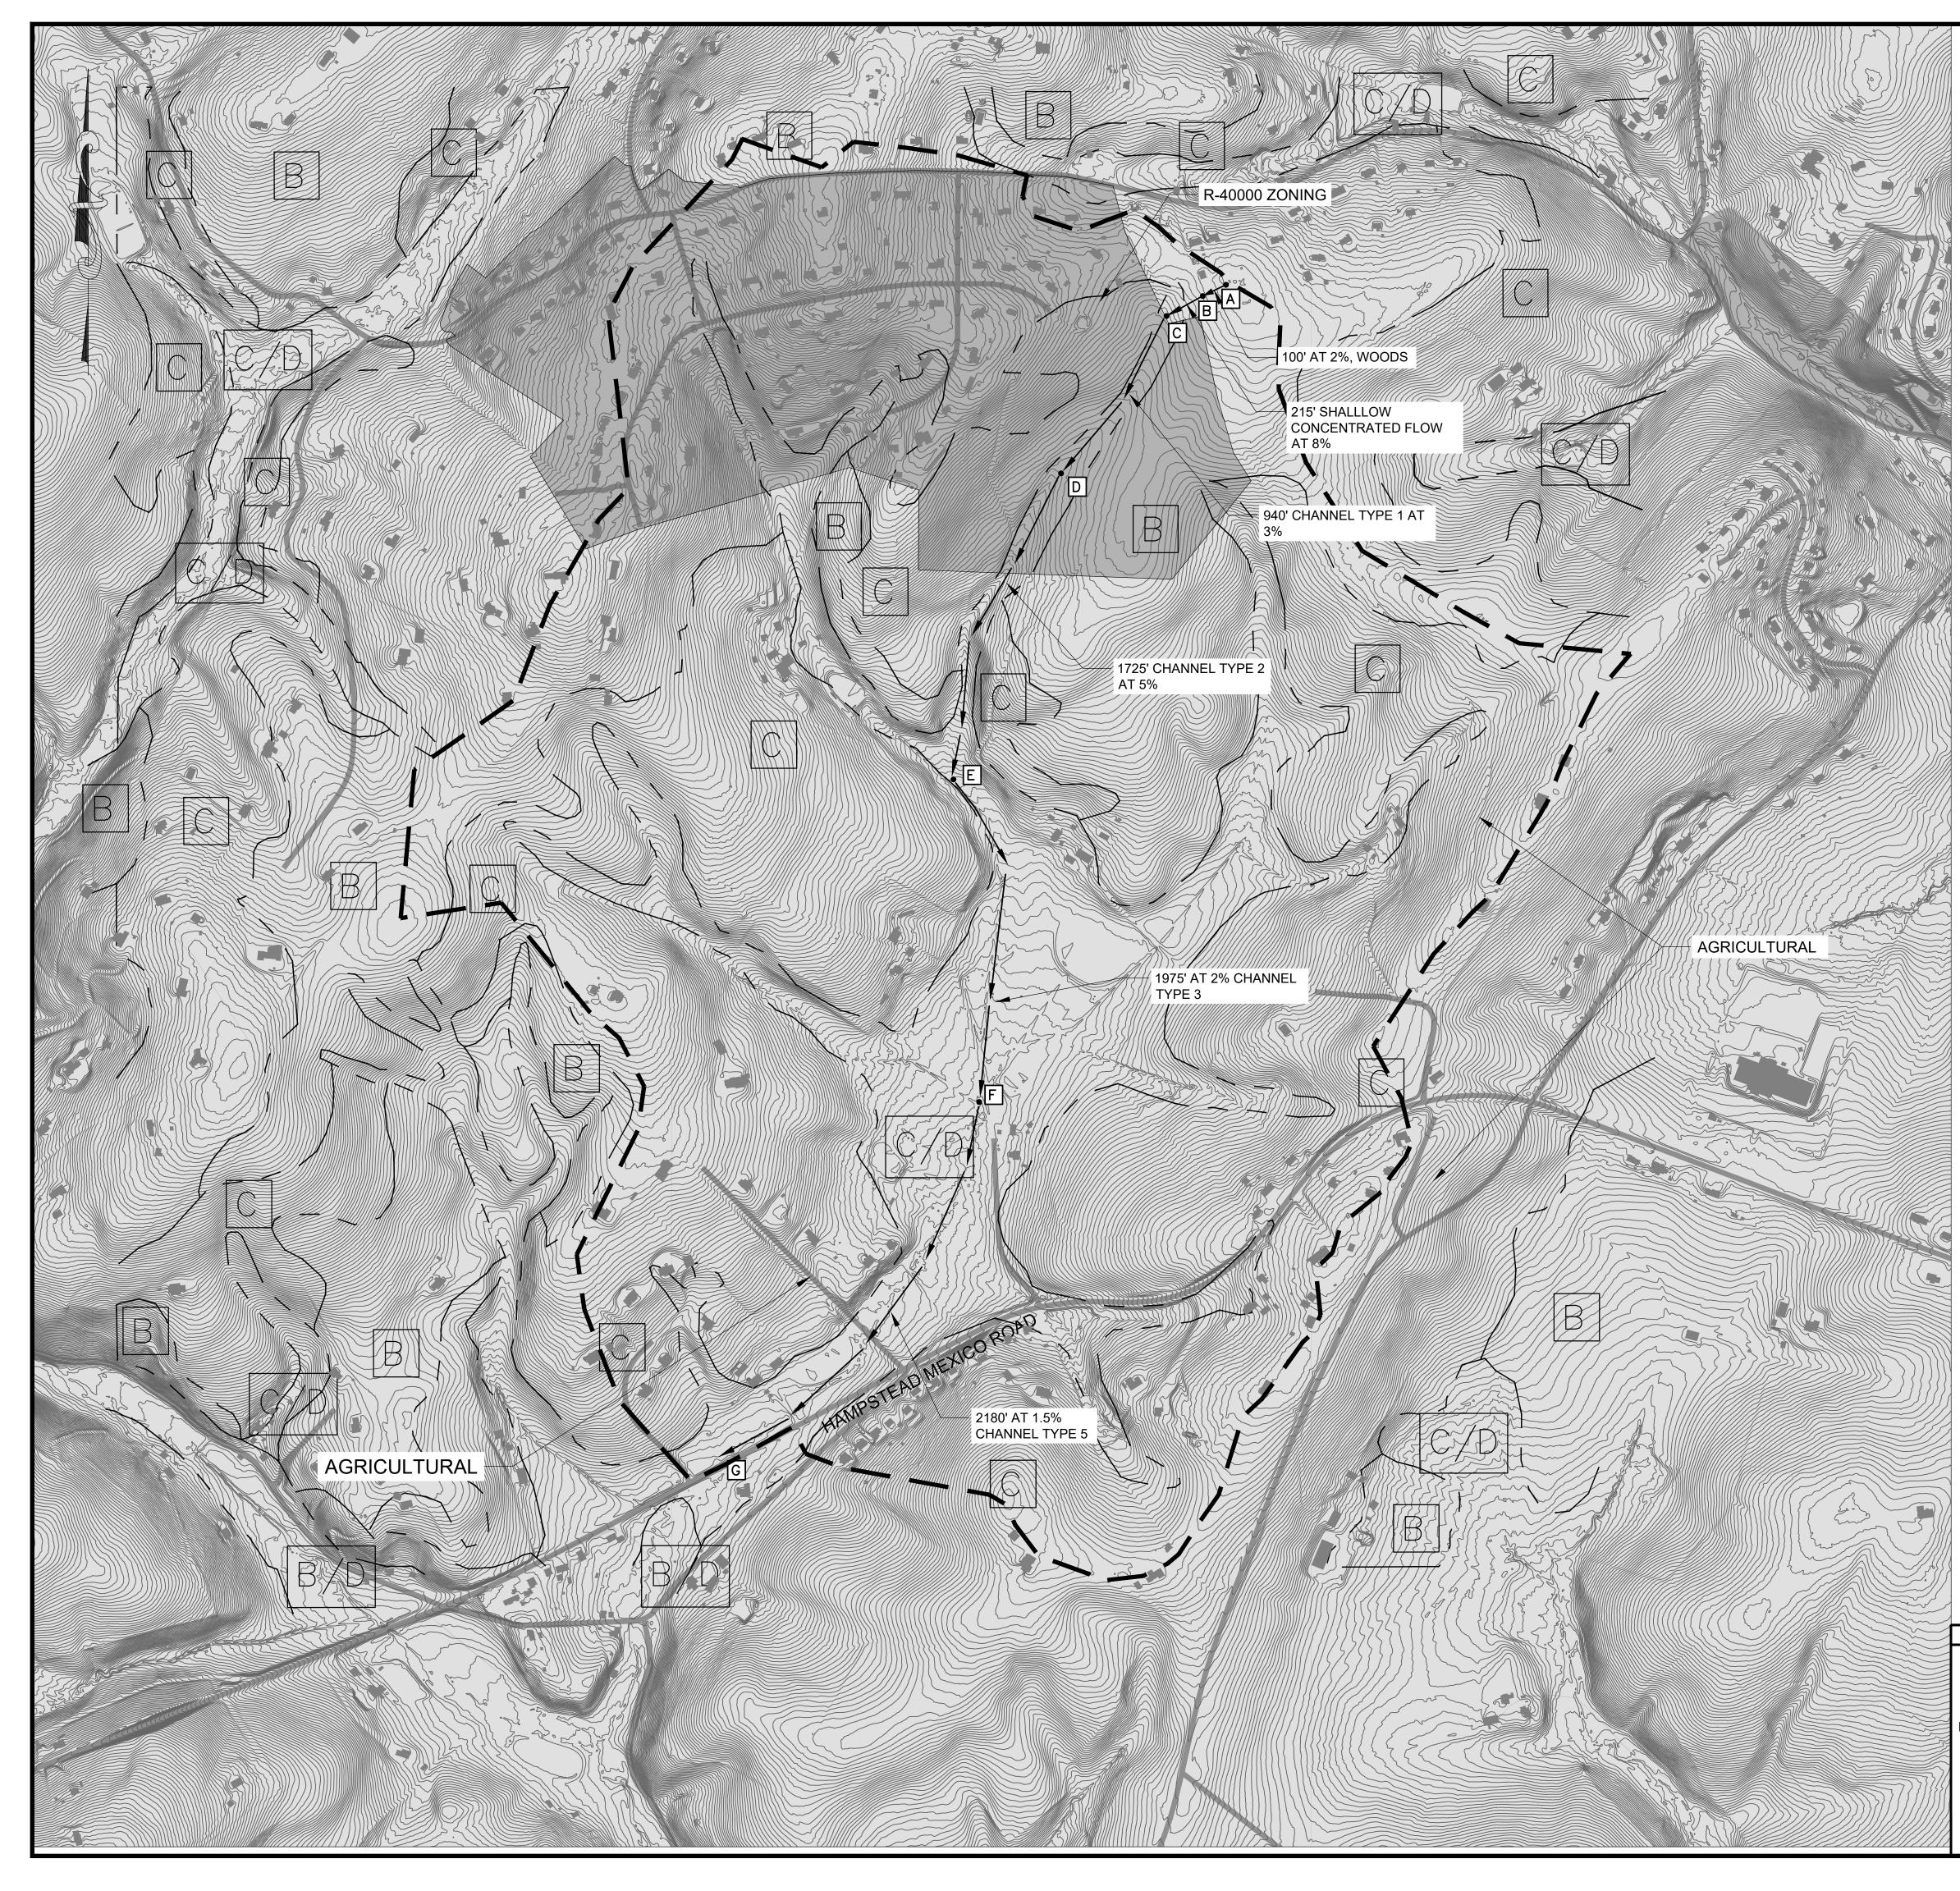

SOILS LEGEND							
SYMBOL	NAME/DESCRIPTION	SOIL GROUP	ACRES IN AOI	PERCENT IN AOI			
GbD	GAILA CHANNERY LOAM, 15 TO 25 PERCENT SLOPES	В	2.8	0.2%			
GdB	GLENELG LOAM, 3 TO 8 PERCENT SLOPES	В	126.7	9.7%			
GdC	GLENELG LOAM, 8 TO 15 PERCENT SLOPES	В	22.2	1.7%			
GeB	GLENELG CHANNERY LOAM, 3 TO 8 PERCENT SLOPES	В	42.8	3.3%			
GeC	GLENELG CHANNERY LOAM, 8 TO 15 PERCENT SLOPES	В	90.7	6.9%			
GfC	GLENELG-URBAN LAND COMPLEX, 8 TO 15 PERCENT SLOPES	В	15.0	1.1%			
MaB	MANOR LOAM, 3 TO 8 PERCENT SLOPES	В	39.8	3.0%			
MaC	MANOR LOAM, 8 TO 15 PERCENT SLOPES	В	76.2	5.8%			
MaD	MANOR LOAM, 15 TO 25 PERCENT SLOPES	В	35.6	2.7%			
MaF	MANOR LOAM, 25 TO 45 PERCENT SLOPES	В	4.3	0.3%			
MbC	MANOR CHANNERY LOAM, 8 TO 15 PERCENT SLOPES	В	18.0	1.4%			
MbD	MANOR CHANNERY LOAM, 15 TO 25 PERCENT SLOPES	В	1.8	0.1%			
McD	MANOR-BRINKLOW COMPLEX, 15 TO 25 PERCENT SLOPES, VERY ROCKY	В	3.1	0.2%			
McF	MANOR-BRINKLOW COMPLEX, 45 TO 65 PERCENT SLOPES, VERY ROCKY	В	4.2	0.3%			
BrB	BRINKLOW CHANNERY LOAM, 3 TO 8 PERCENT SLOPES	С	107.5	8.2%			
BrC	BRINKLOW CHANNERY LOAM, 8 TO 15 PERCENT SLOPES	С	352.4	27.2%			
BrD	BRINKLOW CHANNERY LOAM, 15 TO 25 PERCENT SLOPES	С	123.6	9.5%			
BrE	BRINKLOW CHANNERY LOAM, 25 TO 45 PERCENT SLOPES	С	6.9	0.5%			
НаА	HATBORO SILT LOAM, O TO 3 PERCENT SLOPES	B/D	11.6	0.9%			
BaA	BAILE SILT LOAM, O TO 3 PERCENT SLOPES	C/D	86.6	6.6%			
BaB	BAILE SILT LOAM, 3 TO 8 PERCENT SLOPES	C/D	41.0	3.1%			
GhB	GLENVILLE SILT LOAM, 3 TO 8 PERCENT SLOPES	C/D	73.8	5.6%			
GhC	GLENVILLE SILT LOAM, SOMEWHAT POORLY DRAIN 8 TO 15 PERCENT SLOPES	C/D	17.9	1.4%			

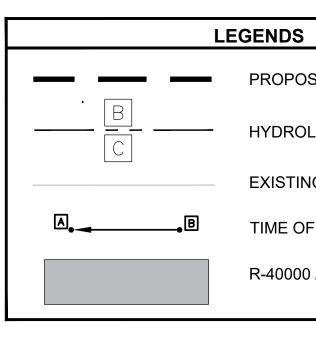


PROPOSED DRAINAGE AREA	
HYDROLOGIC SOIL BOUNDARY	
EXISTING CONTOUR	
TIME OF CONCENTRATION	
R-40000 ZONING AREA	

GRAPHIC SCALE

	SL	JMMARY	
DRAINAGE AREA (AC)	RCN	Tc (HOURS)	100 YEAR PEAK DISCHARGE (cfs)
615	73	1.65	1200

			( IN FEET ) 1 inch = 400 ft.	
	8th EL:	EXISTING DRAIN COWABUN 2202 HAMPSTEA	<b>NGA FARN</b> D MEXICO ROAD CARROLL C	
OWNER/ DEVELOPER	DATE F	REVISIONS BY		
Richard Sobbott and Brenda Sobbott 2202 Hampstead Mexico Road	Surveyed By DCI Computed By RLS	PROFESSIONAL CERTIFICATION: IHEREBY CERTIFY THAT THESE DOCUMENTS WERE PREPARED OR APPROVED BY ME, AND THAT I AM A DULY LICENSED PROFESSIONAL ENGINEER UNDER THE LAWN OF THE STATE OF MARYLAND, LICENSE NO. 15222, EXPIRATION DATE: 14/2027	2202 Hampsto Westminster,	bbott, PE, RLS ead Mexico Road Maryland 21157 10-300-6350)
Westminster, MD 21157 Phone: 410 - 300 - 6530	Drawn By HP Checked By	- Luchard and	Date: 05/05/2025	Scale: 1" = 400'
	RLS Drawing No.	CONAL CONTRACTOR	SHEET NO.	3 OF 9
	XX-XXX-XXX	2/22/2025 DATE	S-25-0	008

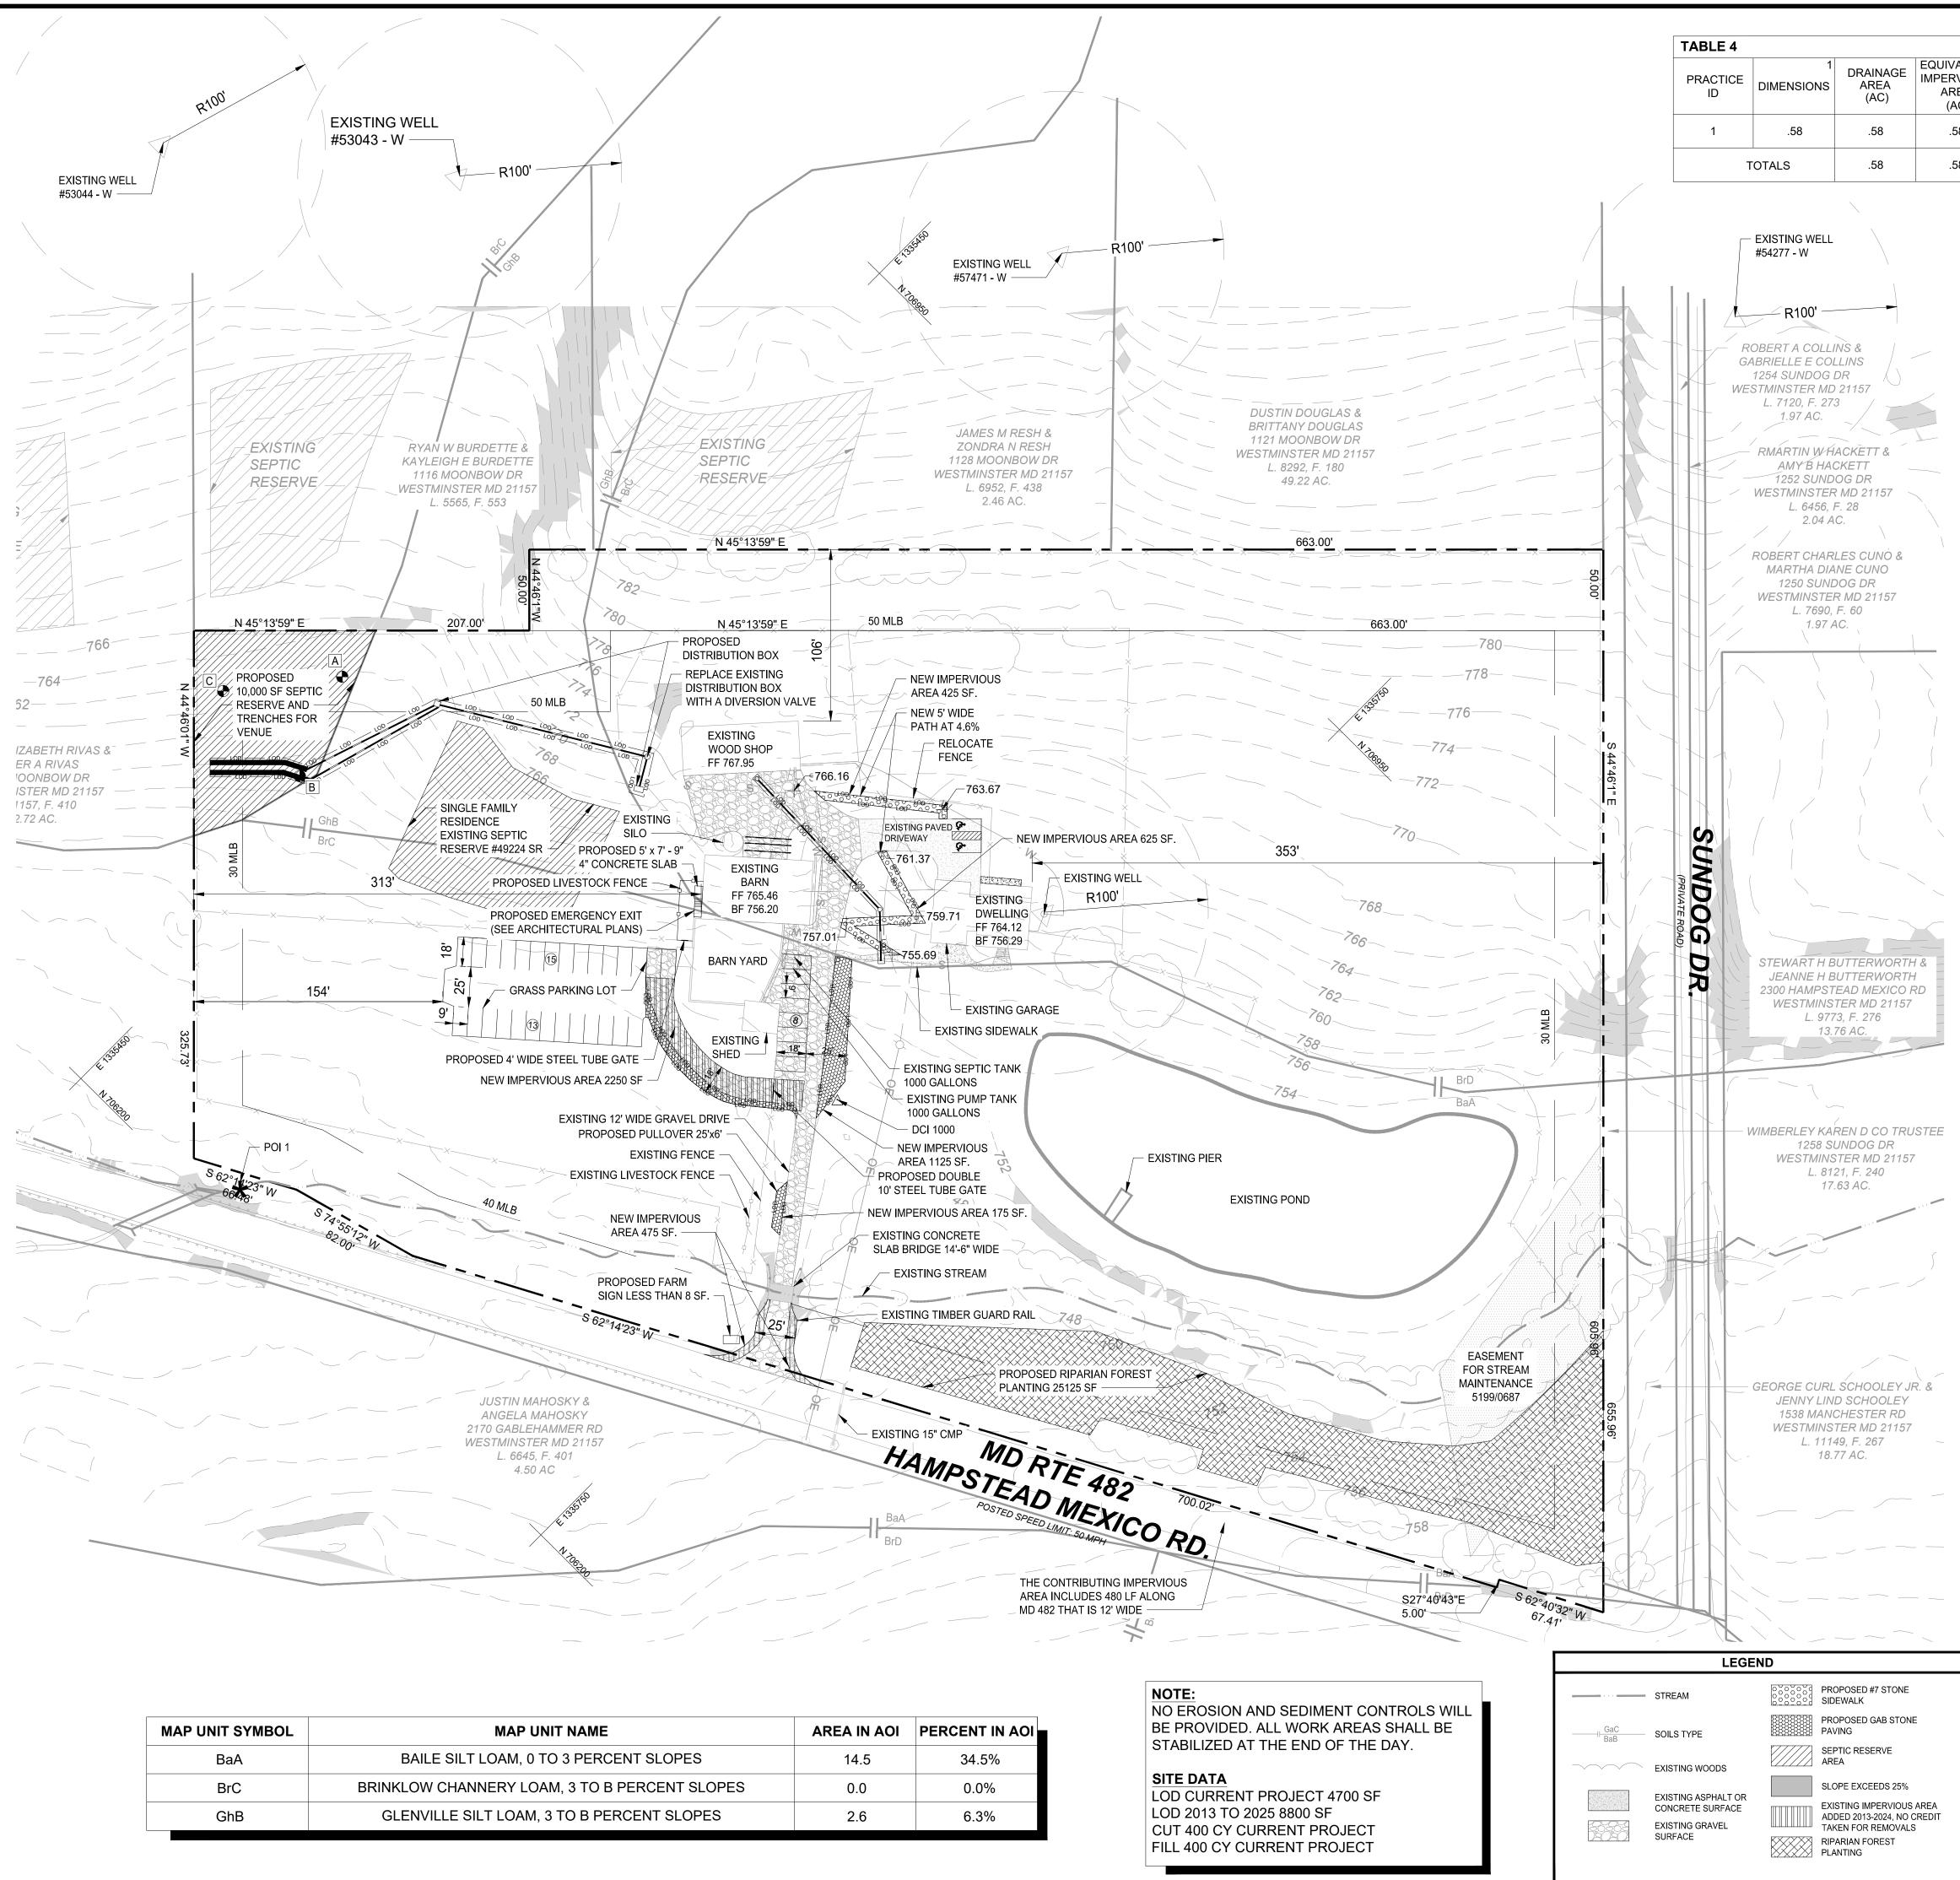

	FACILITY DESIGN SUMMARY TABLE								
ALENT VIOUS EA .C)	ESDv 2 VOLUME REQUIRED, (cf)	STORAGE <sup>3</sup> VOLUME PROVIDED, ESD, (cf)	TREATMENT 4 VOLUME CREDITED, ESD, (cf)	RECHARGE 5 VOLUME PROVIDED, (cf)	TARGET <sup>6</sup> PE (in)	PE PROVIDED (in)	FOR 10-&100-YEAR QUANTITY CONTROL? (Y/N)	NOTES	
58	2984	2984	2984	2984	1.5	1.5		RIPARIAN FOREST PLANTING	
58	2984	2984	2984	2984					

NOTES: PE (EIAR) VALUES ARE DERIVED FROM ACCOUNTING FOR STORMWATER WASTELOAD ALLOCATIONS AND IMPERVIOUS ACRES TREATED: GUIDANCE FOR NPDES

STORMWATER PERMITS, DATED 12/21, BY THE MARYLAND DEPARTMENT OF ENVIRONMENT. REFER TO TABLE 11 PE=1.5 FOR RIPARIAN FOREST PLANTING ESDV REQUIRED BASED ON IMPERVIOUS AREA 0.12 AC (5225 SF) PERCENT IMPERVIOUS OF 100%, Rv = 0.95 AND Pe OF 2.2 (C SOIL)

 $ESD_v = (P_E * R_v A)/12$ 

I = IMPERVIOUS AREA /DRAINAGE AREA  $P_{E} = ESD_{V}^{*}12/R_{V}^{*}A$ 

R<sub>v</sub>=0.05+0.009\*1

Re<sub>v</sub>=(S\*R<sub>v</sub>\*A)/12 S = SOIL SPECIFIC RECHARGE FACTOR 0.13 B SOIL

	TABLE 3		UNI			
	REQUIREMENT	VOLUME REQUIRED (CF)	VOLUME PROVIDED (CF)	EXISTING DISCHARGE (CFS)	PROPOSED DISCHARGE (CFS)	NOTES
P O	Q10 (POI 1)	N/A	N/A	87.87	87.87	NO INCREASE IN Q10 ANTICIPATED
l 1	Q100 (POI 1)	N/A	N/A	213.66	213.66	NO INCREASE IN Q100 ANTICIPATED

\*5225 OF GRASS IS CONVERTED TO IMPERVIOUS AREA AND 25125 SF OF MEADOW IN CONVERTED TO WOODS. THE WEIGHT PRE-CONSTRUCTION RCN FOR THESE TWO AREAS ON C SOIL IS XX AND THE WEIGHTED POST - CONSTRUCTION RCN IS XX SO THERE IS NO INCREASE IN THE RCN. IF THERE IS NO CHARGE IN THE RCN THERE IS NO AFFECT ON Qp AND Qf.

TABL	E 2	SITE ESDv & Rev REQUIREMENTS			
	REQ. (cf)	PRO. (cf)	NOTES		
ESDv	910	2984			
Rev	113	2984			

TABLE	1 SITE IMPERVIOUS AREA REQUIRING TREATMENT (IART)	SF	AC 1
А	TOTAL LIMIT OF DISTURBANCE (LOD) <sup>2</sup>	8800	0.20
В	LIMIT OF DISTURBANCE AREA EXCLUDED FROM SSA <sup>3</sup>	3575	0.08
С	STORMWATER STUDY AREA (SSA) = $(A - B)^4$	5225	0.12
D	EX. IMP. AREA TREATED BY EXISTING WATER QUALITY FACILITY IMPACTED BY WORK	0	0
Е	EXISTING IMPERVIOUS AREA WITHIN SSA	0	0
F	PROPOSED IMPERVIOUS AREA WITHIN SSA	5225	0.12
G	NEW IMPERVIOUS AREA = (F - E) IF REDEVELOPMENT, ELSE = F	5225	0.12
Н	REDEVELOPMENT IMPERVIOUS AREA = {0.5x(E-D)} IF REDEVELOPMENT, ELSE = 0	0	0
Ι	TOTAL IMPERVIOUS AREA TO TREAT {D + G + H}	5225	0.12
J	TOTAL IMPERVIOUS AREA TREATED BY SWM <sup>5</sup>	5760	0.13
К	VARIANCE/WAIVER - FEE-IN-LIEU PAID FOR UNTREATED IMPERVIOUS AREA	0	0
М	TOTAL IMPERVIOUS AREA ACCOUNTED (J + K)	5225	0.12

NOTES

1. ROUND ACRES TO NO MORE THAN 2 PLACES AFTER THE DECIMAL POINT.

WATERSHED NAME: PATAPSCO RIVER (021309)

 LOD AREA COVERS ALL EARTH DISTURBANCE ACTIVITIES. THE ACTUAL LOD ASSOCIATED WITH THIS PROJECT IS 4700 SF BUT THE COUNTY REQUESTED WE INCLUDE ALL EARTH DISTURBANCE BETWEEN 2013 AND 2025 THAT INCREASED THE IMPERVIOUS AREA. SO UNDER THIS CRITERIA THE LOD IS 8800 SF. THE LOD ASSOCIATED WITH ANY IMPERVIOUS AREA REMOVALS WAS NOT TRACKED SINCE THE IMPERVIOUS AREA IS LESS THAN 40% OF THE SITE AND NO REMOVAL CREDIT IS ALLOWED.
 INCLUDES AREAS RETURNED TO EXISTING GROUND COVER ASSOCIATED WITH UTILITY INSTALLATION ETC. SUBJECT TO


3. INCLUDES AREAS RETURNED TO EXISTING GROUND COVER ASSOCIATED WITH UTILITY INSTALLATION ETC. SUBJECT TO QUALITATIVE WAIVER.


4. SSA (STORMWATER STUDY AREA) IS THE AREA USED IN COMPUTING THE SWM REQUIREMENT. IT IS TYPICALLY SAME AS THE LOD, HOWEVER MAY BE REDUCED FROM THE LOD WHERE PORTIONS OF THE LOD ARE SUBJECT TO A WAIVER OF SWM REQUIREMENTS SUCH AS UTILITY CONNECTIONS OR TEMPORARY STOCKPILE AREAS. FOR THE PURPOSES OF THIS PROJECT THE SSA WAS SET EQUAL TO THE IMPERVIOUS AREA. THEREFORE THE PERCENT IMPERVIOUS IS 100% AND Rv IS 0.95. THIS SHORT CUT METHOD OF CALCULATING THE ESDv IS THE MOST CONSERVATIVE APPROACH FOR CALCULATING THE ESDv AS DETAILED TECHNICAL MEMORANDUM #10 (JULY 2018).

480 FT OF MD 482 DRAIN TO THE FOREST PLANTING AREA. THE CONTRIBUTING IMPERVIOUS AREA IS 12' LANE \* 480 = 5760 SF.

TREE PLANTING REQUIREMENTS					
AREA TO PLANTED (SF)	NUMBER OF TREES REQUIRED(100 TREES / AC)	NUMBER TREES PLATED WITHIN THE LAST 13 YEARS			
25125	58	80			

		STORMWATER PLAN COWABUNGA FARM 2202 HAMPSTEAD MEXICO ROAD				
		8th ELE	ECTION DISTRICT TAX MAP - 40	CARF GRID - 2	ROLL COUNTY, MARYLAND PARCEL - 527	
_	<b></b>	DATE R	REVISIONS BY			
	OWNER/ DEVELOPER					
	Richard Sobbott and Brenda Sobbott 2202 Hampstead Mexico Road	Surveyed By DCI Computed By RLS	PROFESSIONAL CERTIFICATION: I HEREBY CERTIFY THAT THESE DOCUMENTS WERE PREPARED OR APPROVED ME, AND THAT I AM A DULY LICENSED PROFESSIONAL ENGINEER UNDER THE LAWS OF THE STATE OF MARYLAND, LICENSE NO. 15222, EXPIRATION DATE: 14/2027	2202 West	chard Sobbott, PE, RLS Hampstead Mexico Road tminster, Maryland 21157 hone: (410-300-6350)	
	Westminster, MD 21157 Phone: 410 - 300 - 6530	Drawn By REZ Checked By	Lin Mart	Date: 5/15/2025	Scale: 1" = 50'	
		RLS Drawing No.	Content of the second s	SHEET NO.	4 OF 9	
	1 1	XX-XXX-XXX	5/15/2025 DATE		S-25-0008	

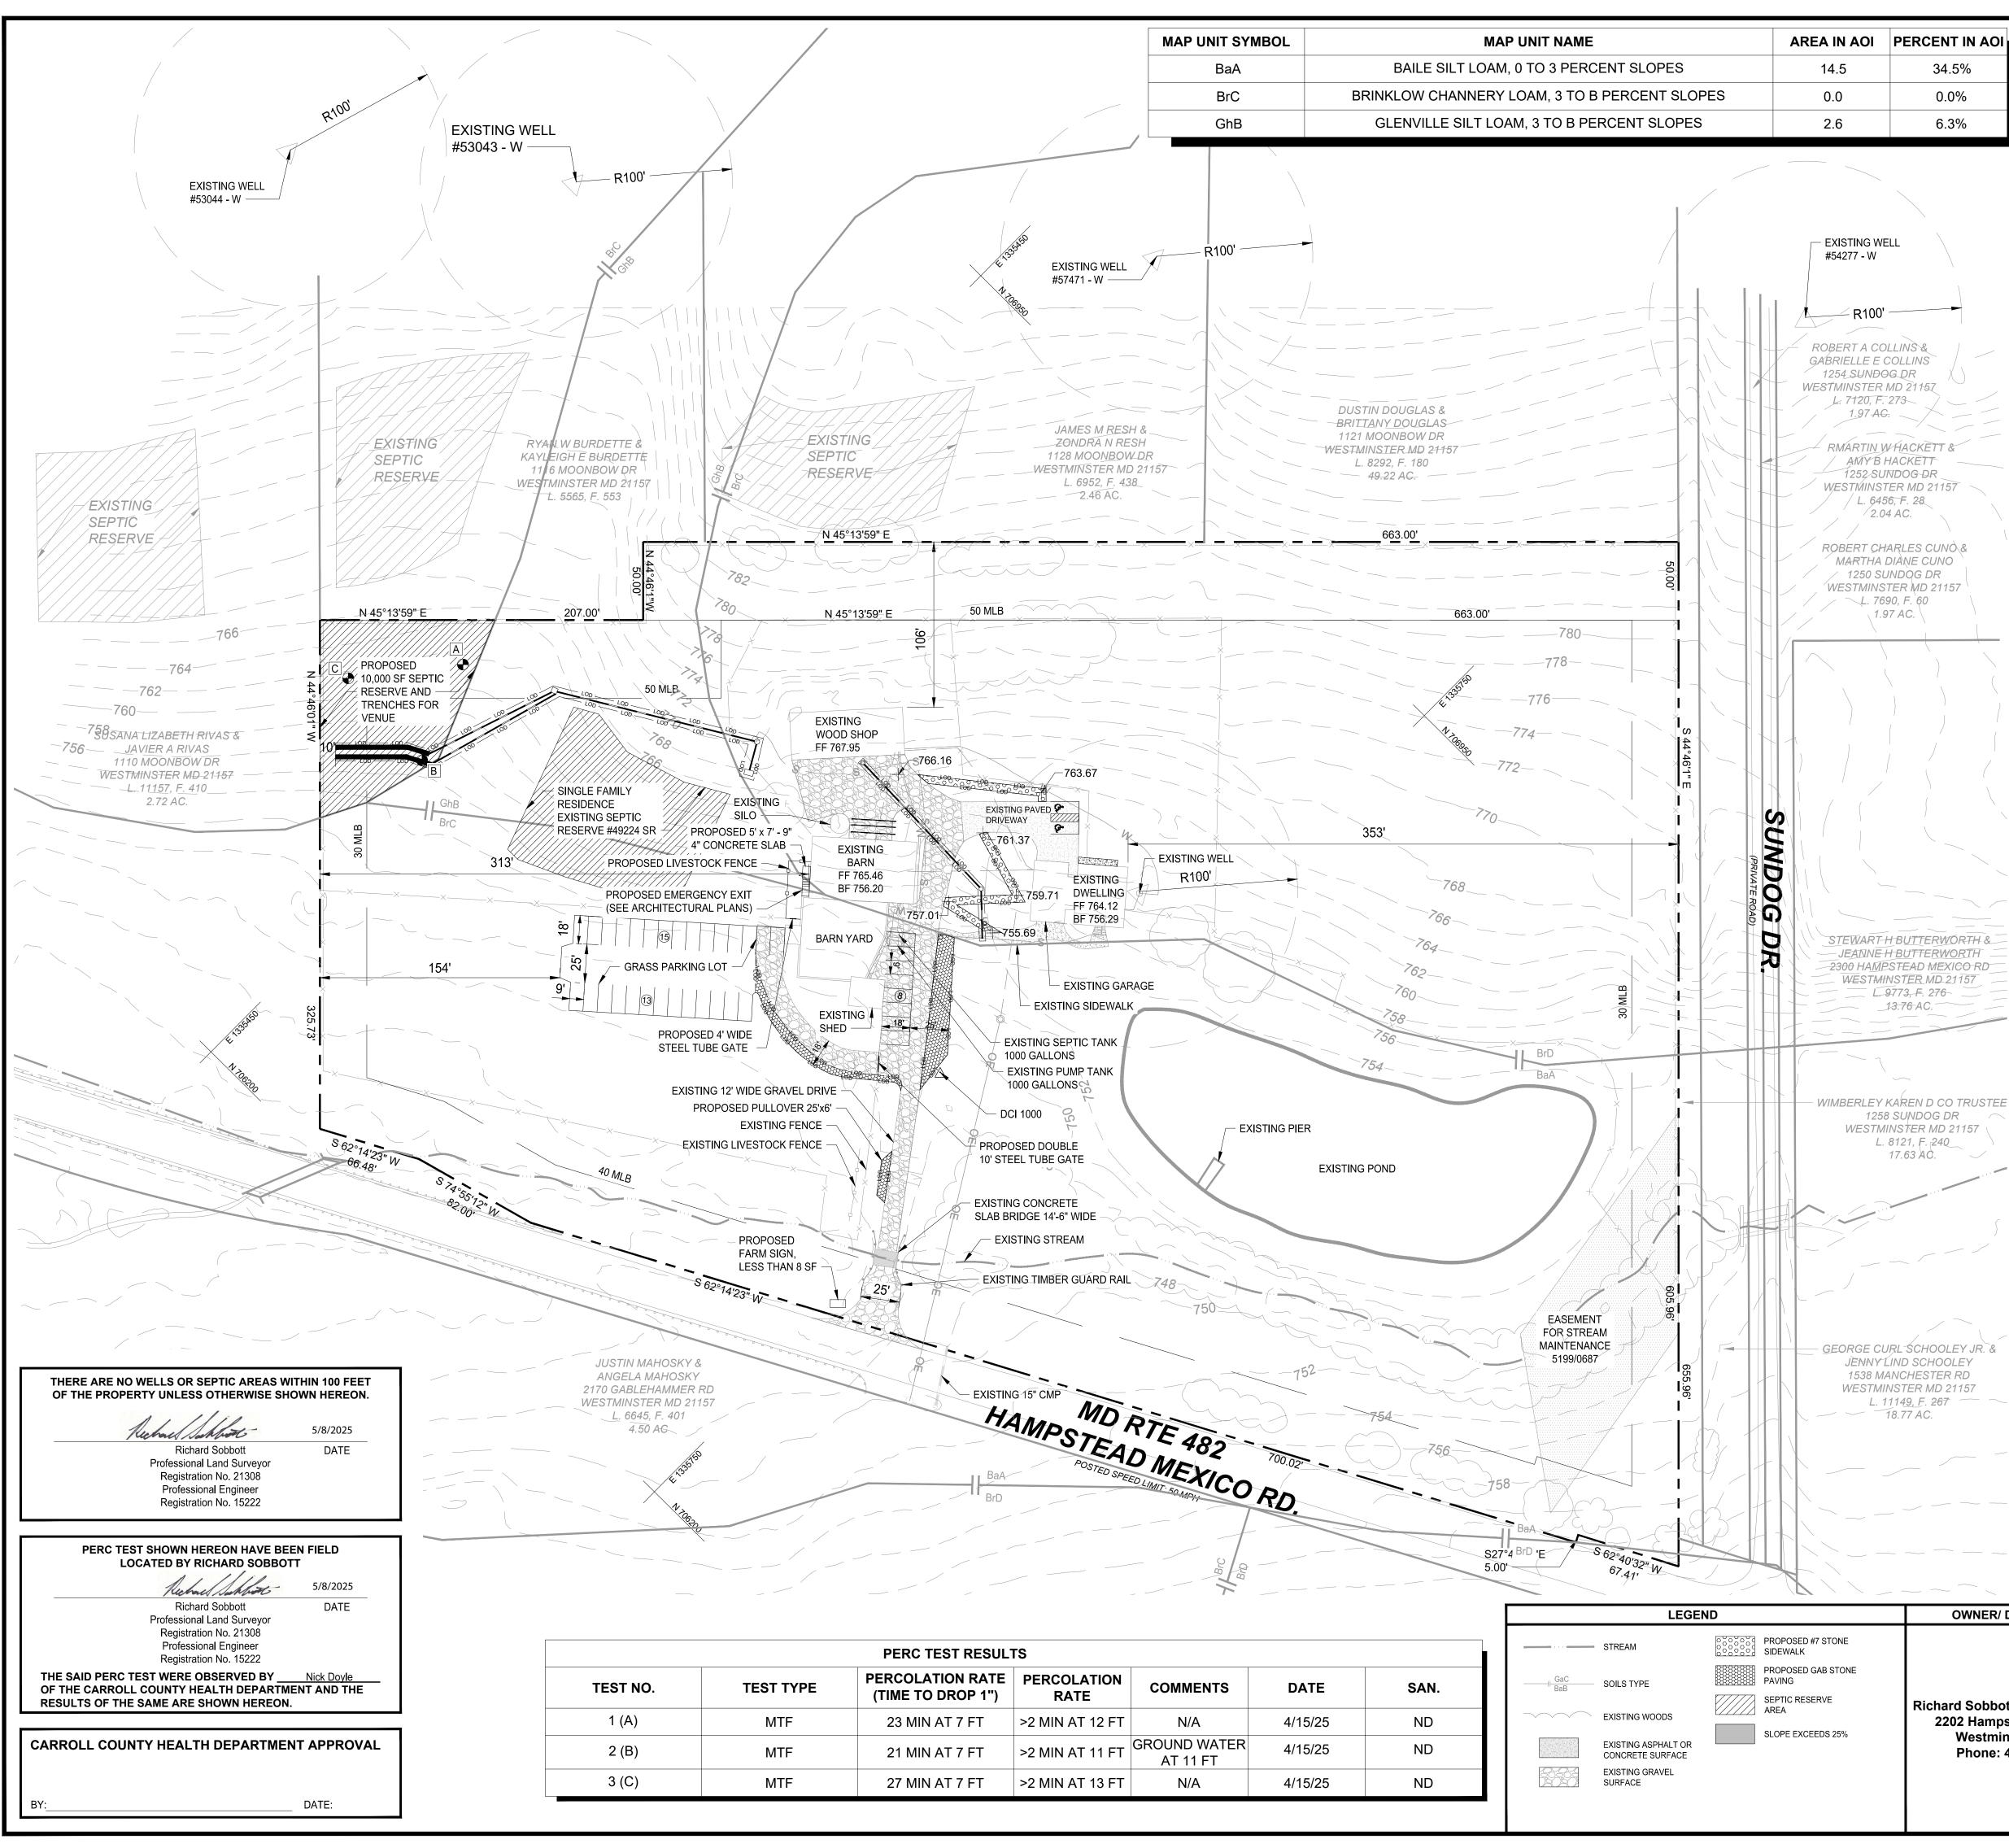

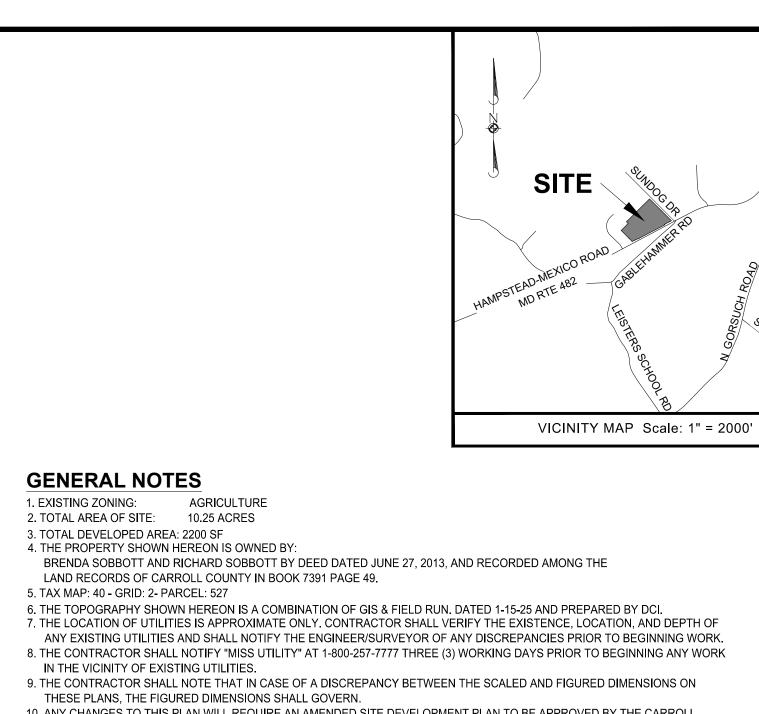

- 10. ANY CHANGES TO THIS PLAN WILL REQUIRE AN AMENDED SITE DEVELOPMENT PLAN TO BE APPROVED BY THE CARROLL COUNTY PLANNING AND ZONING COMMISSION 11. THIS SITE PLAN SHALL BECOME VOID EIGHTEEN MONTHS AFTER THE DATE OF THE APPROVAL IF NO BUILDING PERMIT OR
- ZONING CERTIFICATES HAS BEEN ISSUED FOR THIS PROJECT, UNLESS AN EXTENSION OF THIS TIME LIMIT IS ISSUED BY THE ZONING ADMINISTRATOR, OR AN APPOINTED DESIGNEE 12. LIMITS OF DISTURBANCE IS LESS THAN 40,000 SQ. FT; THEREFORE, EXEMPT FROM FOREST CONSERVATION.
- 13. BOARD OF ZONING APPEALS CASE NUMBER : # 6529, DATED NOVEMBER 14, 2024. \* THE BOARD APPROVED THE CONDITIONAL USE REQUESTED BY THE APPLICANT FOR A BANQUET FACILITY.
  - THE BOARD PUT A FEW CONDITIONS ON THE APPROVAL: 1. THE MUSIC END BY 10:00
    - 2. THE CAPACITY AT EVENTS MUST BE 100 PEOPLE OR LESS 3. A MAXIMUM OF TWELVE (12) EVENTS PER YEAR
- 14. THE COURSES AND COORDINATE SHOWN HEREON ARE REFERRED TO THE SYSTEM OF COORDINATES ESTABLISHED IN THE MARYLAND COORDINATE SYSTEM - NAD 83 (1991) AND ARE BASED UPON THE FOLLOWING NATIONAL SPATIAL REFERENCE

CONTROL STATIONS PROVID				
DESIGNATION	NORTH (sFT)	EAST (sFT)	ELEV.	
SHA CHR2	707477.247	1340392.121	831.267	
DCI 1000	706369.524	1335490.78	746.61	

- 15. THERE ARE EXISTING WETLANDS AND THEIR ASSOCIATED BUFFERS ON SITE. THESE WILL NOT BE IMPACTED BY THE PROPOSED DEVELOPMENT. 16. THE SITE IS OVER A 4,200' FROM THE NEAREST PRODUCTION WELL
- 17. NO CONSTRUCTION VEHICLES. CONTRACTOR OR PRIVATE. OR CONSTRUCTION MATERIALS OR EQUIPMENT MAY BE PARKED.
- PLACED OR STORED WITHIN ANY PUBLIC RIGHT OF WAY. 18. UNDERGROUND TANK NOTE: THERE ARE NO KNOWN UNDERGROUND TANKS, BUT IF ANY UNDERGROUND TANKS ARE ENCOUNTERED ON SITE DURING CONSTRUCTION. THE CONTRACTOR SHALL IMMEDIATELY NOTIFY THE MARYLAND DEPARTMENT OF THE ENVIRONMENT AND THE CARROL COUNTY BUREAU OF RESOURCE MANAGEMENT. THE CONTRACTOR SHALL REMOVE THE TANKS IN ACCORDANCE WITH MDE PROCEDURES
- 19. A SHA ACCESS PERMIT IS REQUIRED FOR THE MD 482 ENTRANCE CHANGE OF USE.

## **PERCOLATION TEST PLAN NOTES:**


34.5%

0.0%

6.3%


- 1. THERE ARE NO OTHER WELLS OR SEPTIC SYSTEMS WITHIN 100 FEET OF THE PROPERTY BOUNDARY OTHER THAN SHOWN.
- 2. IF GRAVITY FLOW TO SEWAGE DISPOSAL, AREA CANNOT BE ENSURED, A PUMPED SEWAGE DISPOSAL SYSTEM WILL BE REQUIRED.
- THIS SEPTIC RESERVE IS FOR A CHANGE OF USE FOR THE EXISTING BARN AND WOOD SHOP AS A SEASONAL BANQUET FACILITY FOR UP TO 100 PEOPLE TWELVE TIMES A YEAR. THE BARN HAS ONE MALE AND ONE FEMALE BATHROOMS AND THE WOOD SHOP AS ONE ADA ACCESSIBLE BATHROOM. THE EXISTING HOUSE SEPTIC RESERVE WAS DESIGNED FOR A 3 BEDROOM HOUSE. THE EXPECTED DESIGN FLOW FOR THE VENUE IS 5 GALLONS PER PERSON PER DAY OR 500 GALLONS PER DAY. THE DESIGN RESIDENTIAL FLOW FOR THE 3 BEDROOM WAS 150 GALLONS PER BEDROOM OR 450 GALLONS PER DAY. A 4" BULL RUN PVC DIVERSION VALVE LOCATED AS SHOWN WILL BE USED TO DIVERT FLOW TO THE NEW SEPTIC RESERVE DURING THE TWELVE BARN EVENTS. IT MUST BE DEMONSTRATED THAT THERE IS ADEQUATE AREA FOR AN INITIAL AND TWO REPLACEMENT SEPTIC SYSTEM IN ACCORDANCE WITH COMAR 26,04,02,04F (EFFECTIVE11/18/85). THE EXISTING 1000 GALLON SEPTIC TOP SEAM CONCRETE TANK AND 1000 GALLON PUMP TOP SEAM CONCRETE TANK WILL BE USED FOR BOTH THE RESIDENCE AND THE VENUE. THE BATHROOMS IN THE BARN ARE ALREADY CONNECTED TO THE SEPTIC TANK. THE NEW ADA BATHROOM IN THE WOOD SHOP WILL ALSO BE CONNECTED TO THE SEPTIC TANK SHOWN.
- A PERCOLATION TEST IS ONLY ONE OF THE CRITERIA USED IN CONSIDERING A LOT FOR INSTALLATION OF A SEPTIC SYSTEM. ADDITIONAL TESTING CAN BE REQUIRED AND MAY BE SUBJECT TO SCHEDULING DURING THE WET WEATHER PERIOD. THE ENTIRE LOT IS EVALUATED WHEN APPLICATION FOR A SEPTIC PERMIT IS MADE, ADJOINING PROPERTY HISTORY PERCOLATION TEST METHODOLOGY, ADJOINING WELLS AND SEPTIC SYSTEMS, PROPOSED NUMBER OF BEDROOMS, HISTORY OF FALLING SEPTIC SYSTEMS AND WELLS, DESIGN, SOIL AND GEOLOGICAL CONDITIONS, AND TOPOGRAPHY IN THE IMMEDIATE AREA ARE THEN USED TO DETERMINE IF THE LOT IS SUITABLE FOR THE UNDERGROUND DISPOSAL OF SEWAGE. ISSUANCE OF A SEPTIC SYSTEM PERMIT CONSTITUTE LOT APPROVAL BY THE HEALTH DEPARTMENT.

	PERK PLAN COWABUNGA FARM 2202 HAMPSTEAD MEXICO ROAD					
	8th EL	ECTION DISTRICT TAX MAP - 40			COUNTY, MARYLAND RCEL - 527	
OWNER/ DEVELOPER		REVISIONS	BY			
Richard Sobbott and Brenda Sobbott 2202 Hampstead Mexico Road	Surveyed By DCI Computed By RLS Drawn By	DCI         IHEREBY CERTIFY THAT THESE DOCUMENTS WER OR APPROVED BY ME, AND THAT I AM A DULY LICE PROFESSIONAL ENGINEET NUPER THE LAWS OF T MARYLAND, LICENSE NO. 15222, EXPRATION DATE           RLS         INTERVIEW		2202 Hamps Westminster	obbott, PE, RLS tead Mexico Road r, Maryland 21157 110-300-6350)	
Westminster, MD 21157 Phone: 410 - 300 - 6530	REZ Checked By	Lister Court		Date: 5/15/2025	Scale: 1" = 50'	
	RLS Drawing No.	Sonal English		SHEET NO.	5 OF 9	
	XX-XXX-XXX	5/15/2025 DATE	_	S-2	5-0008	

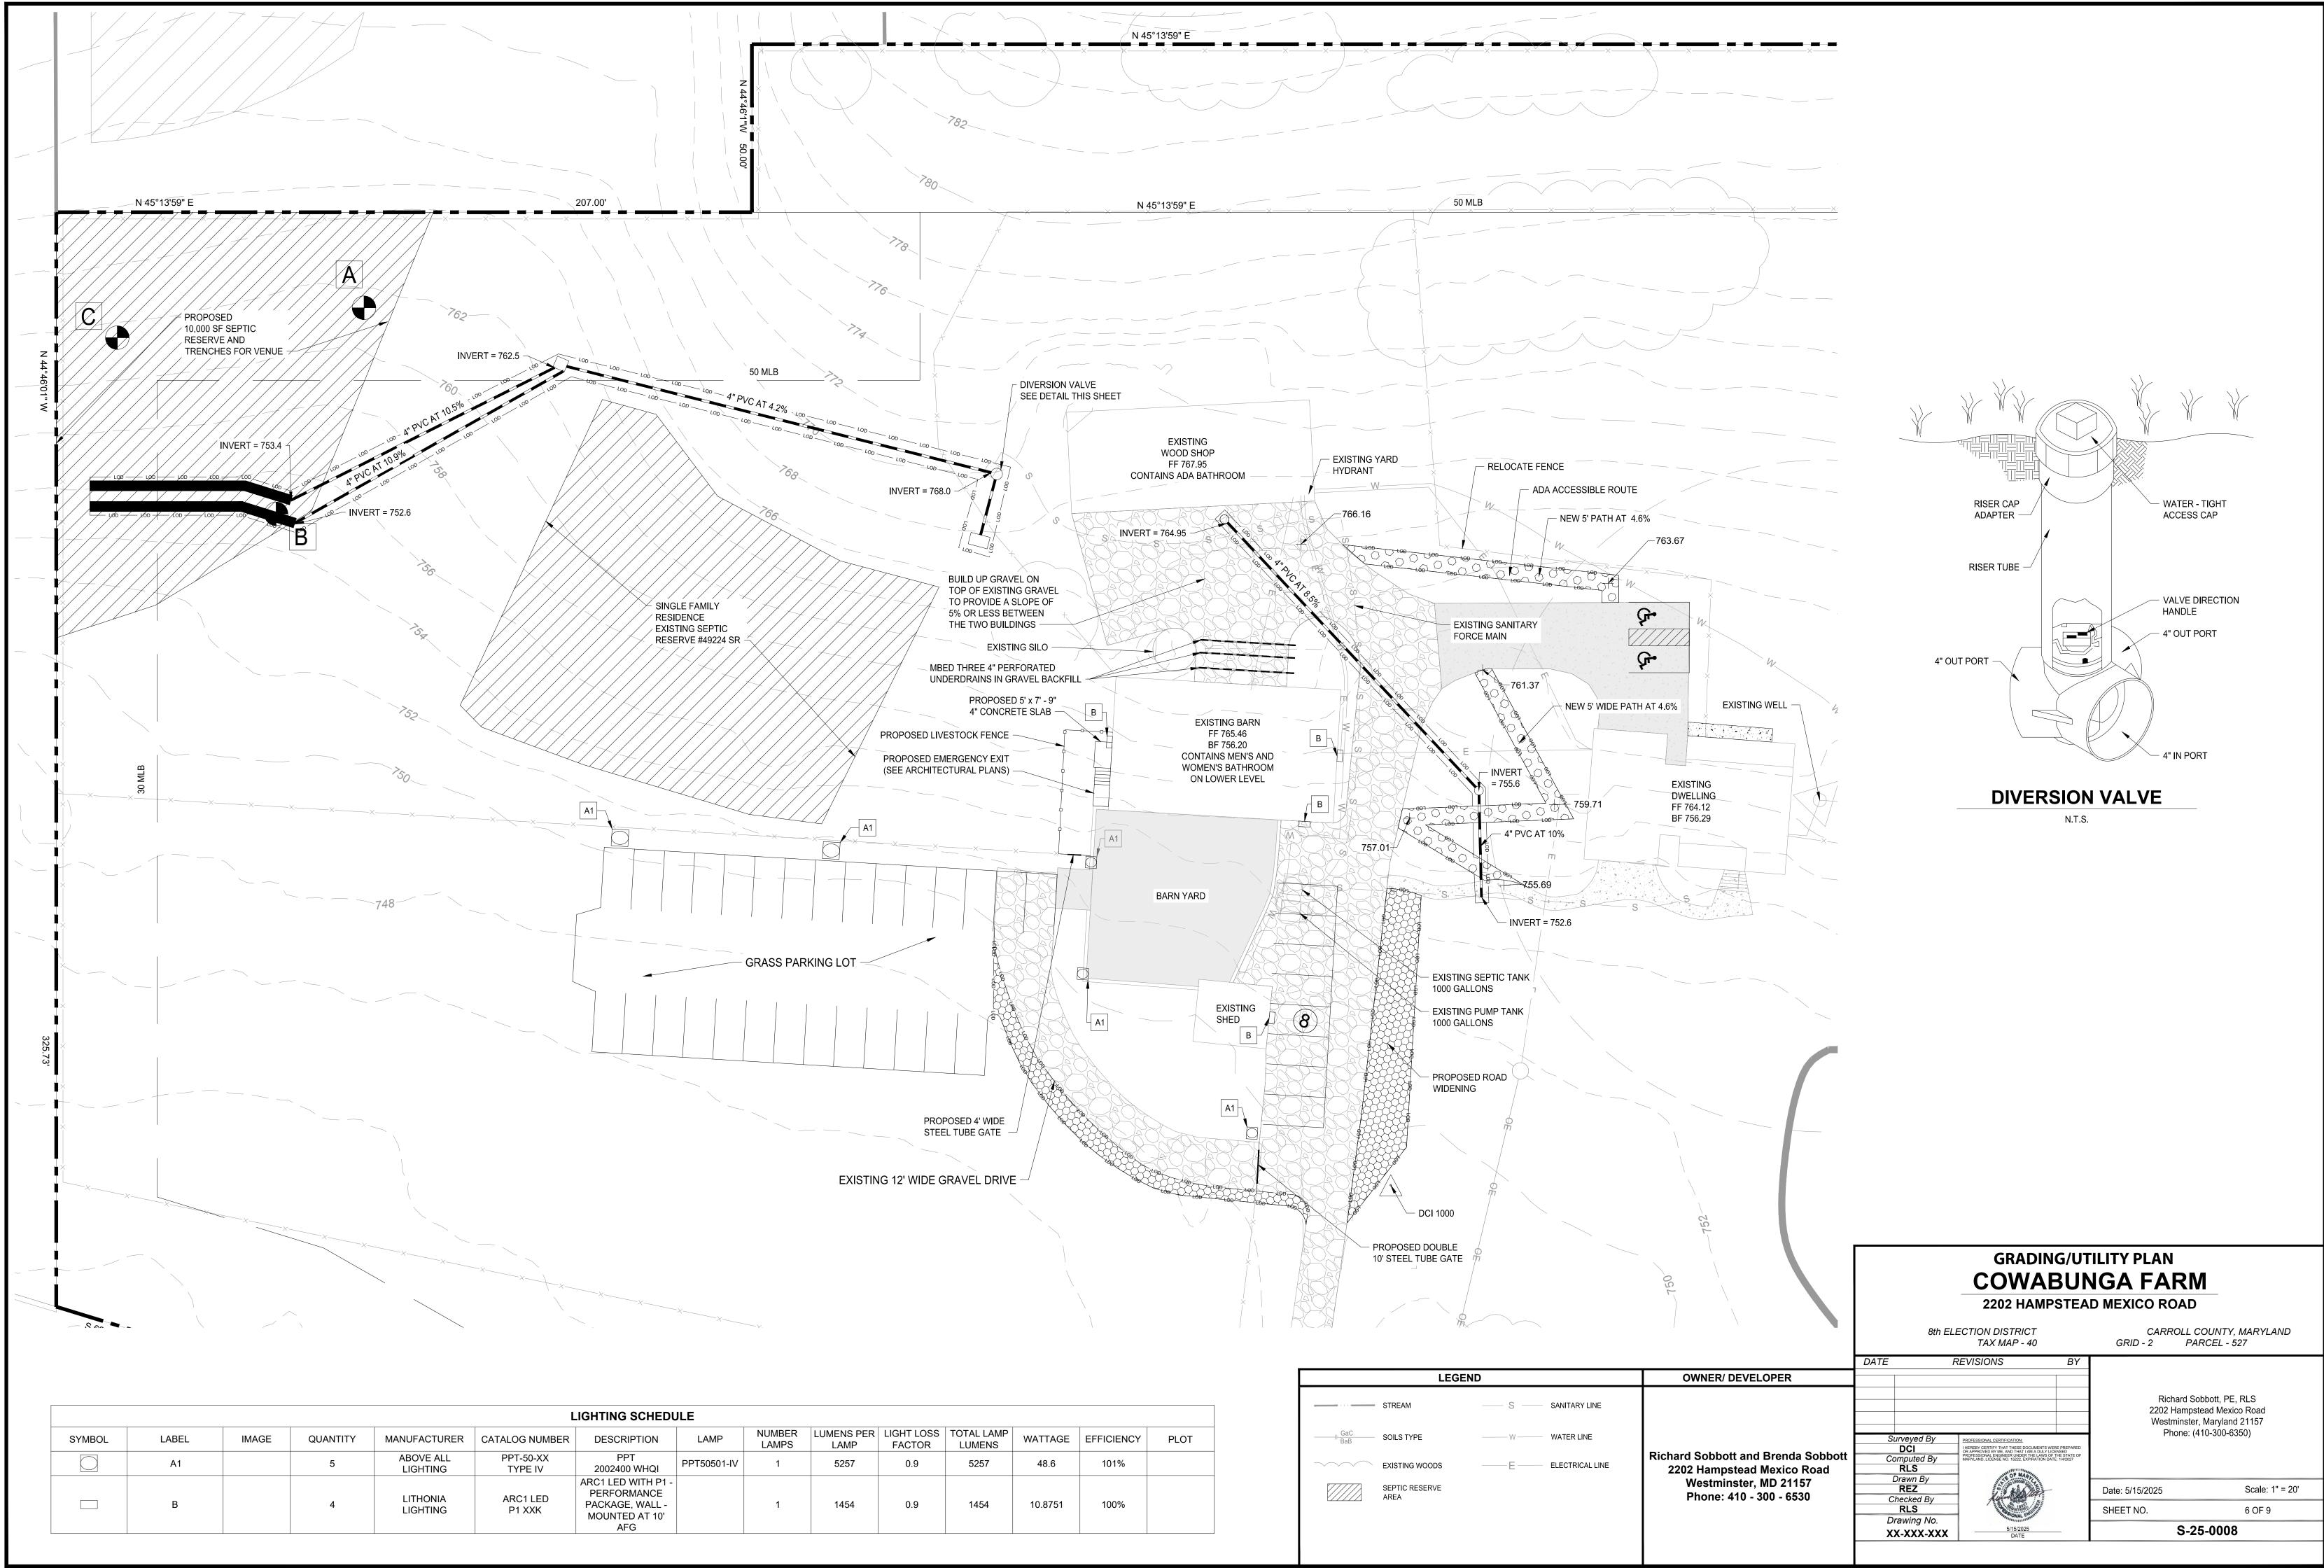


R S	LUMENS PER LAMP	LIGHT LOSS FACTOR	TOTAL LAMP LUMENS	WATTAGE	EFFICIENCY	PLOT
	5257	0.9	5257	48.6	101%	
	1454	0.9	1454	10.8751	100%	


	LEC	GEND		
	STREAM		s —	SANITARY LINE
GaC BaB	SOILS TYPE		- W	WATER LINE
$\overline{}$	EXISTING WOODS		E	ELECTRICAL LINE
	SEPTIC RESERVE AREA			

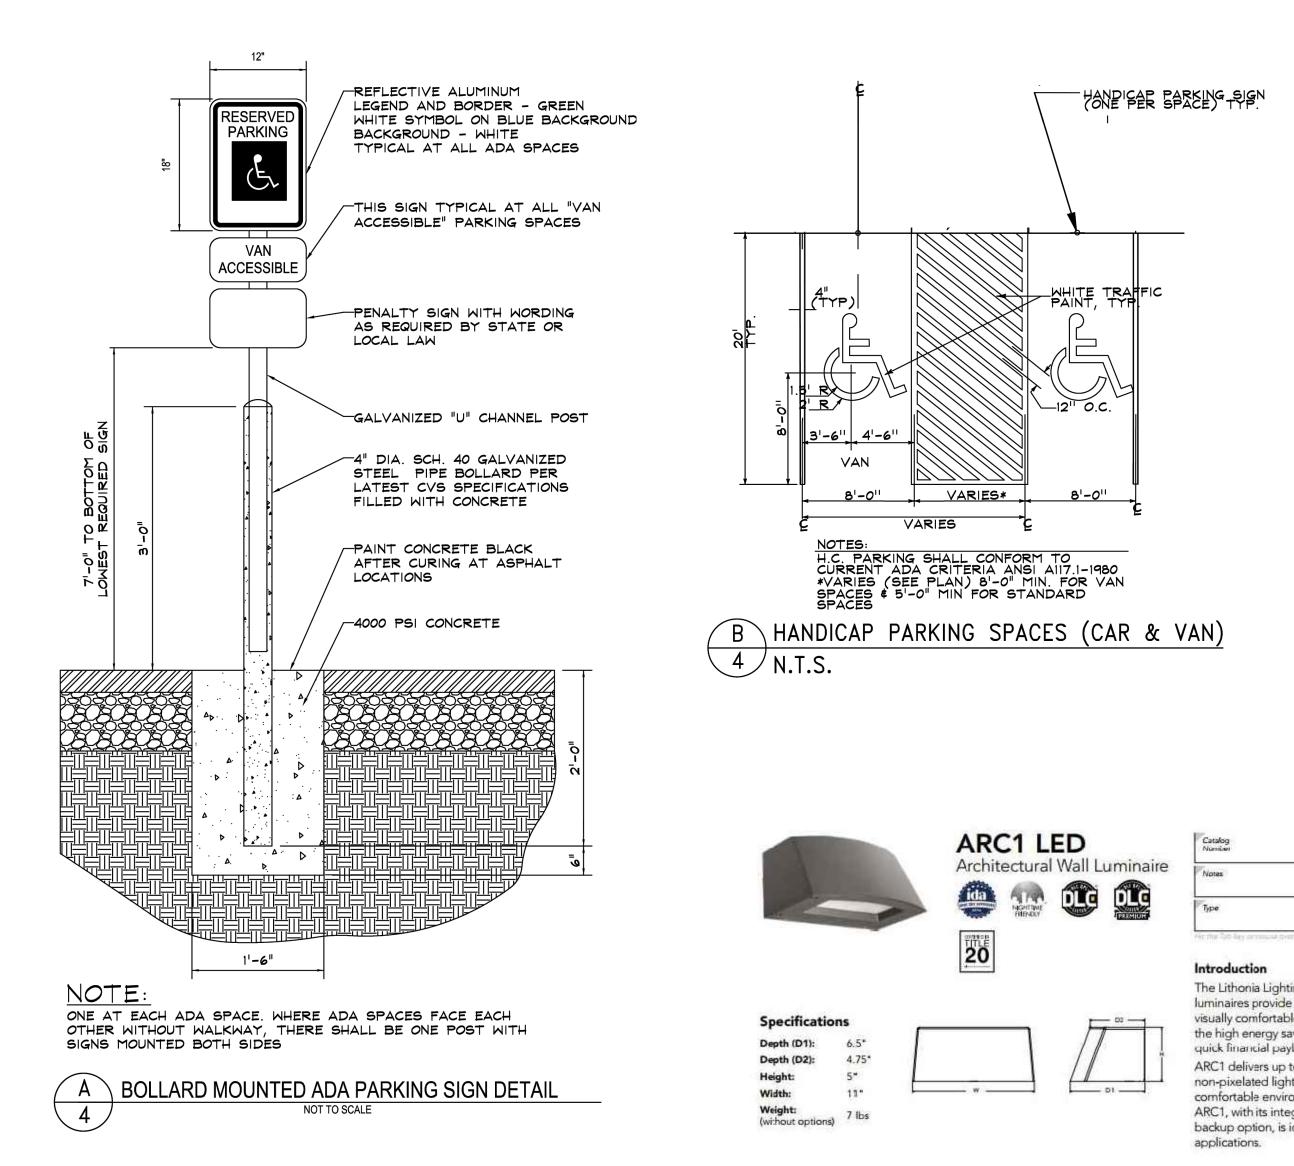

							200	
Limina	im Standard EM	inte Coldition, s	10°E	10	72	rroximate Lumens (Al 193		
ARCTLE	ED 4W			1,500	2,000	3,000	1	
ARCZ L	ED 4W	8W		1,500	2,000	3,000	4	000
Orderin	ng Information	Color Tringesature	Voltage	Options	EXA	MPLE: ARC1	LED P2 4	IOK MVOLT P
ARCILED	P1 1,500 Lumens P2 2,000 Lumens P3 3,000 Lumens	30K 30(0K 40K 4000K 50K 50(0K	MVDLT 3471	E4WH PE DMG SPD6KV FAD	Emergency battery backup, CEC con Batton type photocell for dusk-to-d 0-10V dimming wires pulled outsid an external contro, ordered separat 6kY surge protection Held adjustable light output device. Allows for easy adjustment to the de from 20% to 100% <sup>2</sup>	awn operation e fixture (Yor use with ely) <sup>2</sup>	DD8XD DBLXD DNAXD DWHKD DSSXD DD8TXD DBLBXD DBLBXD DNATXD DWHGXD DSSTXD	Dark beonze Black Natural aluminum White Sandstone Textured dark bronze Textured dark bronze Textured dark bronze Textured that Textured sandstone
	Accessories	w						NGTES 1 347V not availab

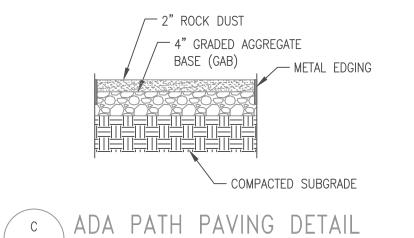


S-6 SCALE: N.T.S.

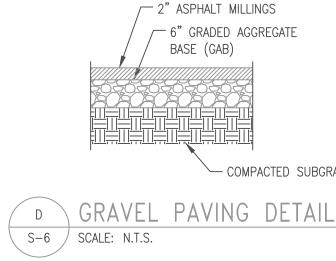

The Lithonia Lighting ARC LED wall-mounted luminaires provide both architectural styling and visually comfortable illumination while providing the high energy savings and low initial costs for quick financial payback.

ARC1 delivers up to 3,000 lumens with a soft, non-pixelated light source, creating a visually comfortable environment. The compact size of ARC1, with its integrated emergency battery backup option, is ideal for over-the-door

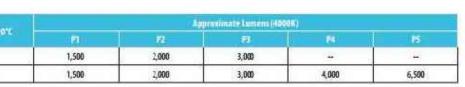

-----DDBXD

le with E4WH. e with DMG.

ARC1 LED

Rev. 03/02/22

**ABOVE ALL** 







Pavilion WITH Photocontrol Pavilion WITH Glass Frosted Lens

# PERFORMANCE DATA

LUMEN OUTPUT Lumen values are measured by third party certified laboratories performed in accordance with IESNA LM-79-08 as well as Lighting Facts listed.

		11430.000376.00303		12320 -	· · · · · · · · · · · · · · · · · · ·		Ceisius	Fanrennen
Nominal	Measured	Lumen	CRI	CCT	Dist.	LPW	0	32
Watts	Watts	Output		1010-0	Турс	Average	10	50
30W	29W	3250lm	>70	5000K	Type V	112	20	68
50W	50W	5750lm	>70	5000K	Type V	115	25	77
75W	76W	8740lm	>70	5000K	Type V	115	30	86
	2.121	10221			1100		40	104

# **B**UG Rating

Performed to IESNA LM-79-08 standards by a NVLAP accredited laboratory

Model	BUG Rating	Model	BUG Rating	Model	I
PPT30301-II	B1-U0-G1	PPT50301-II	B2-U2-G1	PPT75301-II	1
PPT30301-III	B1-U1-G1	PPT50301-III	B1-U2-G1	PPT75301-III	1
PPT30301-IV	B1-U0-G1	PPT50301-IV	B2-U0-G1	PPT75301-IV	1
PPT30301-V	B2-U0-G0	PPT50301-V	B2-U2-G2	PPT75301-V	1
PPT30401-II	B1-U2-G1	PPT50401-II	B2-U2-G1	PPT75401-II	1
PPT30401-III	B1-U2-G1	PPT50401-III	B1-U2-G1	PPT75401-III	1
PPT30401-IV	B1-U2-G1	PPT50401-IV	B2-U2-G1	PPT75401-IV	- A
PPT30401-V	B1-U2-G1	PPT50401-V	B2-U2-G2	PPT75401-V	1
PPT30501-II	B1-U2-G1	PPT50501-II	B2-U2-G2	PPT75501-II	
PPT30501-III	B1-U2-G1	PPT50501-III	B1-U2-G1	PPT75501-III	1
PPT30501-IV	B1-U0-G1	PPT50501-IV	B2-U2-G1	PPT75501-IV	3
PPT30501-V	B2-U2-G1	PPT50501-V	B2-U2-G2	PPT75501-V	1

# Warranty

Five year limited warranty. Full warranty terms located at www.aboveallLighting.com/warrantystatements

Specifications subject to change without notice.

1501 Industrial Way N,	865-222-8866
Toms River, NJ 08755	info@abovealligt
SODAD ADOLET ALL Lighting Inc. All simple concerned	A barrier will be

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Ambient Celsius

	A PRIMINAL	a musiculturente	
N	0	32	
nge	10	50	
12	20	68	
15	25	77	
E	30	86	

Dist.	LPW	0
type	Average	10
Type V	112	20
Type V	115	25
Type V	115	30
102.01		40
		-

Model	BUG Rating
PPT75301-II	B2-U3-G2
PPT75301-III	B2-U3-G1
PPT75301-IV	B2-U0-G2
PPT75301-V	B3-U3-G3
PPT75401-II	B2-U3-G2
PPT75401-III	B2-U3-G1
PPT75401-IV	B2-U3-G2
PPT75401-V	B2-U3-G2
PPT75501-II	B2-U3-G2
PPT75501-III	B2-U3-G1
PPT75501-IV	B2-U3-G2
PPT75501-V	B3-U3-G1

COMPACTED SUBGRADE


Pavilion WITH Wall Mount Bracket Lumen Ambient Temperature (LAT) Multipliers Use these factors to determine relative lumen output for average ambient temperature from -40-104°F (-40-40°C). Fahrenheit Multiplier 1.02 1.01 1.00

1.00 1.00 0.99

**BUG Rating** B2-U3-G2

B2-U3-G1 B2-U0-G2 B3-U3-G3 B2-U3-G2 B2-U3-G1 B2-U3-G2 B2-U3-G2 B2-U3-G2 B2-U3-G1 B2-U3-G2

	COWAE	BUN	ETAILS IGA FAF D MEXICO RO/	
8th EL	ECTION DISTRICT TAX MAP - 40		CARRO GRID - 2	LL COUNTY, MARYLAND PARCEL - 527
DATE F	REVISIONS	BY		
				rd Sobbott, PE, RLS
				mpstead Mexico Road nster, Maryland 21157
				ne: (410-300-6350)
Surveyed By DCI	PROFESSIONAL CERTIFICATION:			
Computed By	I HEREBY CERTIFY THAT THESE DOCUMENTS WERE OR APPROVED BY ME, AND THAT I AM A DULY LICET PROFESSIONAL ENGINEER UNDER THE LAWS OF TI MARYLAND, LICENSE NO. 15222, EXPIRATION DATE:	HE STATE OF		
RLS				
Drawn By	STATE CECOURS			
WAC Checked By	1. Aller		Date: 4/6/2025	Scale: AS NOTED
RLS	Solution and Annual States		SHEET NO.	7 OF 9
Drawing No.	Sound Environment		SHEET NO.	, 61 6
XX-XXX-XXX	vy/yy/2025		S-2	5-0008

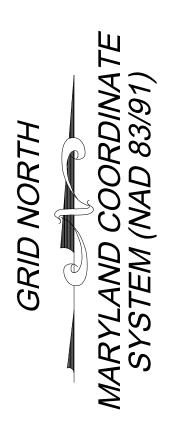

EXISTING LIVESTOCK FENCE -

747.6

1:1 TAPER (TYP) —

EXISTING TIMER GUARDRAILS -


EDGE OF EXISTING STREAM -

EXISTING 48" RED MAPLE SNAG -

747 1

R = 30' TURNING RADIUS


1×

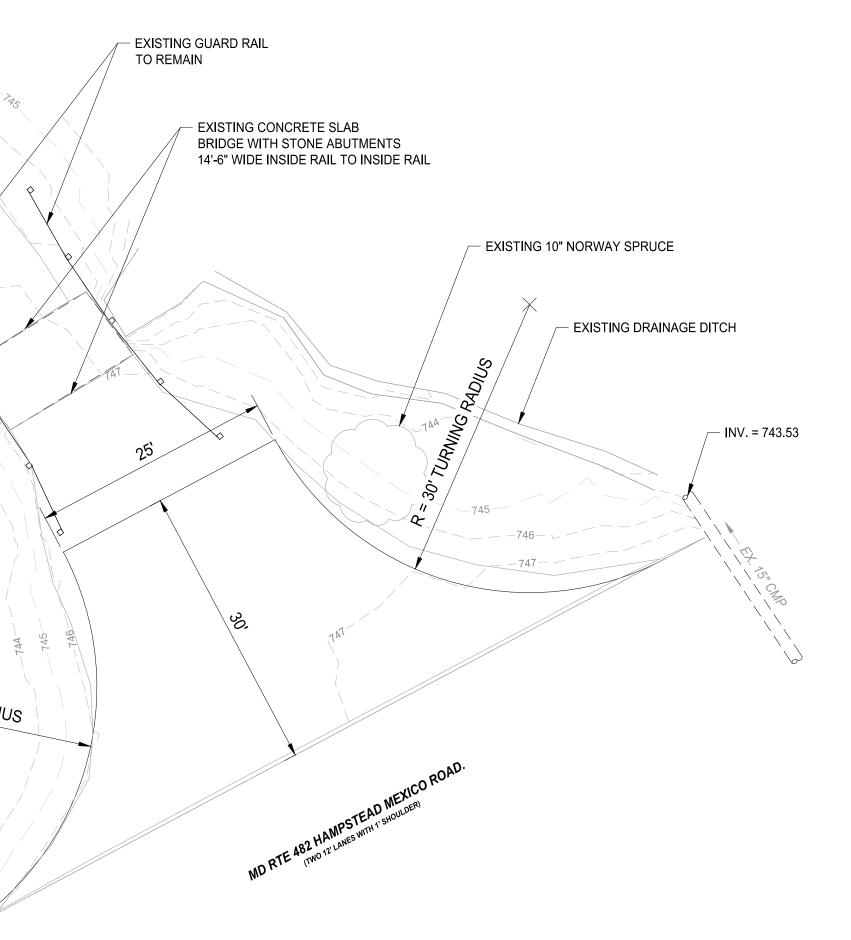

# 1 ENTRANCE PLAN


SCALE: 1" = 10'


DRIVE WAY ENTRANCE PLAN COWABUNGA FARM 2202 HAMPSTEAD MEXICO ROAD					
8th EL	ECTION DISTRICT TAX MAP - 40		COUNTY, MARYLAND RCEL - 527		
DATE	PROFESSIONAL CERTIFICATION:	– 2202 Hampst – Westminster,	bbott, PE, RLS ead Mexico Road , Maryland 21157 10-300-6350)		
REZ Checked By	Louis Contract	Date: 5/15/2025	Scale: AS NOTED		
RLS	ONAL STATE	SHEET NO.	8 OF 9		
Drawing No.     5/15/2025       XX-XXX-XXX     DATE		S-25-0008			

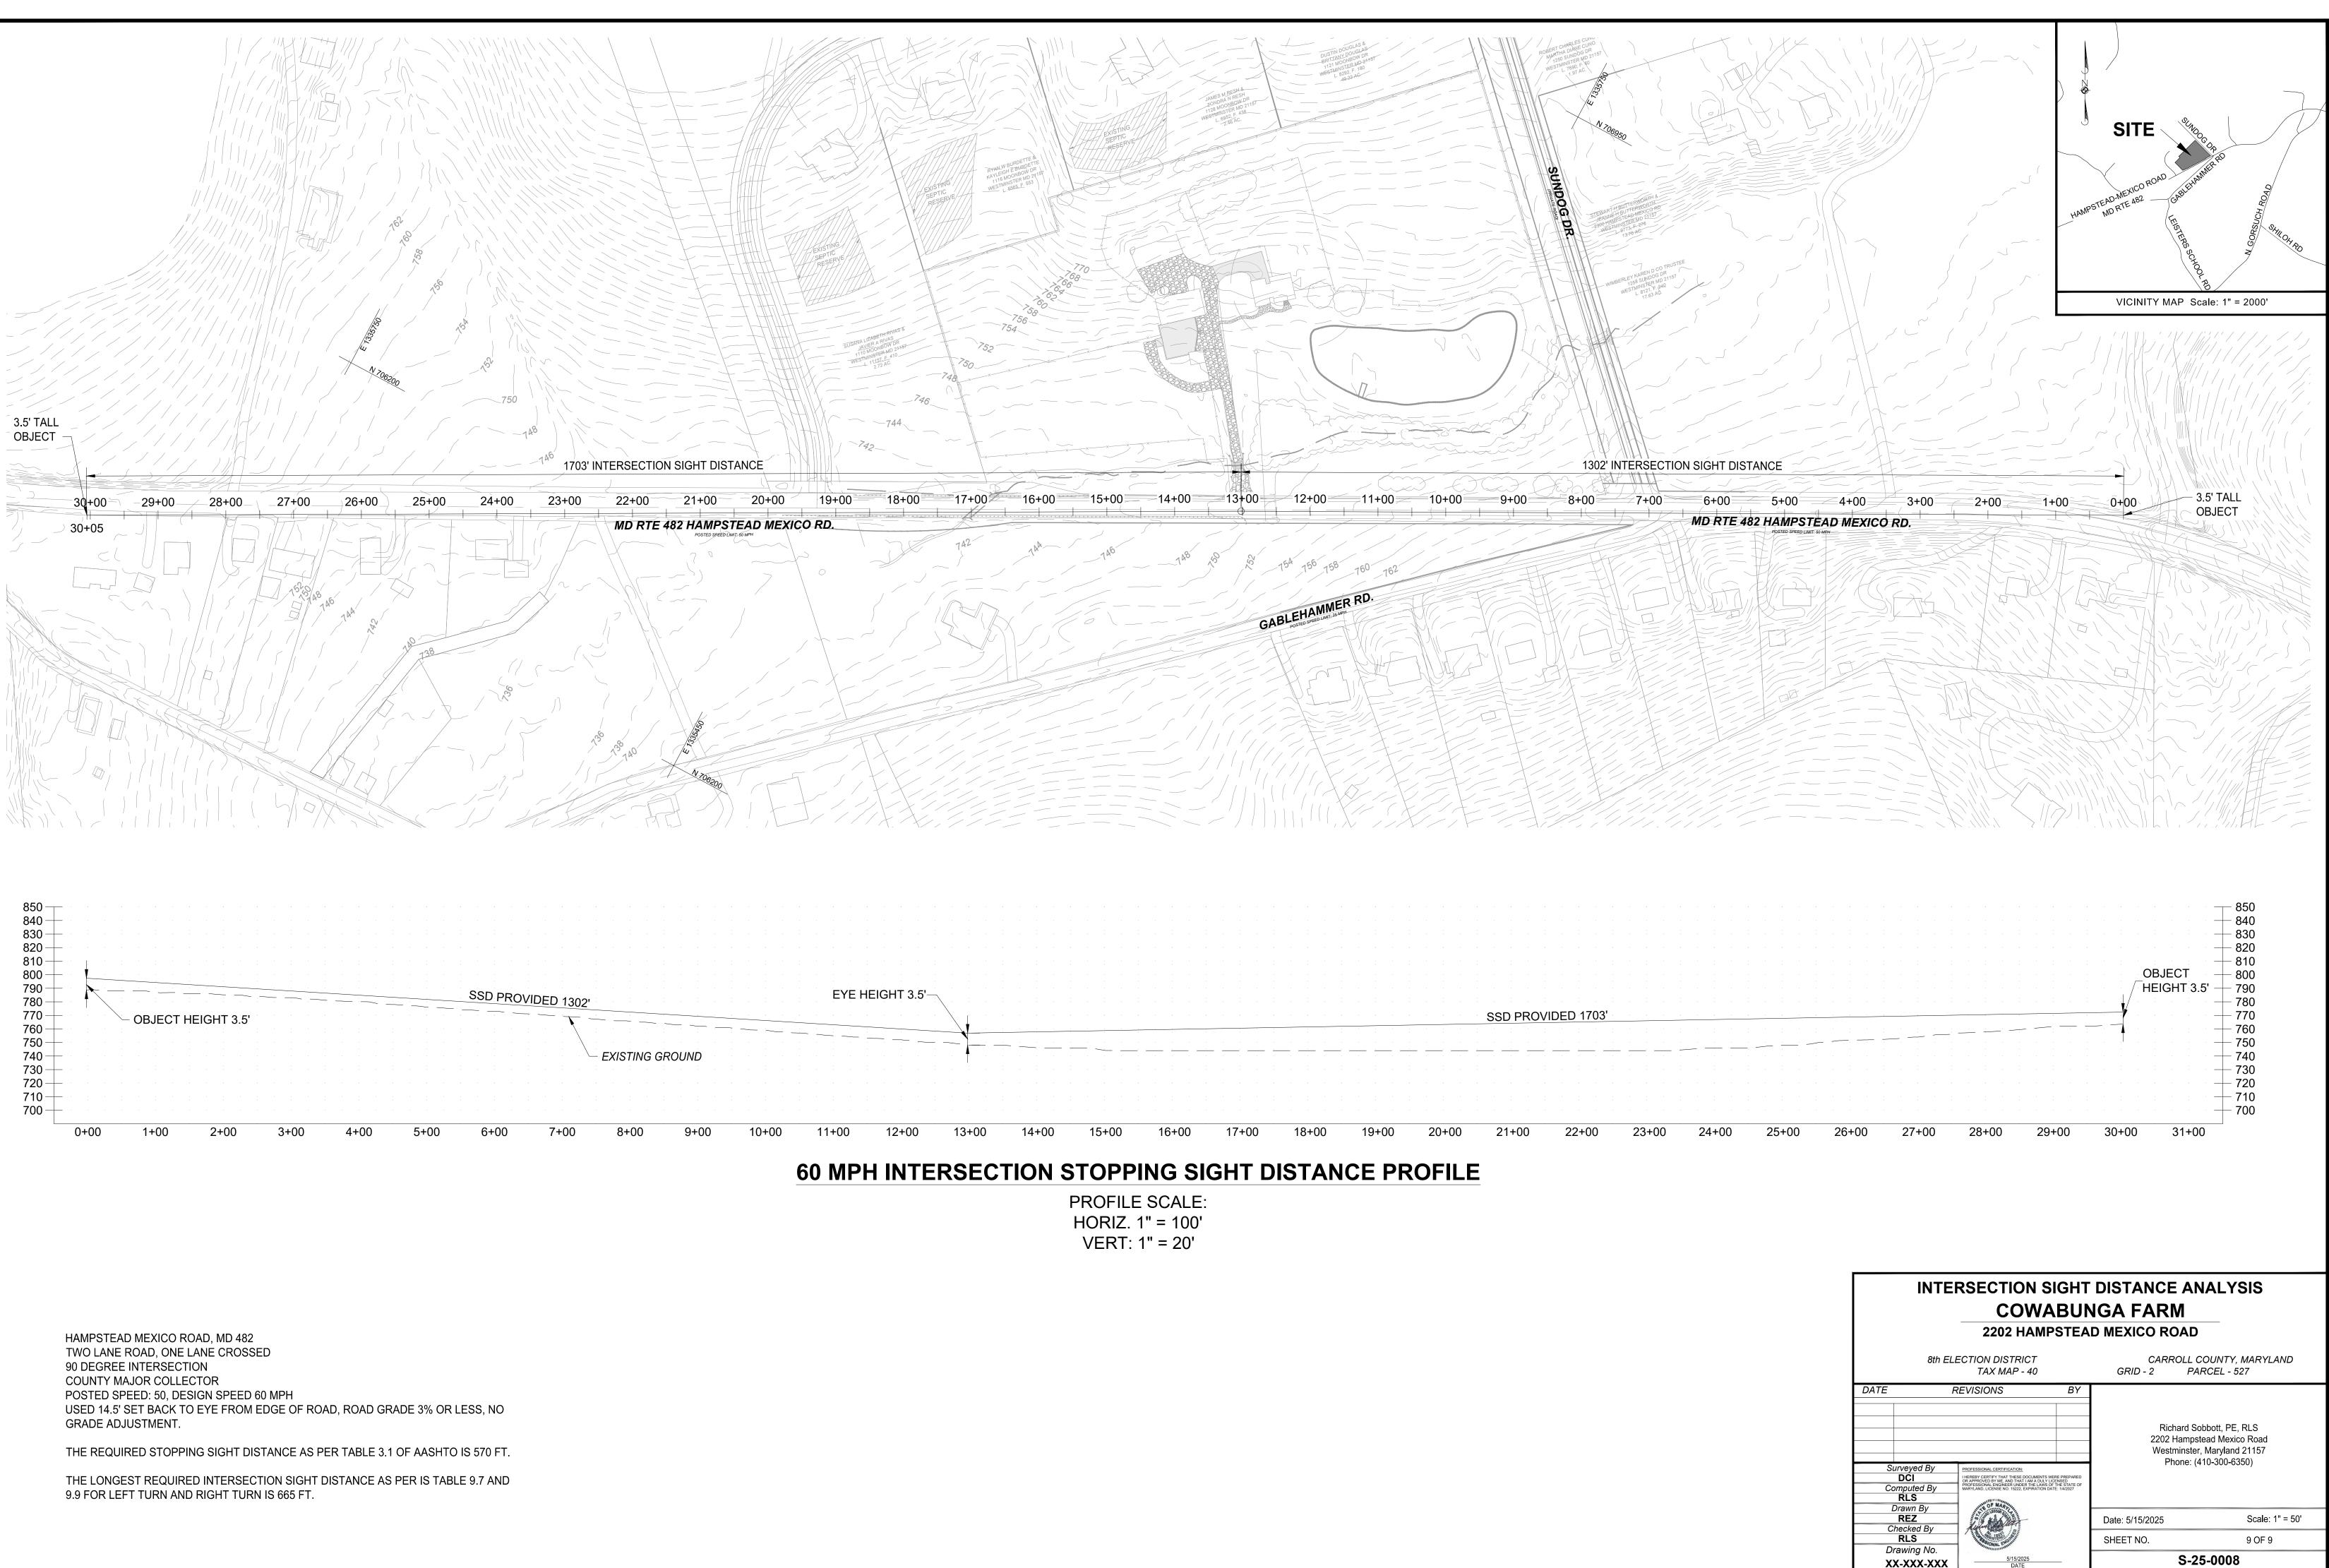

5/15/2025 DATE

XX-XXX-XXX

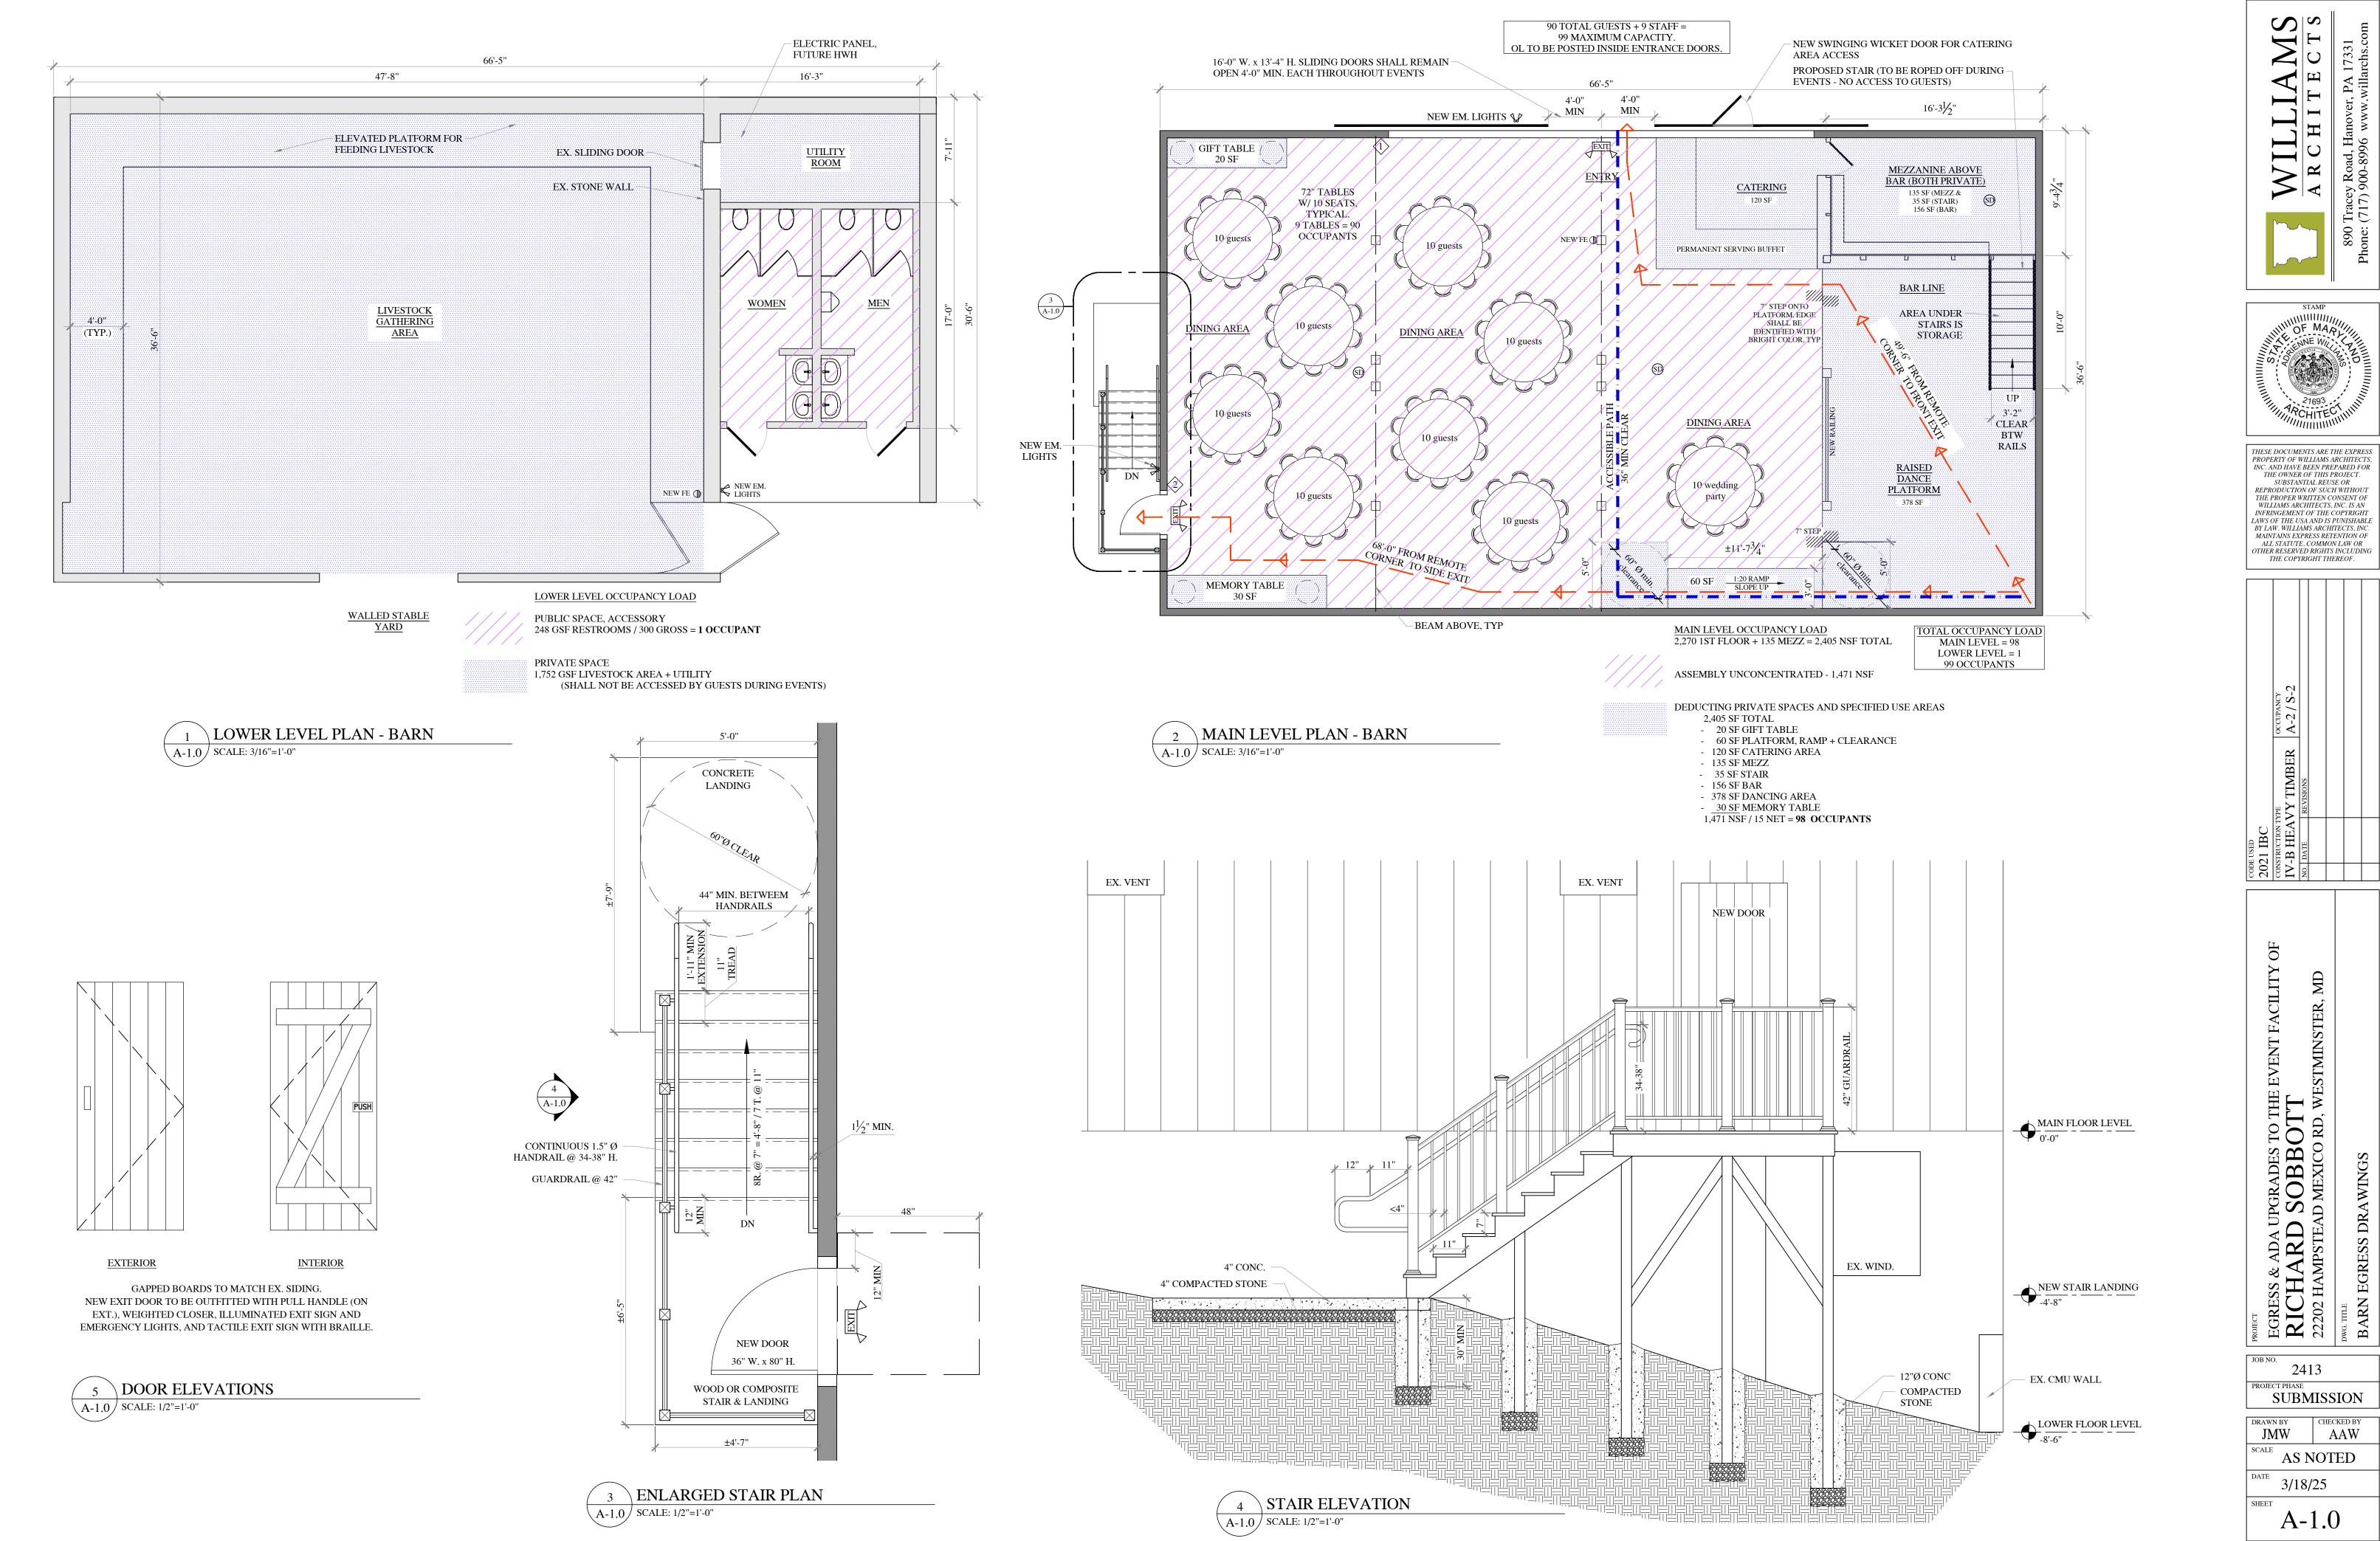

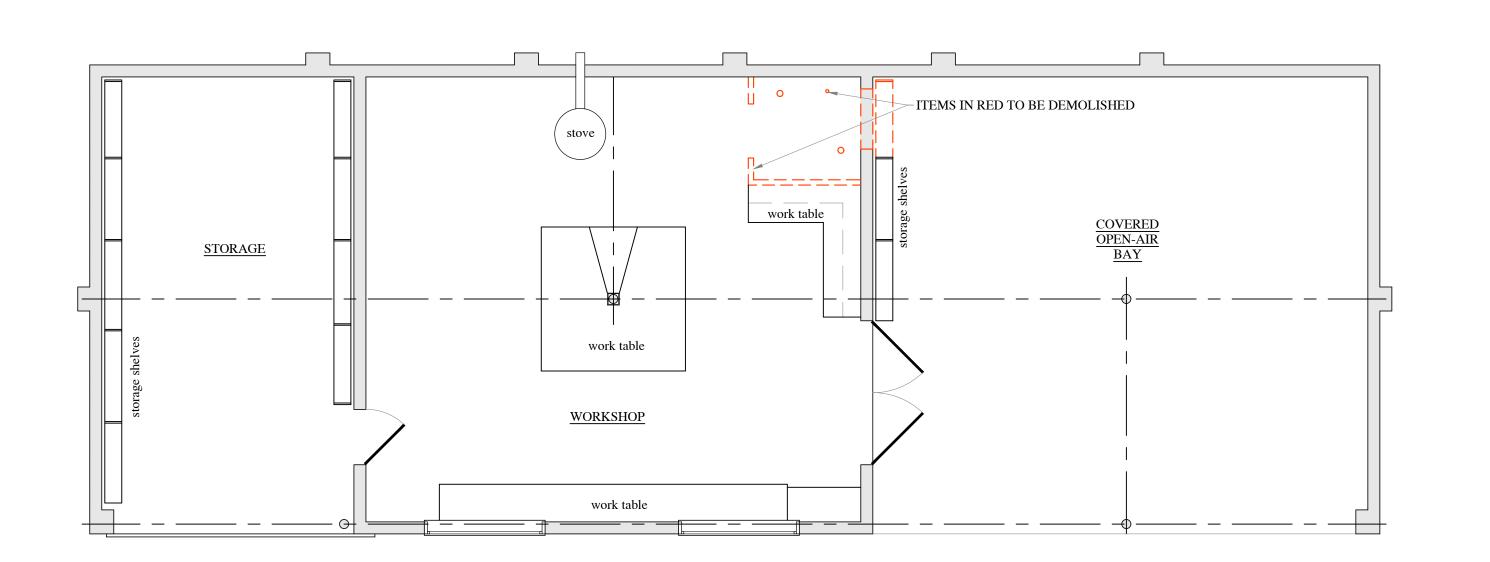

DEMOLITION PLAN - WORKSHOP (A-1.1) SCALE: 3/16"=1'-0"

## **RESTROOM ACCESSORIES**

## 1 MIRROR

- (2) SURFACE MOUNTED TOILET PAPER DISPENSER
- (3) GRAB BARS B-6806 SERIES. MANUFACTURED BY BOBRICK. 3a - 36" B-5806 x 36
  - 3b 42" B-5806 x 42 3c - 18" B-5806 x 18
- (4) ACCESSIBLE RESTROOM SIGNAGE
- 5 PAPER TOWEL DISPENSER
- (6) HAT AND COAT HOOK


### TOILET ROOM NOTES


- ALL DIMENSIONS MUST BE VERIFIED AND CHECKED ON JOB 1. SITE BEFORE MANUFACTURING MILLWORK.
- INSTALL CERAMIC TILE OR FRP 4'-0" MIN. HIGH ON PLUMBING 2. WALLS.
- ALL FINAL FINISHES AND ACCESSORIES TO BE CHECKED AND 3. VERIFIED WITH OWNER AND SHOP DRAWINGS.
- 4. INSULATE ALL EXPOSED PIPING BELOW LAVATORY AS PER ADA REQUIREMENTS.
- PROVIDE 2x6 BACKER BOARDS AT ALL GRAB BARS. 5.
- ANSI 304.1 CIRCULAR SPACE. THE TURNING SPACE SHALL BE A 6. CIRCULAR SPACE WITH A 60-INCH MINIMUM DIAMETER. THE TURNING SPACE SHALL BE PERMITTED TO INCLUDE KNEE AND TOE CLEARANCE COMPLYING WITH SECTION 306.
- A NEW DRAIN WILL CONNECT TO THE NEW SEPTIC SYSTEM. 7.

IBC 1209.2.2 WALLS AND PARTITIONS: WALLS AND PARTITIONS WITHIN 2 FEET OF SERVICE SINKS, URINALS AND WATER CLOSETS SHALL HAVE A SMOOTH, HARD, NONABSORBENT SURFACE, TO A HEIGHT OF NOT LESS THAN 4 FEET ABOVE THE FLOOR

ELEVATION - A

SCALE =  $\frac{1}{2}$ " = 1'-0"

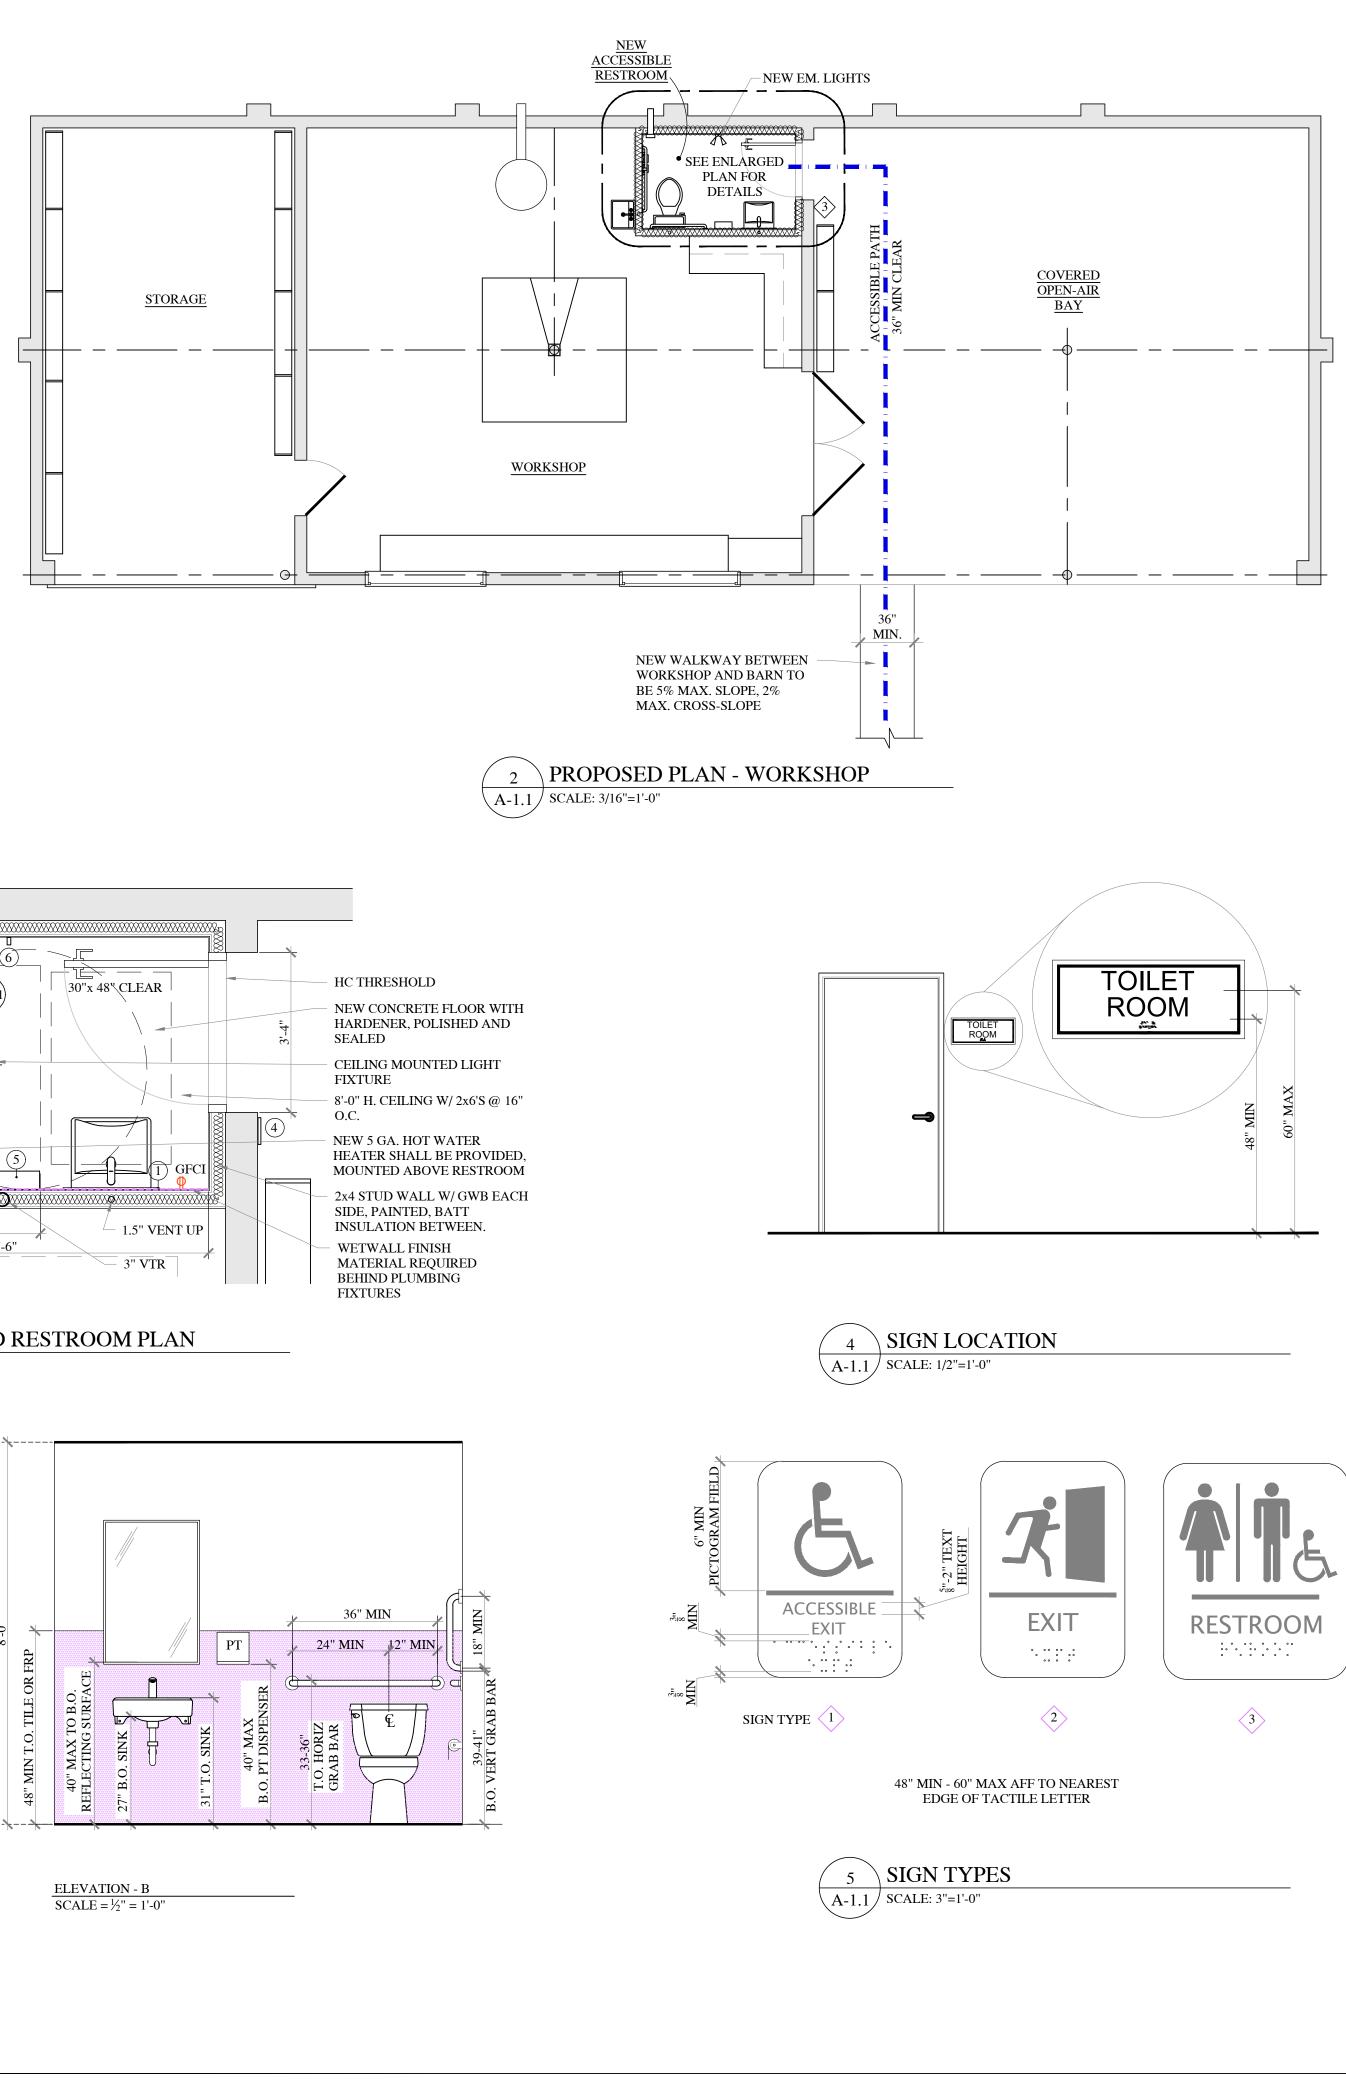

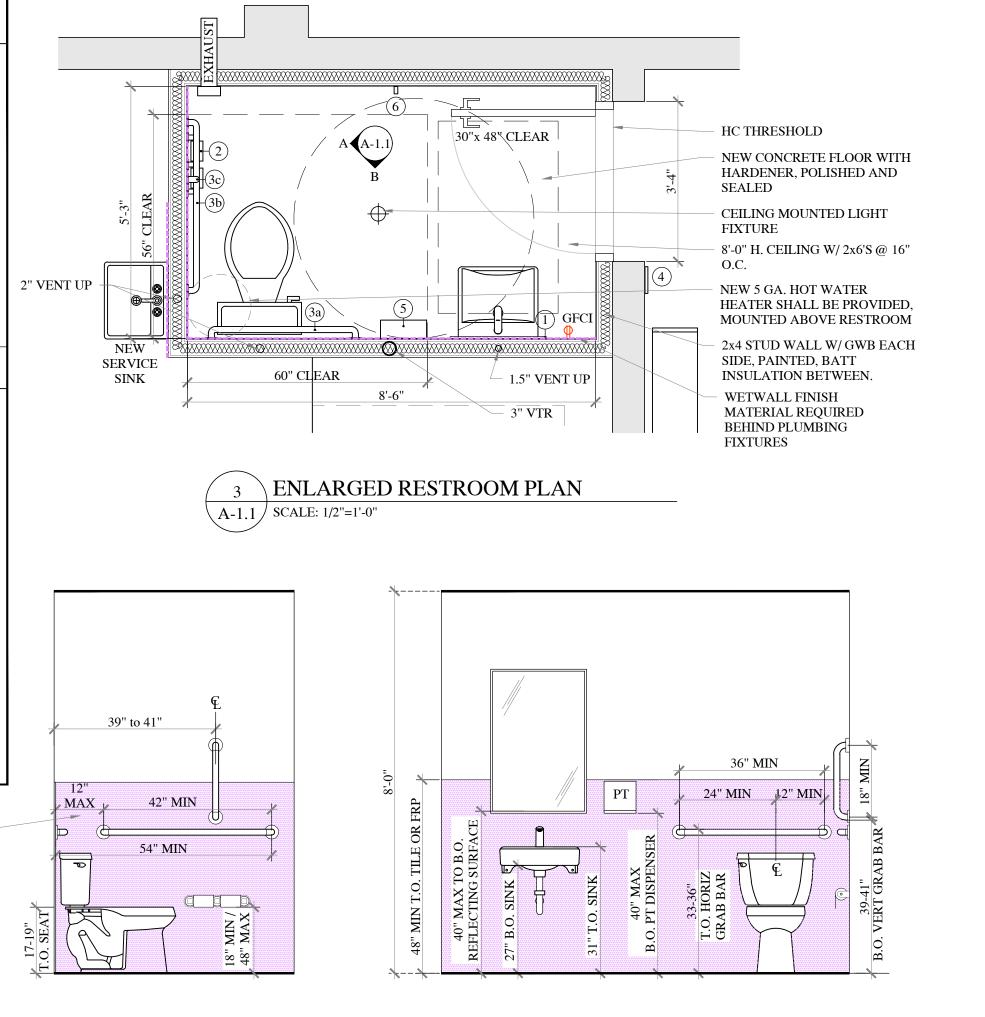

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CODE USED 2021 IBC CONSTRUCTION TYPE IV-B HEAVY TIMBER NO. DATE REVISIONS						
FINDERT EGRESS & ADA UPGRADES TO THE EVENT FACILITY OF RICHARD SOBBOTT 22202 HAMPSTEAD MEXICO RD, WESTMINSTER, MD	DWG. TITLE NEW ACCESSIBLE RESTROOM					
JOB NO. 2413 PROJECT PHASE SUBMISSION DRAWN BY JMW CHECKED BY AAW SCALE AS NOTED DATE 3/18/25 SHEET A-1.1						