AMENDED SITE DEVELOPMENT PLAN 2. TOTAL AREA OF PROPERTY: 10.5615 Acres TOTAL DEVELOPED AREA: 9.84 Acres 4. TOTAL DISTURBANCE: 298,000 sq. ft. / 6.84 Acres 5. THE PROPERTY SHOWN HEREON IS OWNED BY ALL ROADS TRUCK BODIES Owner: 5214 Klee Mill Road, LLC Deed Reference: Liber 11270 Folio 359 Date: June 25, 2024 Grantor: Plumbridge LLC 6. TAX MAP REFERENCE: Tax Map 68 - Grid 13 - Parcel 470. (FORMERLY KLEIN'S WAREHOUSE FACILITY) 7. TOPOGRAPHY: The 2' Contours as shown hereon were developed using Carroll County LIDAR products and Carroll County does not warrant its accuracy for any purposes and supplemented by data field surveyed by BPR LLC. 8. FIRE PROTECTION SOURCE: Building to be sprinklered. **9. EXISTING UTILITIES:** The location of existing utilities are approximate only. Contractor shall verify the existence, location, and depth of any existing utilities and shall notify the Engineer/Surveyor of any LOT 3B, SECTION ONE OF CENTRAL MARYLAND discrepancies prior to beginning work. 10. THE OWNER SHALL CONTACT THE FOLLOWING A MINIMUM OF 3 WORKING DAYS BEFORE **BEGINNING CONSTRUCTION: SERVICE & DISTRIBUTION CENTER** SCALE: 1 inch = 2,000 feet Miss Utility - toll free.. Carroll County Bureau of Permits and Inspections..... 14th ELECTION DISTRICT PERMITTED USE # 21096447 11. PLAN DIMENSIONS: The Contractor shall note that in case of a discrepancy between the scaled and figured dimensions shown on these plans, the figured dimensions shall govern. 12. CHANGES TO THE PLAN: Any changes to this plan will require an Amended Site Development Plan to be CARROLL COUNTY, MARYLAND approved by the Carroll County Planning and Zoning Commission. 13. SITE PLAN EXPIRATION: This Site Plan shall become void eighteen months after the date of the approval BLOCK - 13 **TAX MAP - 68** PARCEL - 470 no building permit or zoning certificates has been issued for this project, unless an extension of this time limit is issued by the Department of Land and Resource Management. PLAT BOOK - 51 **PAGE - 148** SITE DEVELOPMENT PLAN INSPECTION SEQUENCE NOTES LIST OF DRAWINGS . Contractor shall notify the Carroll County Bureau of Permits and Inspections at 410-386-2674, at least one (1) day prior to beginning any work. 2. Site Compliance Inspections are required at the following stages during construction. 1. TITLE SHEET a. Proposed structures staked out in proper locations as shown on these approved plans. 2. EXISTING FEATURES PLAN b. Proposed foundations installed for all buildings shown on these approved plans. 3. SITE LAYOUT AND DETAILS PLAN c. Sub-grades established for all drives, parking lots, and surrounding grading. **4.** GRADING PLAN d. Completion of all drives, parking lots, and surrounding grading. e. Completion of all work shown on these plans. 5. SEDIMENT CONTROL PLAN, NOTES & DETAILS It is the contractor's responsibility to contact the Carroll County Bureau of Permits and Inspections at **6.** ESD / FOREST CONSERVATION PLAN 410 - 386 - 2674 upon completion of each phase of construction. **7.** DRAINAGE AREA MAP 3. Contractor shall notify Carroll County Bureau of Resource Management, Environmental Inspection 8. STORMDRAIN PROFILES & DETAILS Services Division at 410 - 386 -2210 prior to beginning any work. All Forest Conservation plan devices must be in place prior to any construction. 9. MICRO-BIORETENTION #1 - #2 PLAN AND PROFILE 4. Final landscaping inspection shall be arranged through the Bureau of Resource Management, 10. MICRO-BIORETENTION #3 - #6 PLAN AND PROFILE Environmental Inspection Services Division at 410 - 386 - 2210 by the contractor/developer or agent. 11. STORMWATER MANAGEMENT, NOTES & DETAILS Written approval from the Landscape Review Specialist, Bureau of Resource Management, must be **12.** LANDSCAPE PLAN AND DETAILS obtained for any deviations from the landscaping or forest conservation plans or modifications in the plant material. **13.** PHOTOMETRIC PLAN Elevation: 731.61 5. The contractor shall not proceed to next phase of construction until given approval of prior phases. **14.** BUILDING ELEVATIONS SITE DATA CARROLL COUNTY MOUNMENT 1. PROPOSED USE: Light Manufacturing 2. BUILDING HEIGHT: Front = 30 ft. Rear = 30 ft. Floor Area = 40,000 sq.ft. of which **3. SIGNAGE:** Front of building 4'-0"x43'-9" = 175 SF End of building 5'-0"x22'-9" = 114 SF Total = 289 SF 4. LIGHTING: Building mounted wallpack lighting. 5. FIRE PROTECTION: This plan is in compliance with code of Local Laws & Ordinances of Carroll County. Maryland per Chapter 91 of The Fire Protection Ordinance. The owner shall maintain all fire alarms, extinguishers, lighting, sprinklers, and supervision in accordance with the State Fire Prevention Code. **6. STORMWATER MANAGEMENT:** This plan is in compliance with code of Local Laws & Ordinances of Carroll County, Maryland per Chapter 151 of The Stormwater Management Ordinance. The property contains a private stormwater management facility. A stormwater management easement and maintenance agreement CARROLL COUNTY SIGNATURE BLOCKS shall be granted to the Carroll County Commissioners as an easement of access to the County Commissioners or authorized representatives by a deed to be recorded simultaneously herewith CARROLL COUNTY DEPARTMENT OF PUBLIC WORKS BUREAU OF UTILITIES . WATER RESOURCE PROTECTION: This plan is in compliance with code of Local Laws & Ordinances of Carroll County, Maryland per Chapter 154 of The Water Resource Management Ordinance. The area shown hereon as Water Resource Protection Easement, with a total acreage of ???, shall be granted to the Carroll County Commissioners by a deed to be recorded simultaneously herewith. a. Designated Water Resource Protection Area(s): This site lies within an Surface Water Protection area. This site is not located within a Wellhead Protection Area, or near any existing or potential municipal well sites or well site buffers. CARROLL COUNTY DEPARTMENT OF PUBLIC WORKS BUREAU OF ENGINEERING b. Toxic Substances: No storage, use, sale or maintenance of any regulated substance is allowed on the premises without first obtaining the proper permits. Any person(s) handling on-site regulated substances must be in compliance with the applicable regulations of the Carroll County Bureau of Resource Management, "Water Resource Management Manual", Section IV. A. 8. PRIVATE WATER & SEWAGE SERVICE: The proposed is being served by private well and septic. 9. PARKING TABULATION: INDUSTRIAL OR MANUFACTURING, CARROLL COUNTY PLANNING AND ZONING COMMISSION APPROVAL REQUIREMENTS: 1 space per 1.5 employees on maximum Shift. **TABULATION** 25 employees ÷ 1.5 = 17 spaces CARROLL COUNTY HEALTH DEPARTMENT APPROVAL Total Spaces Required: = 17 spaces = **72** Spaces Total Existing Spaces Total Spaces Provided: = 89 spaces ADA space(Van Accessible)(1 space/ 50 std spaces) = 3 Provided MISS UTILITY **ENGINEERS CERTIFICATION BENCH MARKS** I hereby certify that these construction drawings and associated computations were prepared by me or under my supervision and comply with all applicable standards and regulations of Carroll County. I have reviewed these documents with the Owner/Developer. BENCH MARK #1 - Steel Pin Found On North east Property Corner, Elevation =690.11 N 643447.5584 , E 1313601.7238 NAME (PRINTED) INCLESSARY COMPONENTS FOR CONSTRUCTION SAFETY. ALL CONSTRUCTION MUST BE DONE IN COMPLIANCE WITH THE OCCUPATIONAL SAFETY AND HEALTH ACT O 1970 AND ALL RULES AND REGULATIONS THERETO APPURTENANT. MD REGISTRATION NO: BENCH MARK #2 - Tall Steel Pipe Found On Westerly Most Property Corner, **LOCATION PLAN** Elevation = 731.61 Fire Protection THE CONTRACTOR TO CALL MISS UTILITY TO HAVE ALL EXISTING UTILITIES MARKED 48 HOURS PRIOR TO ANY CONSTRUCTION. N 643580.5360 , E 1312208.1340 SIGNATURE DATE TITLE SHEET **LEGEND EXISTING PROPOSED** OWNER / DEVELOPER OWNERS'S/DEVELOPER'S CERTIFICATION LOT 3B, SECTION ONE OF CENTRAL MARYLAND EDGE OF PAVEMENT EDGE OF PAVEMENT PROPERTY LINE SUBJECT PROPERTY LINE SUBJECT **SERVICE & DISTRIBUTION CENTER ALL ROADS TRUCK BODIES** PROPERTY LINE ADJOINER PROPERTY LINE ADJOINER DENOTES CONTOURS DENOTES CONTOURS I/WE hereby certify that all proposed work shown on these construction drawing(s) 5214 KLEE MILL ROAD, LLC (FORMERLY KLEIN'S WAREHOUSE FACILITY) DENOTES SUPER SILT FENCE SSF DENOTES SUPER SILT FENCE DENOTES EDGE OF ROAD DENOTES EDGE OF ROAD —— SSF — has been reviewed by me/us and that I/WE fully understand what is necessary to 925 MERRITT BOULVARD TAX MAP - 68 GRID - 13 PARCEL - 470 accomplish this work and that the work will be conducted in strict accordance with DUNDALK, MD 2122 DENOTES SILT FENCE DENOTES SILT FENCE DENOTES CURB DENOTES CURB these plans. I/WE also understand that any changes to these plans will require an 410-285-0600 amended plan to be reviewed and approved by the Carroll Coutny Planning and **CENTER LINE ROAD** LIMITS OF DISTURBANCE CENTER LINE ROAD • • • • • LIMITS OF DISTURBANCE BPR Zoning Commission before any change in the work is made. Computed By DENOTES BUILDING **DENOTES BUILDING** OVERHEAD UTILITIES **OVERHEAD UTILITIES** AEH / EDA **LAND SURVEYING & CIVIL ENGINEERING** DENOTES WATER LINE DENOTES WATER LINE **GUARD RAIL GUARD RAIL** 0 0 0 0 Drawn By 150 Airport Drive, Suite 4 Name(s) (Printed) Date SANITARY SEWER LINE CONCRETE SANITARY SEWER LINE CONCRETE Westminster, Maryland 21157 JWF / EDA 410 - 857 - 9030 STORMDRAIN MANHOLE PAVEMENT (DRIVEWAYS / ROADS) STORMDRAIN MANHOLE PAVEMENT (DRIVEWAYS / ROADS) Checked By INFO@BPRSURVEYING.COM WATER VALVE SANITARY SEWER MANHOLE WATER VALVE SANITARY SEWER MANHOLE RAP FIRE HYDRANT BPR, LLC Job No. 23-1212 SANITARY SEWER CLEAN OUT WATER METER SANITARY SEWER CLEAN OUT Carroll County File No. S - 24 - 0022 DENOTES PERPETUAL EASEMENT FOR PARKING

AREA AND ACCESS ROAD FOR LOT 4A

Date: November 11, 2024

Scale: 1 inch = 100 feet

ngineer's Signature -


SHEET 1 OF 14


HANDICAP PARKING


FIRE HYDRANT

HANDICAP PARKING


1. EXISTING ZONING: I-1 Light Industrial

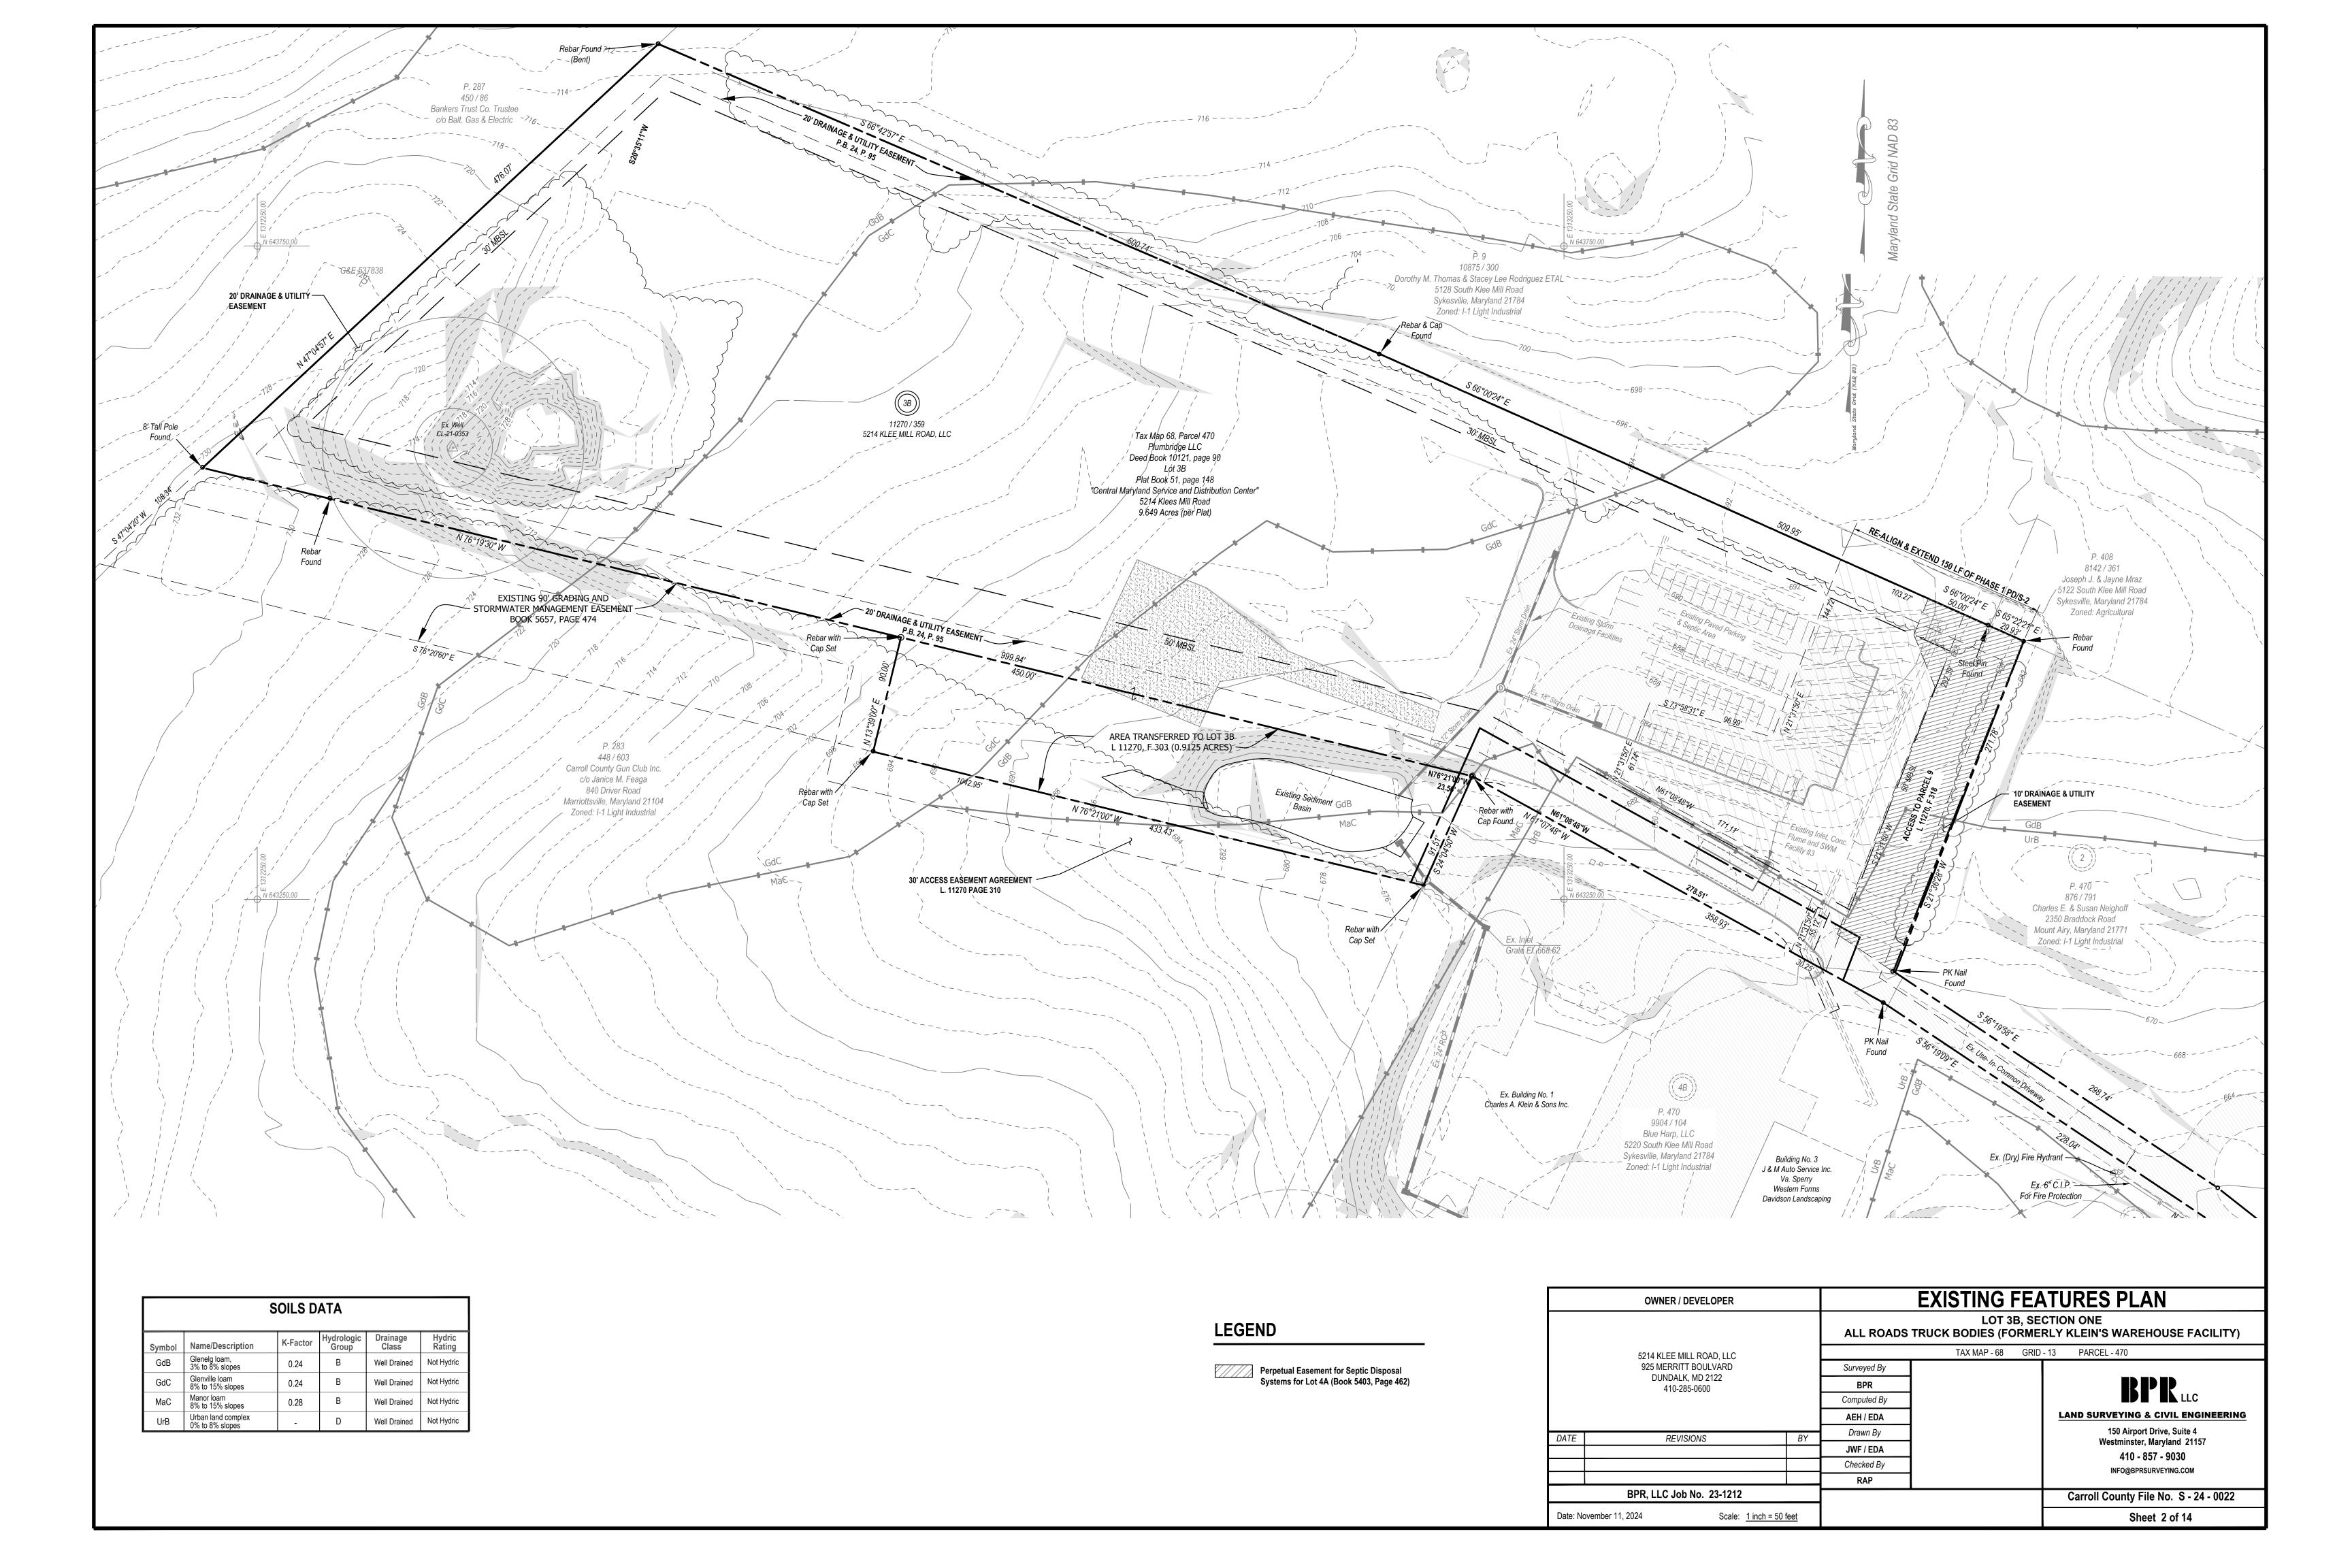


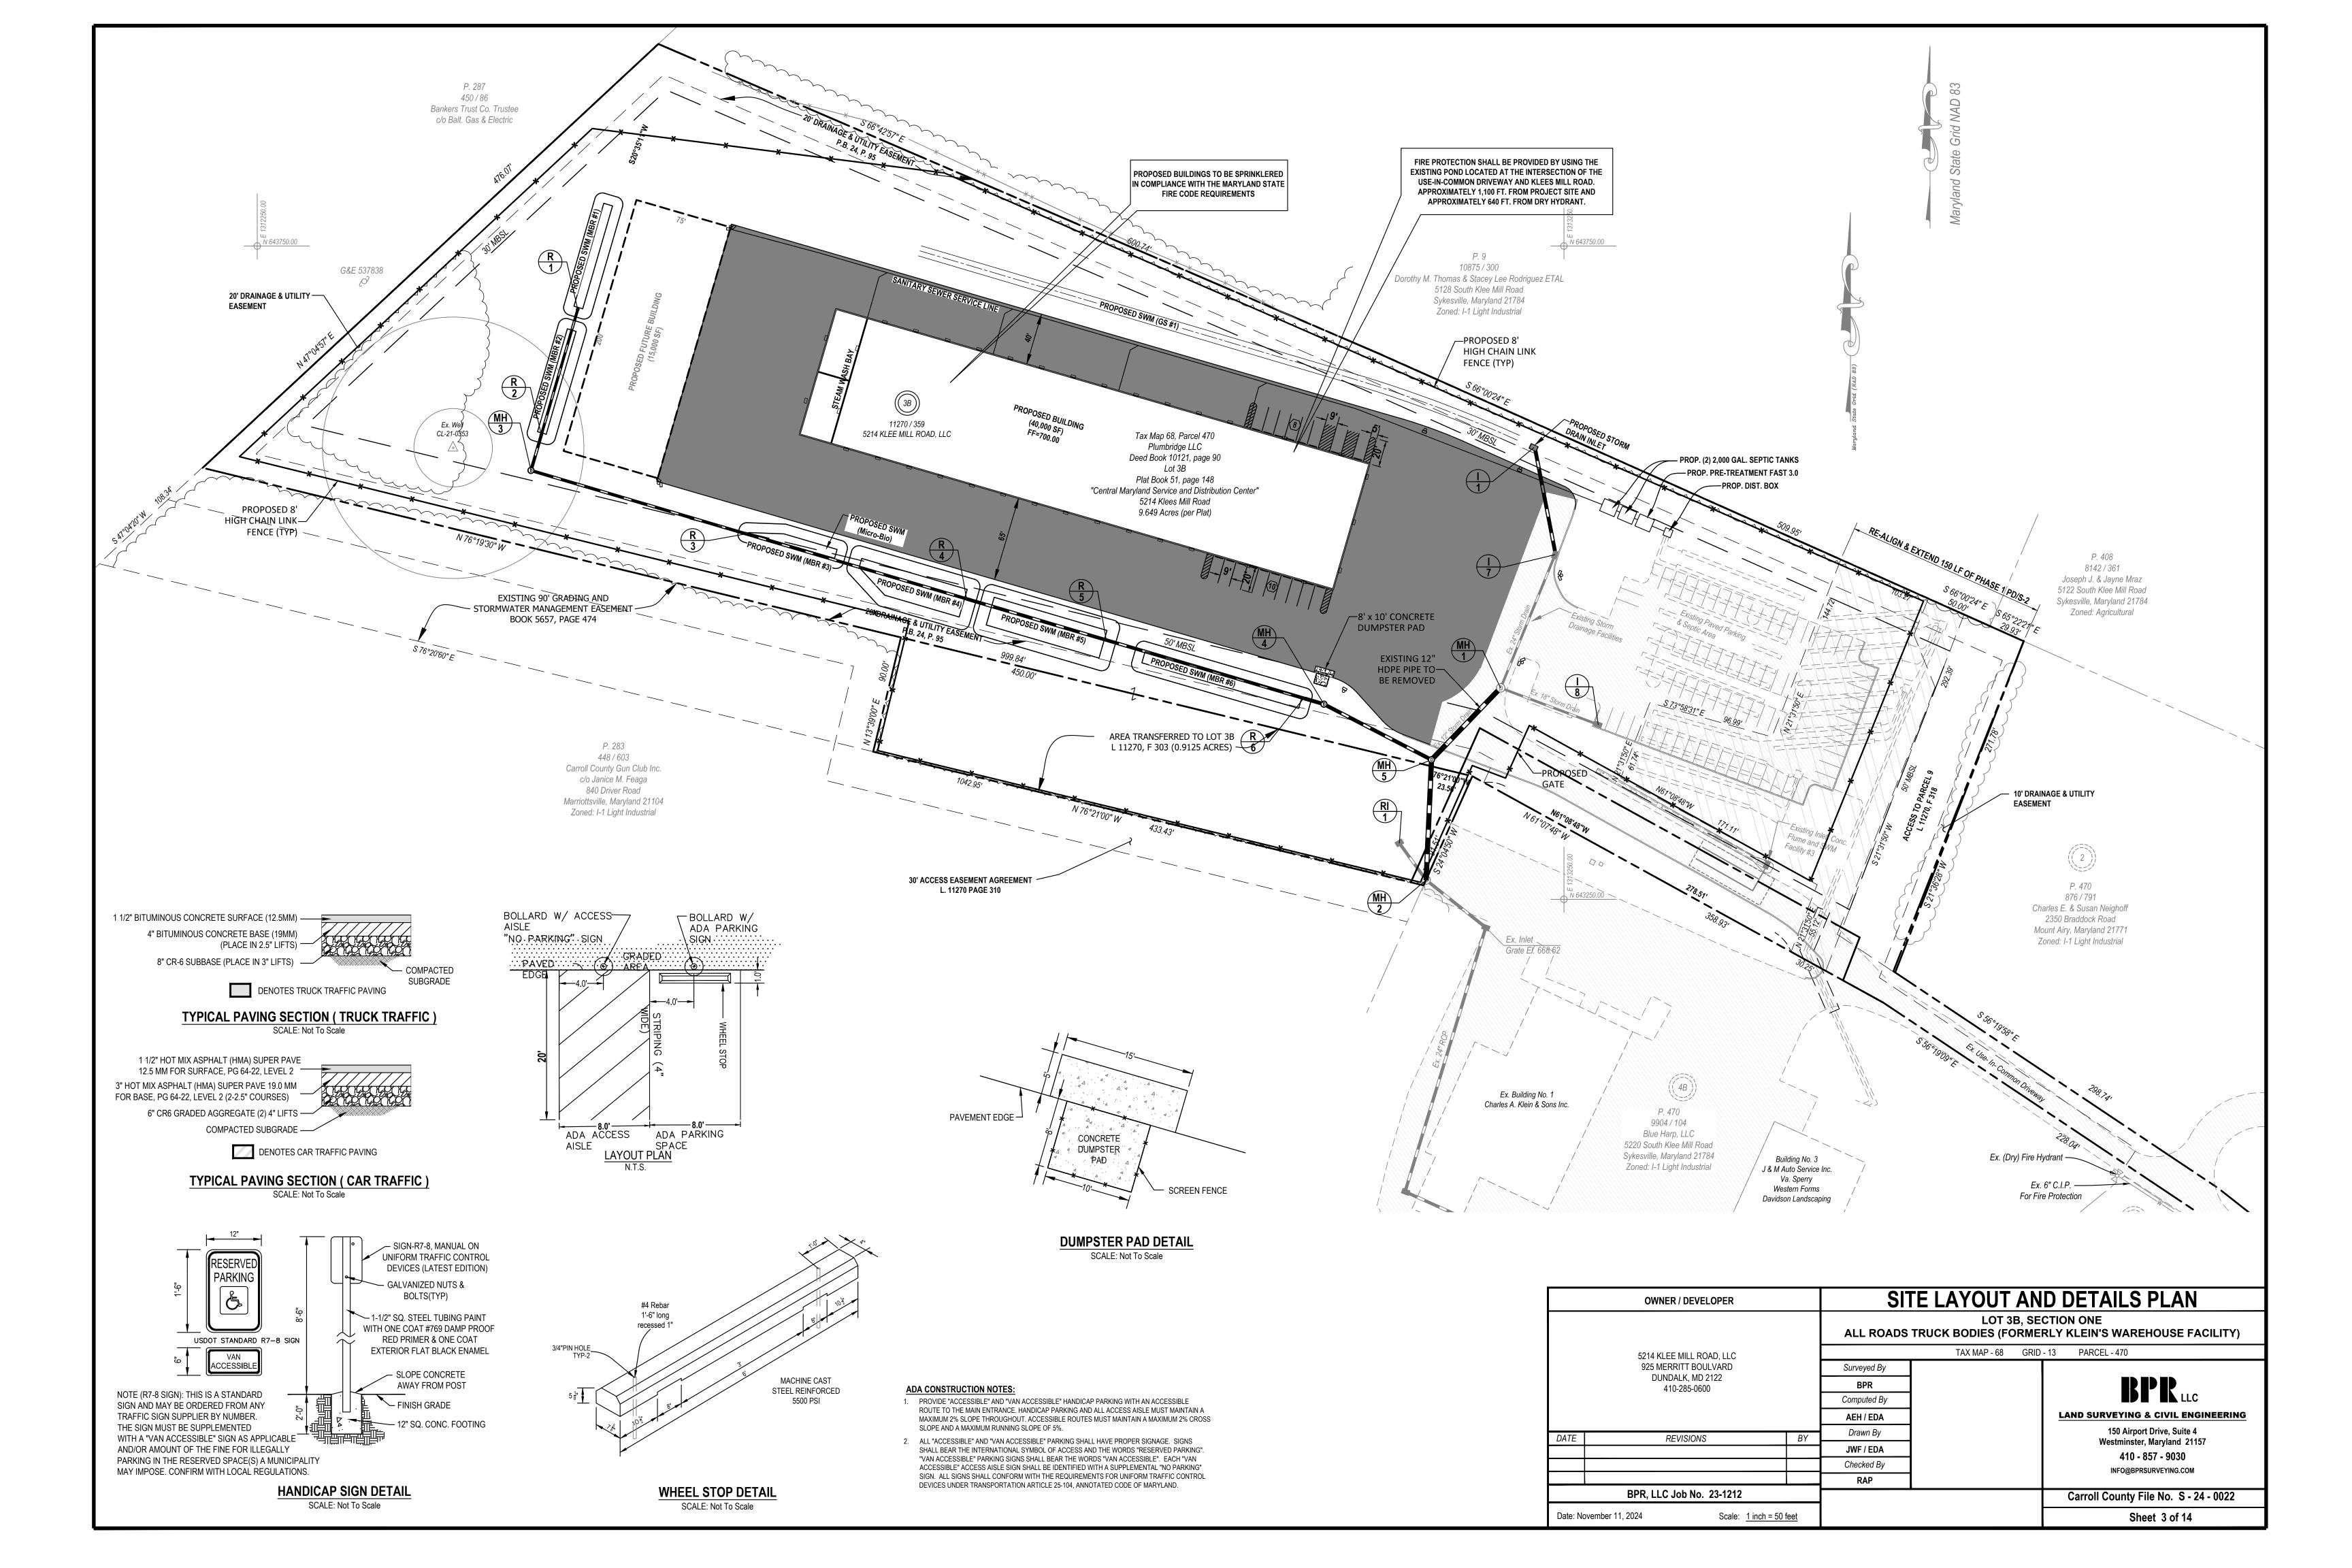


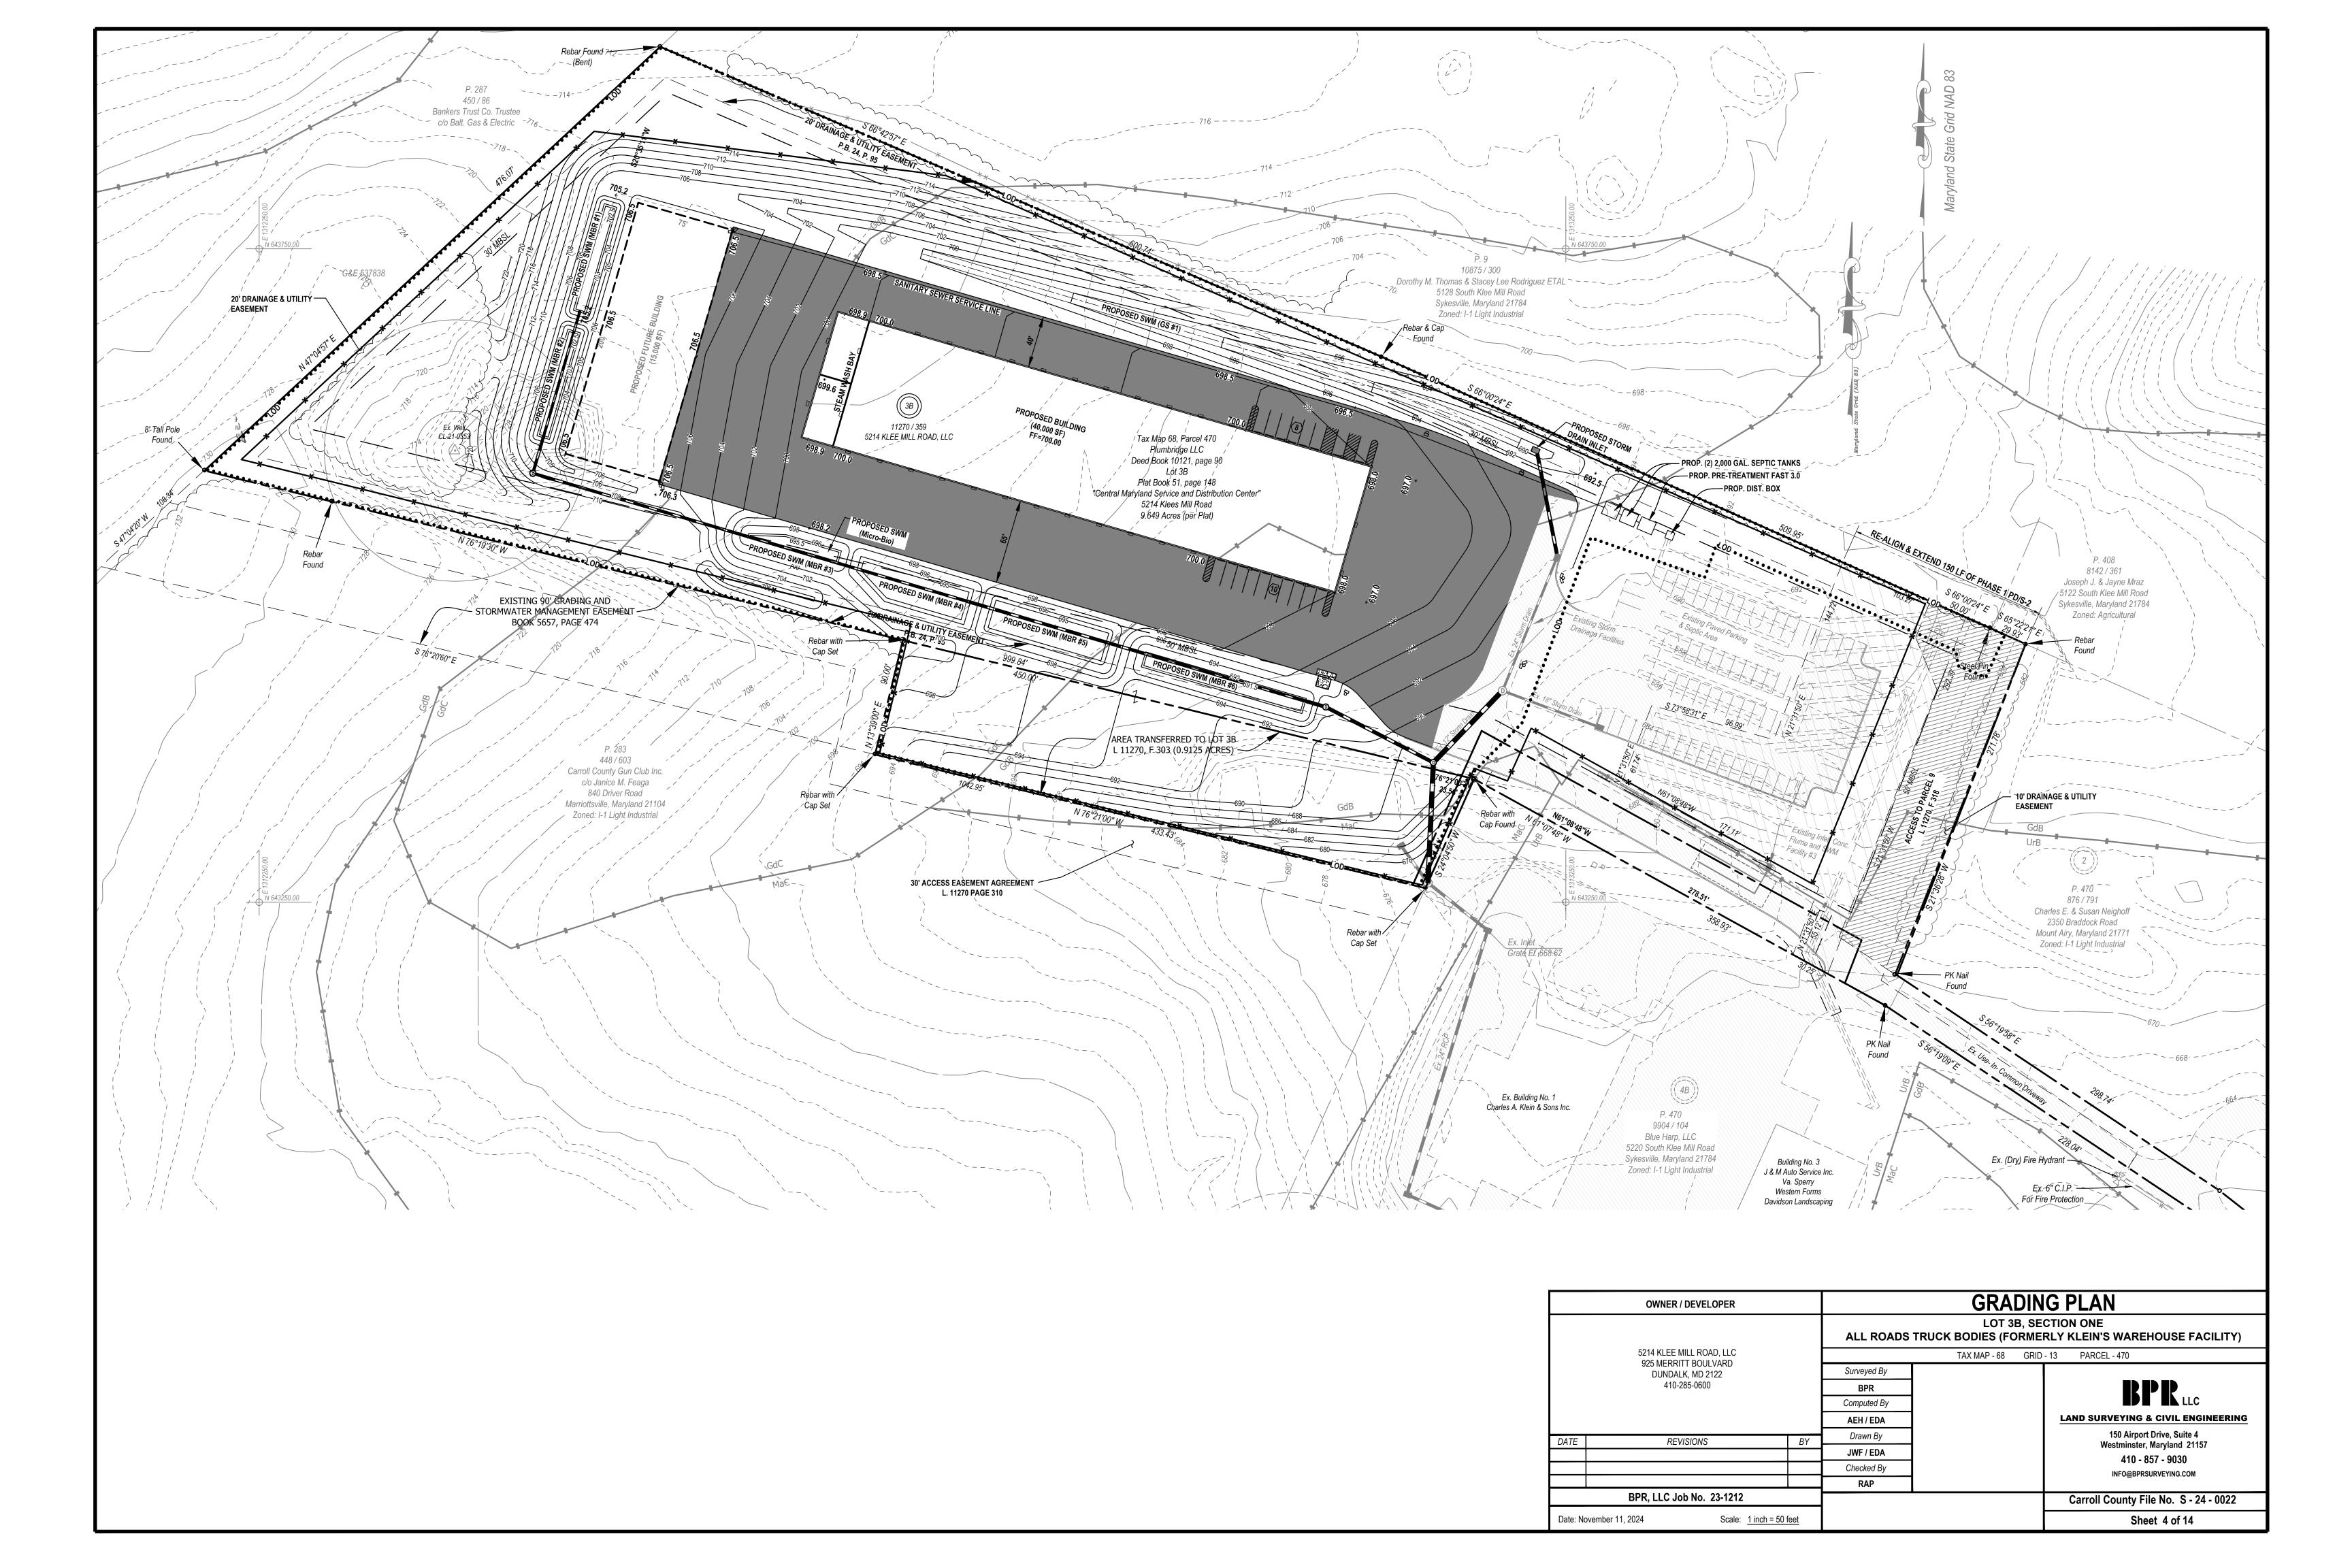


PERMANENT SEEDING NOTES DETAIL 3 - PERIMETER DIKE / SWALE **TEMPORARY SEEDING NOTES DETAIL 33 - SUPER SILT FENCE** REQUIRED SEQUENCE OF CONSTRUCTION **DETAIL 24 - STABILIZED CONSTRUCTION ENTRANCE** SCOPE: Planting permanent, long lived vegetative cover on grading and/or cleared areas and areas that 1. Contact the Sediment Control Inspector 24 hours prior to any work being done 1. SCOPE: planting short term (no more than one (1) year) vegetation to temporarily stabilize COMPACTED EARTH have been in temporary vegetation for more than one (1) year. any areas where soil disturbance has occurred, until the area can be permanently CENTER TO CENTER (410-848-8200). All protection fencing and signage required under Carroll County Code - MOUNTABLE BERM (6" MIN. STANDARDS: The following notes shall conform to the "1994 Maryland Standards and Specifications for SHALL NOT EXCEED 10' stabilized with vegetative or non-vegetative practices. Chapter 150 Forest Conservation must be installed PRIOR to the pre-construction meeting Erosion and ediment Control" published jointly by the Maryland Department of the Environment - Water 2. STANDARDS: The following notes shall conform to the "1994 Maryland Standards and Specifications for Erosion with the Sediment Control Inspector. $\overrightarrow{\rightarrow} \overrightarrow{\rightarrow} \overrightarrow{\rightarrow}$ Management Administration, the National Resource Conservation Service and the State Soil and Sediment Control" published jointly by the Maryland Department of the Environment - Water Management Conservation Committee. Administration, the National Resource Conservation Service and the State Soil Conservation Committee. 2. Install Rock Construction entrance and perimeter sediment control devices including Super ** GEOTEXTILE CLASS 'C'ii. PERMANENT SEEDING 3. SEEDBED PREPARATION: TEMPORARY SEEDING Silt Fence and Perimeter Dike Swale. Contractor to make the following adjustments to the OR BETTER EXISTING — OVER LENGTH AND WIDTH OF a. Minimum soil conditions required for permanent vegetative establishment: A. Seedbed preparation shall consist of loosening soil to a depth of 3" to 5" by means of existing Sediment Control Basin: 1. Soil ph shall be between 6.0 and 7.0 MINIMUM 6" OF 2"-3" AGGREGATE suitable agricultural or construction equipment, such as disc harrows or chisel plows or CROSS SECTION 2 . Soluble salts shall be less than 500 parts per million (ppm). rippers mounted on construction equipment. after the soil is loosened it should not be **PROFILE** a. Regrade Sediment Basin per the proposed sediment control plan and install the rock 21/2" DIAMETER 3. The soil shall contain less than 40% clay but enough fine grained material (>30%silt plus clay) rolled or dragged smooth but left in the roughened condition. slopeD areas (greater than outlet. Contractor to maintain the existing 12" storm drain from MH-1 to the sediment OR ALUMINUM WITH 1 LAYER O to provide the capacity to hold a moderate amount of moisture. An exception is if lovegrass or (3:1) should be tracked leaving the surface in an irregular condition with ridges running FILTER CLOTH serecia lespedeza is to be planted, then a sandy soil (<30% silt plus clay) would be acceptable. parallel to the contour of the slope. PROVIDE POSITIVE DRAINAGE Soil shall contain 1.5% minimum organic matter by weight. B. Apply fertilizer and lime as prescribed on the plans. b. Contractor to remove the existing riser structure and associated storm drain pipe to CHAIN LINK FENCING- $\overline{\Lambda}$ $\overline{\Lambda}$ $\overline{\Lambda}$ $\overline{\Lambda}$ $\overline{\Lambda}$ $\overline{\Lambda}$ $\overline{\Lambda}$ $\overline{\Lambda}$ $\overline{\Lambda}$ C. Incorporate lime and fertilizer into the top 3" - 5" of soil by disking or suitable means. 5. Soil must contain sufficient pore space to permit adequate root penetration. MH-2. Contractor to parge the pipe opening closed in MH-2. 6. If these conditions cannot be met by soils on site, adding topsoil is required in 4. TEMPORARY SEEDING SUMMARY 3. Grade site according to the grading plan. Construct proposed building. Install storm drain inlet accordance with section 21standard and specification for topsoil. b. Areas previously graded in conformance with the drawings shall be maintained in a true EMBED FILTER CLOTH 8" —— I-1 and associated inlet protection according to plans. Install proposed MH-4. MINIMUM INTO GROUND (FROM TABLE 26) and even grade, then scarified or otherwise loosened to a depth of 3"-5" to permit bonding FERTILIZER RATE 4. Upon completion of building final grading proposed paved areas and install paving to PD/S-1 SEED AND MULCH (DRAINING 1 ACRE) PD/S-2 SEED AND COVER WITH SOIL (10-10-10) IF MULTIPLE LAYERS ARE APPLICATION of the topsoil to the surface area and to create horizontal erosion check slots STANDARD SYMBOL SEEDING DATES REQUIRED TO ATTAIN 42" STABILIZATION MATTING OR LINE WITH SOD (DRAINING BETWEEN 1 AND 2 ACRES) sub-base course. to prevent topsoil from sliding down a slope. **BARLEY** 1 3/1 \ 5/15 c. Apply soil amendments as per soil test or as included on the plans. 1. All perimeter dike/swales shall have an uninterrupted positive grade to an outlet. Spot OR RYE STANDARD SYMBO 5. Final grade grass swale GS-1 and stabilize. Begin construction of micro-bioretention facilities 8/15 \ 10/15 d. Mix soil amendments into the top 3"-5" of topsoil by disking or other suitable means. lawn areas 2 TONS/ac (100 600 lb/ac (15 elevations may be necessary for grades less than 1%. MBR-1 through MBR-6 and associated structures and piping. Connect micro-bioretention SCE should be raked to smooth the surface, remove large objects like stones and branches and 2. Runoff diverted from a disturbed area shall be conveyed to a sediment trapping device CONSTRUCTION SPECIFICATIONS 3. Runoff diverted from an undisturbed area shall outlet into an undisturbed stabilized area ready the area for seed application. where site conditions will not permit normal seedbed Fencing shall be 42" in height and constructed in accordance with the 5. Seed tags should be available to the inspector to verify the type and rate of seed. preparation, loosen surface soil by dragging with a heavy chain or other equipment to a non-erosive velocity. latest Maryland State Highway Details for Chain Link Fencing. The specification 6. With approval of the Sediment Control Inspector remove sediment basin and 12" storm drain 6. Straw mulch to be spread at the rate of 2 tons/acres. mulch shall be applied to a uniform 4. The swale shall be excavated or shaped to line, grade, and cross-section as required to roughen the surface. Steep slopes (steeper than 3:1) should be traced by a dozer leaving the for a 6' fence shall be used, substituting 42" fabric and 6' length posts. pipe to MH-1. Install storm drain manhole MH-5 and connect to MH-1, MH-2 and MH-4. 2. Chain link fence shall be fastened securely to the fence posts with wire ties. loose depth of between 1" and 2". mulch shall be uniformly distributed so that the soil meet the criteria specified in the standard. . Length - minimum of 50' (*30' for single residence lot). soil in an irregular condition with ridges running parallel to the contour of the slope. The lower tension wire, brace and truss rods, drive anchors and post caps are not 2. Width - 10' minimum, should be flared at the existing road to provide a turning surface is not exposed. mulch binder: Application of liquid binders should be heavier at the The top 1"-3" of soil should be loose and friable. Seedbed loosening may not be necessary 5. Fill shall be compacted by earth moving equipment. 7. Stabilize all remaining disturbed areas and apply permanent seeding and mulching per the required except on the ends of the fence. edges where wind catches mulch, such as in valleys and on crests of banks. the remainder 6. Stabilization with seed and mulch or as specified of the area disturbed by the dike and on newly disturbed areas. 3. Filter cloth shall be fastened securely to the chain link fence with ties spaced sediment control plan. 3. Geotextile fabric (filter cloth) shall be placed over the existing ground prior of area should appear uniform after binder application, synthetic binders such as acrylic dlr swale shall be completed within 7 days upon removal. every 24" at the top and mid section. to placing stone. **The plan approval authority may not require single family D. SEED SPECIFICATIONS 8. With the permission of the Sediment Control Inspector remove all remaining sediment control 4. Filter cloth shall be embedded a minimum of 8" into the ground. (agro-tack), dca-70, petroset, terra tax ii, terra tack ar or other approved equal may be used . Inspection and required maintenance shall be provided after each rain event. residences to use geotextile i. All seed must meet the requirements of the maryland state seed law. All seed shall be subject to 5. When two sections of filter cloth adjoin each other, they shall be overlapped 4. Stone - crushed aggregate (2" to 3") or reclaimed or recycled concrete at rates recommended by the manufacturer to anchor mulch. Note: The maximum drainage area for this practice is 2 acres. re-testing by a recognized seed laboratory. All seed used shall be tested within six (6) months equivalent shall be placed at least 6" deep over the length and width of the PAGE MARYLAND DEPARTMENT OF ENVIRONME A - 3 - 3 WATER MANAGEMENT ADMINISTRATION 6. Maintenance shall be performed as needed and silt buildups removed when "bulges" immediately eceding the date of sowing such material on this job. Seed tags shall be made 9. Apply final paving course, paving markings, parking blocks and signage. develop in the silt fence, or when silt reaches 50% of fence height 5. Surface Water - all surface water flowing to or diverted toward construction available to the inspector to verify type and rate of seed used. note: SITE ANALYSIS: 7. Filter cloth shall be fastened securely to each fence post with wire ties or entrances shall be piped through the entrance, maintaining positive drainage. Pipe PERMANENT SEEDING SUMMARY E. METHODS OF SEEDING 10.5615 acres staples at top and mid section and shall meet the following requirements for Total area of site.. installed through the stabilized construction entrance shall be protected with a i. Hydroseeding: apply seed uniformly with hydroseeder (slurry includes seed and fertilization), mountable berm with 5:1 slopes and a minimum of 6" of stone over the pipe. Pipe has Total disturbed area.. 298,000 sq. ft. to be sized according to the drainage. When the SCE is located at a high spot and broadcast or drop seeder or a cultipacker seeder. 28,300 cu. yds. approximate cut. has no drainage to convey a pipe will not be necessary. Pipe should be sized a. If fertilizer is being applied at the time of seeding, the application rates amounts shall not SEEDING DATES 28,300 cu. yds. approximate fill.. according to the amount of runoff to be conveyed. A 6" minimum will be required. Test: MSMT 509 exceed the following: nitrogen; maximum of 100 lbs. per acre total of soluble nitrogen; Tensile Strenath 50 lbs/in (min) 0 cu. yds. 6. Location - A stabilized construction entrance shall be located at every point TALL FESCUE TALL FESCUE 3/1 \ 5/15 8/15 \ 11/15 Tensile Modulus 20 lbs/in (min.) Test: MSMT 509 p205 (phosphorous): 200 lbs/ac; k20 (potassium): 200 lbs/ac. where construction traffic enters or leaves a construction site. Vehicles leaving 0.3 gal/ft /minute (max.) Test: MSMT 322 the site must travel over the entire length of the stabilized construction entrance. b.Llime - Use only ground agricultural limestone (up to 3 tons per acre may be applied by (Cut and fill are estimates only, contractor shall verify during the bid process) Test: MSMT 322 Filtering Efficiency 75% (min.) hydroseeding). Normally, not more than two tons are applied by hydroseeding at (Cut and fill do not include compaction) MARYLAND DEPARTMENT OF ENVIRONMEN WATER MANAGEMENT ADMINISTRATION S. DEPARTMENT OF AGRICULTURE any one time. Do not use burnt or hydrated lime when hydroseeding. c. Seed and fertilizer shall be mixed on site and seeding shall be don immediately and without CARROLL COUNTY SOIL CONSERVATION DISTRICT THE DEVELOPMENT IS APPROVED FOR SOIL EROSION AND SEDIMENT CONTROL BY THE CARROLL SOIL CONSERVATION DISTRICT. 450 / 86 Bankers Trust Co. Trustee c/o Balt. Gas & Electric Carroll SCD CERTIFY THAT THIS PLAN OF SOIL EROSION AND SEDIMENT CONTROL IS DESIGNED WITH M PERSONAL KNOWLEDGE OF THE SITE CONDITIONS AND HAS BEEN DESIGNED TO THE STANDARDS AND SPECIFICATIONS ADOPTED BY THE CARROLL SOIL CONSERVATION DISTRICT. 10875/300 **DEVELOPER / OWNER** Dorothy M. Thomas & Stacey Lee Rodriguez ETAL 20' DRAINAGE & UTILITY -Sykesville, Maryland 21784 IMPLEMENTED TO THE FULLEST EXTEND AND ALL STRUCTURES WILL BE INSTALLED TO THI EASEMENT Zoned: I-1 Light Industrial DESIGN AND SPECIFICATIONS, AS SPELLED OUT IN THIS PLAN, AND THAT ANY RESPONSIBL FOR THE CONTROL OF SOIL EROSION AND SEDIMENT BEFORE BEGINNING THE PROJECT. I ALSO AUTHORIZE PERIODIC ON-SITE EVALUATION BY THE CARROLL SOIL CONSERVATION DISTRICT PERSONNEL AND COOPERATING AGENCIES. wner / Developer 11270/359 5214 KLEE MILL ROAD, LLC Tax Map 68, Parcel 470 Plumbridge LLC rinted Name of Developer Deed Book 10121, page 90 Lot 3B - PROP. PRE-TREATMENT FAST 3.0 Plat Book 51, page 148 Development Comapny "Central Maryland Service and Distribution Center" 5214 Klees Mill Road 9.649 Acres (per Plat) Developer Phone # PHASE 1 SEDIMENT CONTROL, GRADING ONLY PERMIT #S-06-019GO Sediment Controls for mass grading of this project are currently in place, and were installed under Grading Only Permit #S-06-019GO, dated April 2008. The purpose of this plan is to indicate any final adjustments to the current "Phase 1" Sediment EXISTING 90' GRADING AND Control installations that are required on order to complete the final grading and DRMWATER MANAGEMENT EASEMENT remaining construction work. BOOK 5657, PAGE 474 REVISIONS SEDIMENT AND EROSION CONTROL NOTES All erosion/sediment control measures shall comply with the "maryland standards and specifications for soil erosion and sediment control" by the maryland department of the environment, water management administration in association with the natural resources conservation service and the state soil conservation BPR, LLC Job No. 23-1212 committee (referenced as the 94 standards and specs). L 11270, F_303 2. Areas that have been cleared and/or graded, but will not be constructed on or permanently vegetated for Date: November 11, 2024 more that 14 days (7 days for steep slopes) must be stabilized with mulch or temporary stabilization. Any areas that are in temporary vegetation for over one year will need to be permanently vegetated. SEDIMENT CONTROL PLAN, NOTES & DETAILS 3. For specifications on permanent or temporary stabilization, see G-20. 4. Mulching can only be used on disturbed areas as a temporary cover where vegetation is not feasible LOT 3B, SECTION ONE Cap Set or where seeding germination cannot be completed because of weather conditions. for specifications see ALL ROADS TRUCK BODIES (FORMERLY KLEIN'S WAREHOUSE FACILITY) G-20, Section 1-F, G, & H. 5. For specifications on the stabilization of cut and fill slopes greater than 3 horizontal to 1 vertical, see G-20, TAX MAP - 68 GRID - 13 PARCEL - 470 Surveyed By 6. The existing topsoil from on or off site that is used must meet the minimum specification in G-21 7. The required sequence of construction must be followed during site development. Any changes in the sequence of BPR **SEDIMENT TRAP #1** SOIL IDENTIFICATION construction must be approved by the soil conservation district. Computed By 8. Any revisions to the sediment control plan, not covered under the list of plan modification that can be approved Drainage Area 9.64 ad HSG by the sediment control inspector, need to be submitted to the soil conservation district for approval. **LAND SURVEYING & CIVIL ENGINEERING** AEH / EDA Storage Required 34,700 cf 9. No proposed slope shall be greater than 2:1. GdC, GdB, MaC Storage Provided 34,700 cf 150 Airport Drive, Suite 4 Drawn By 10. All sediment control structures will be inspected once a week and after each rainfall and will be repaired, as Bottom Trap Elev. 673.0 ft Westminster, Maryland 21157 UrB needed, so that the structure meets the minimum specifications as shown in the 94 standards and specs. JWF / EDA Rebar with / Weir Crest Elev. 678.2 ft 410 - 857 - 9030 11. The contractor is responsible for maintaining all sediment and erosion control measures until the disturbed areas Cap Set 5.2 ft. Storage Depth Checked By are permanently stabilized. INFO@BPRSURVEYING.COM 676.04 ft Wet Storage Elev. 12. The district approval for this sediment control plan is good for 2 years. at the end of 2 years, if construction of the 674.52 ft. Cleanout Elev. plan has not started, the plan will need to be resubmitted to the soil conservation district for review and re-approval. Top of Dam 680.0 ft Carroll County File No. S - 24 - 0022 Any plans that are currently under construction after 2 years may be required to be resubmitted to the 40.0 ft. Weir Length Soil Conservation District by the Sediment Control Inspector. Sheet 5 of 14

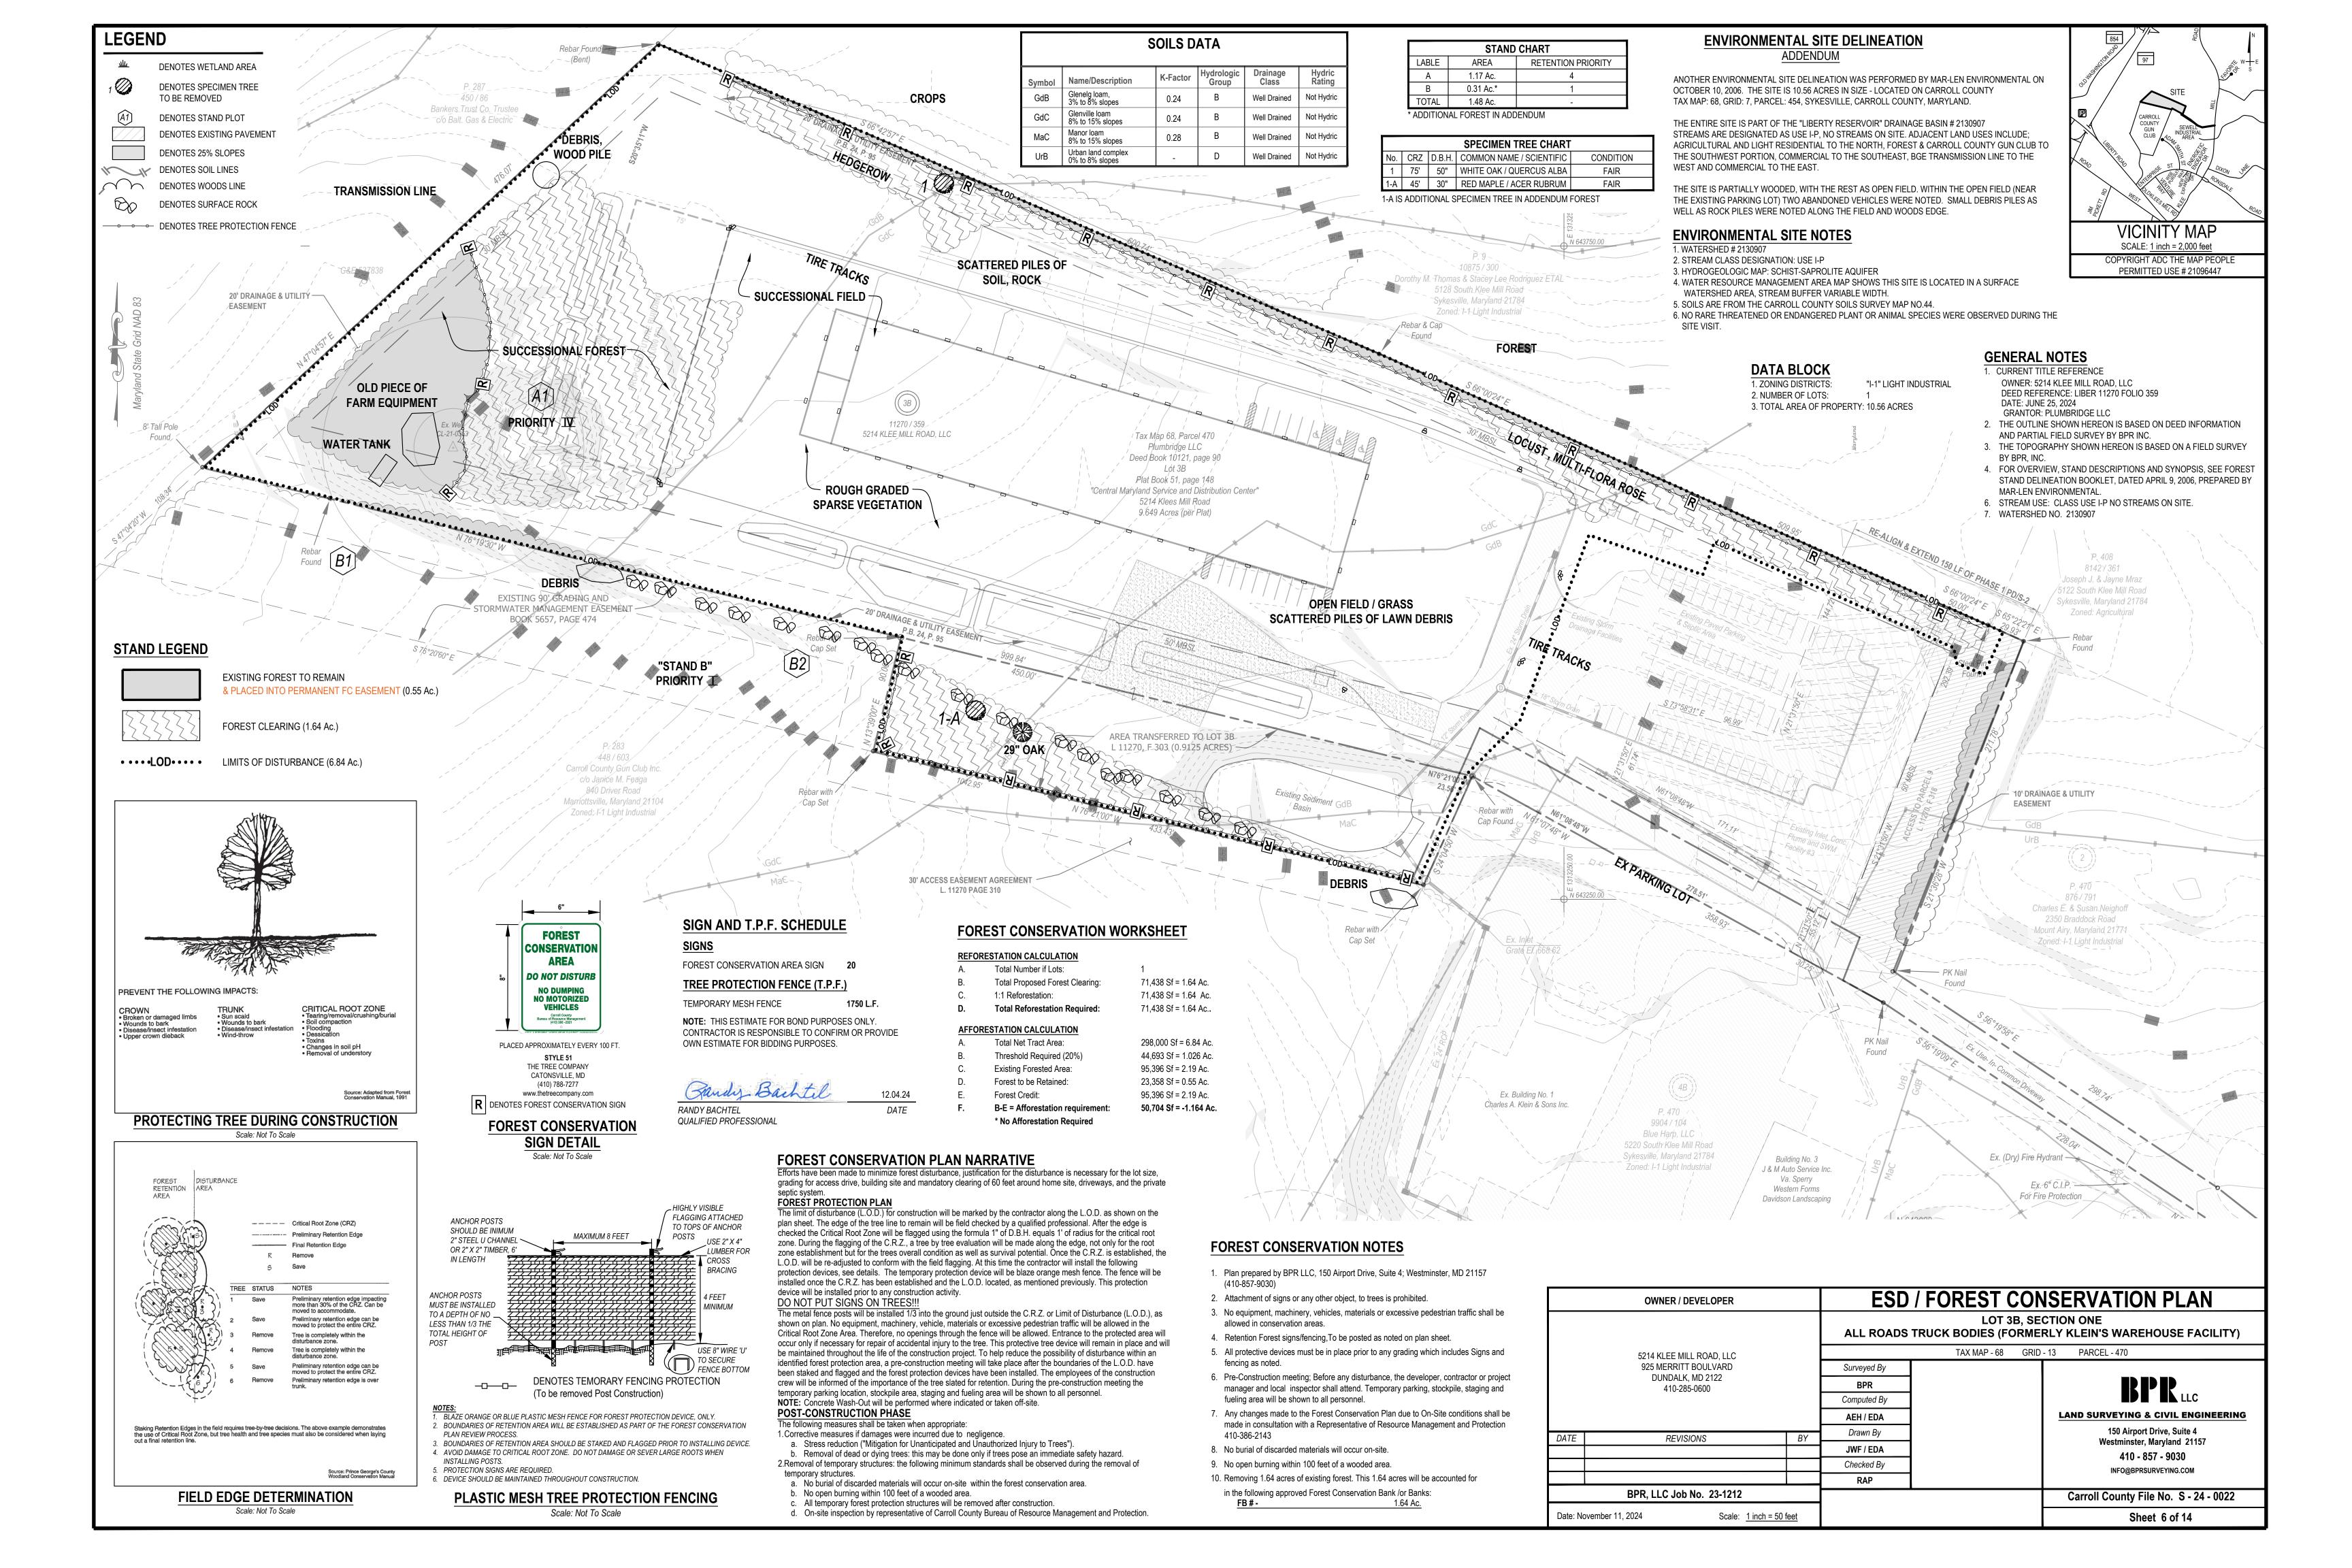

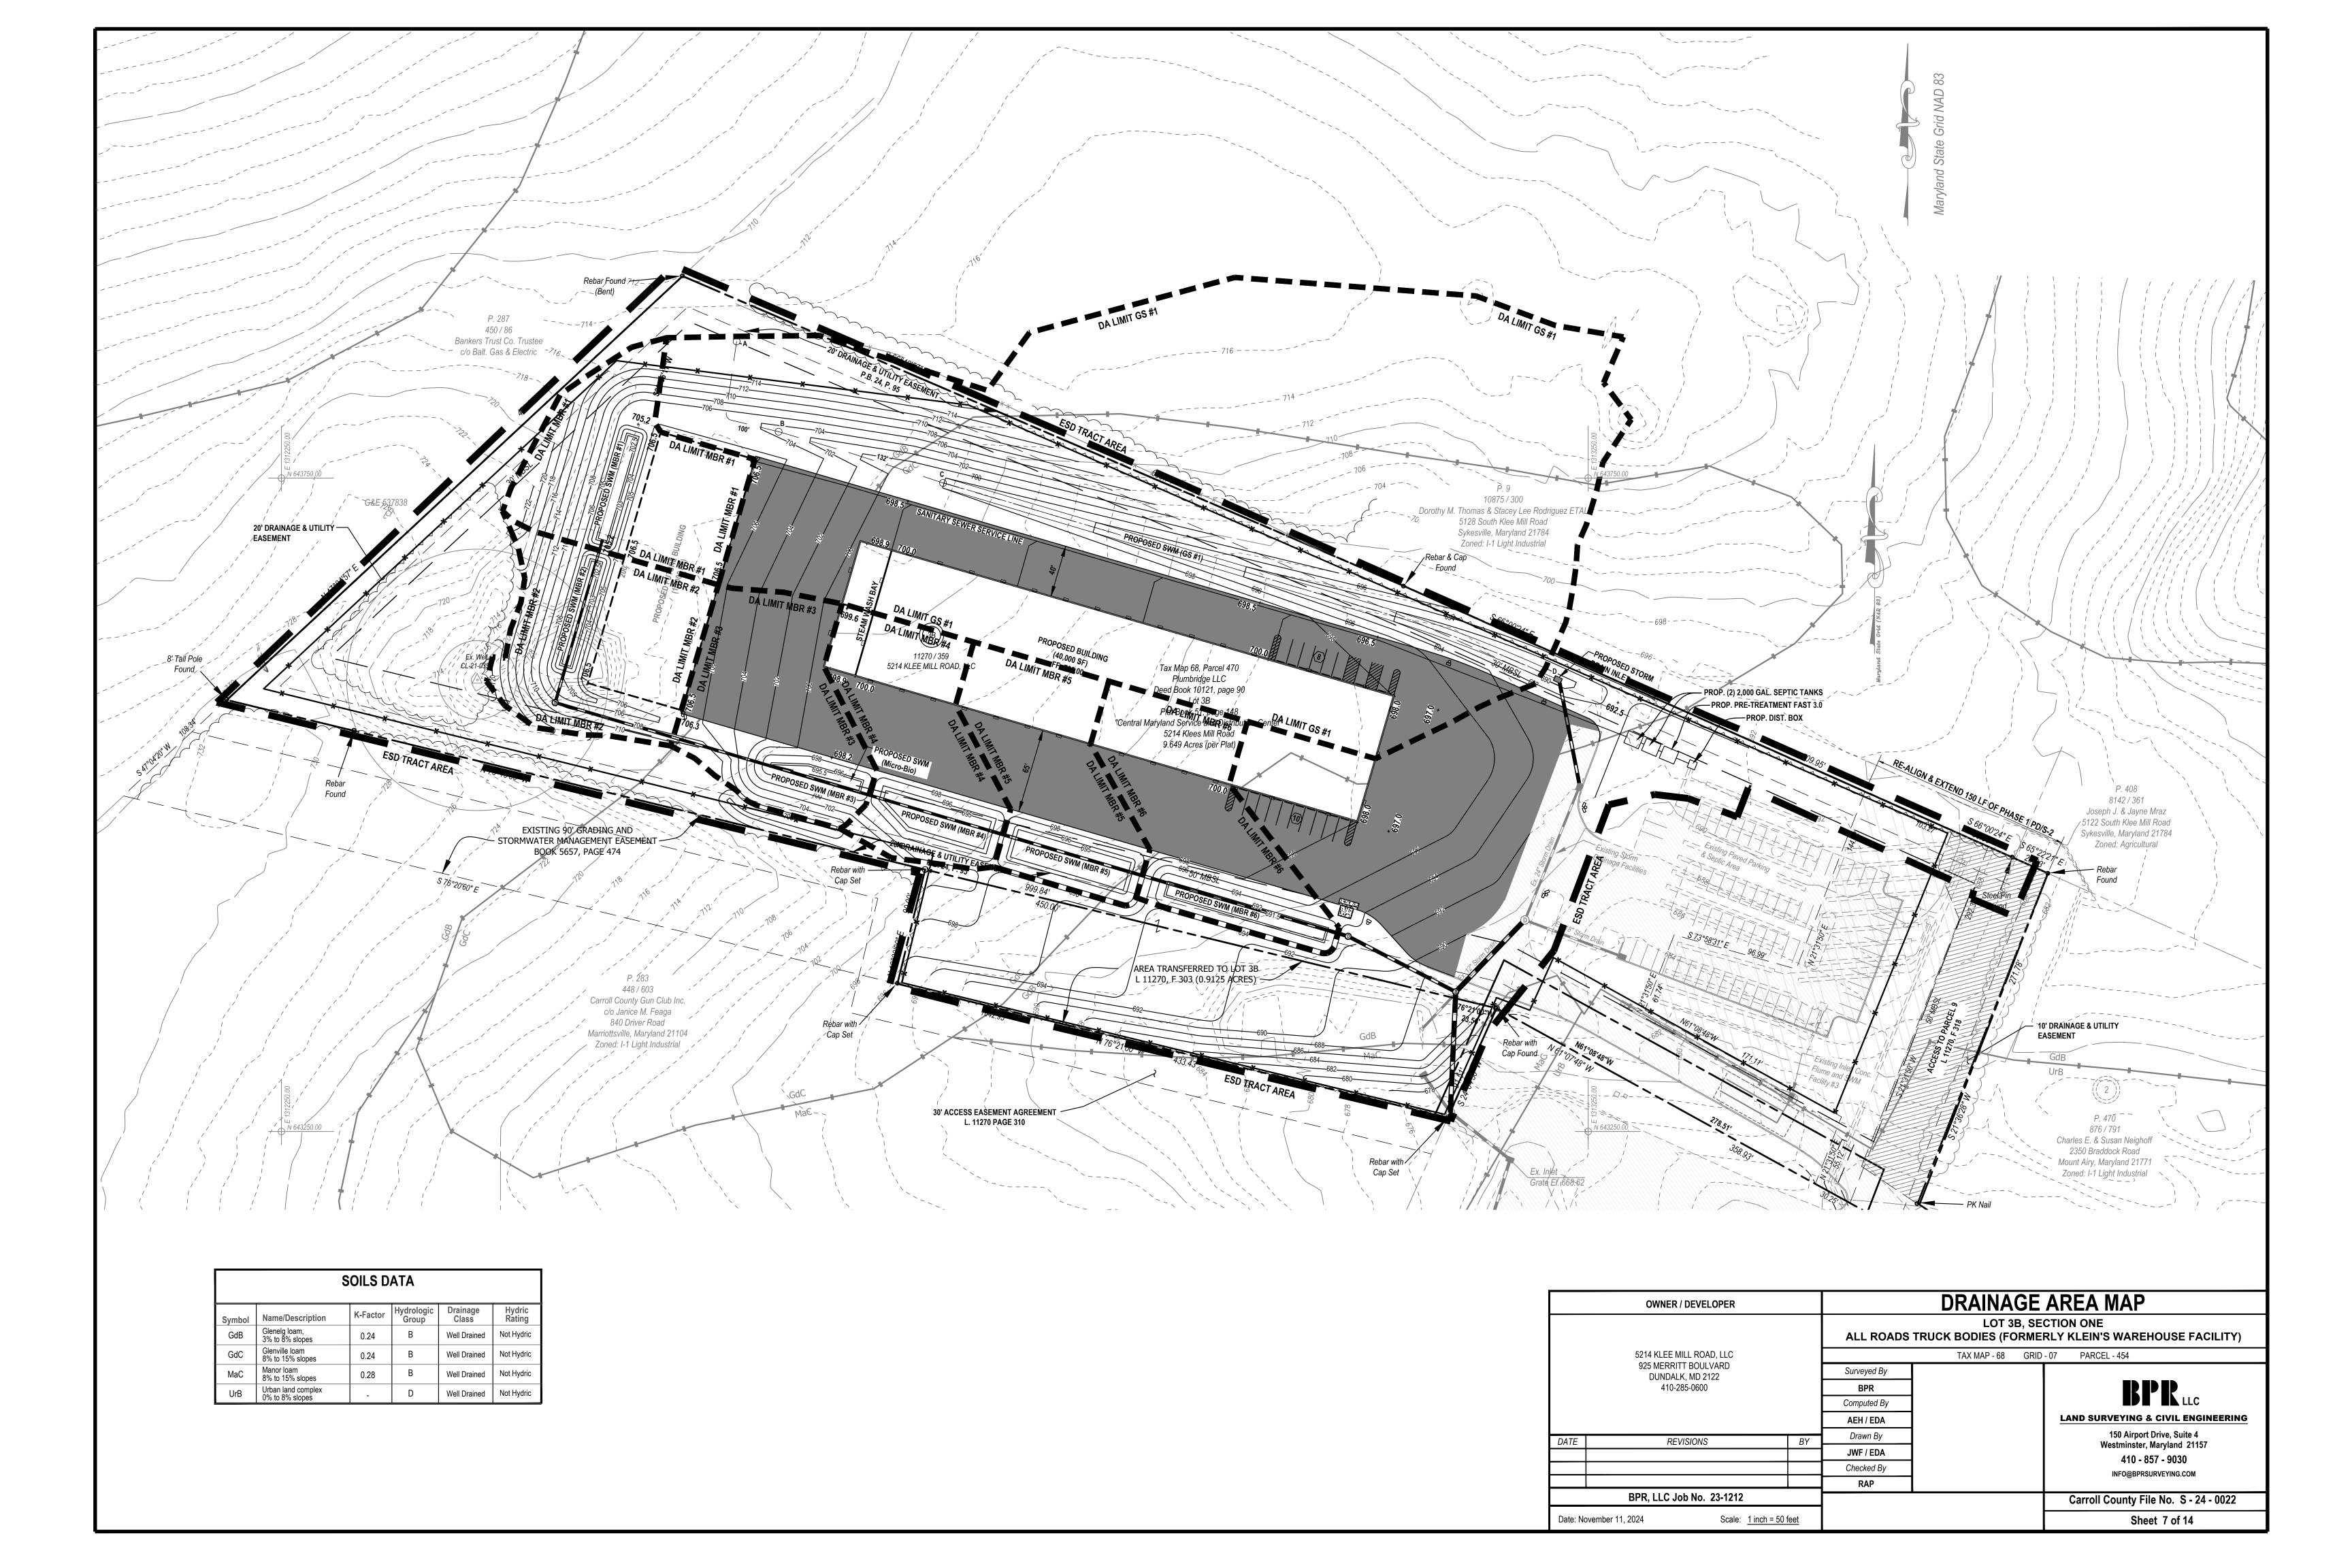


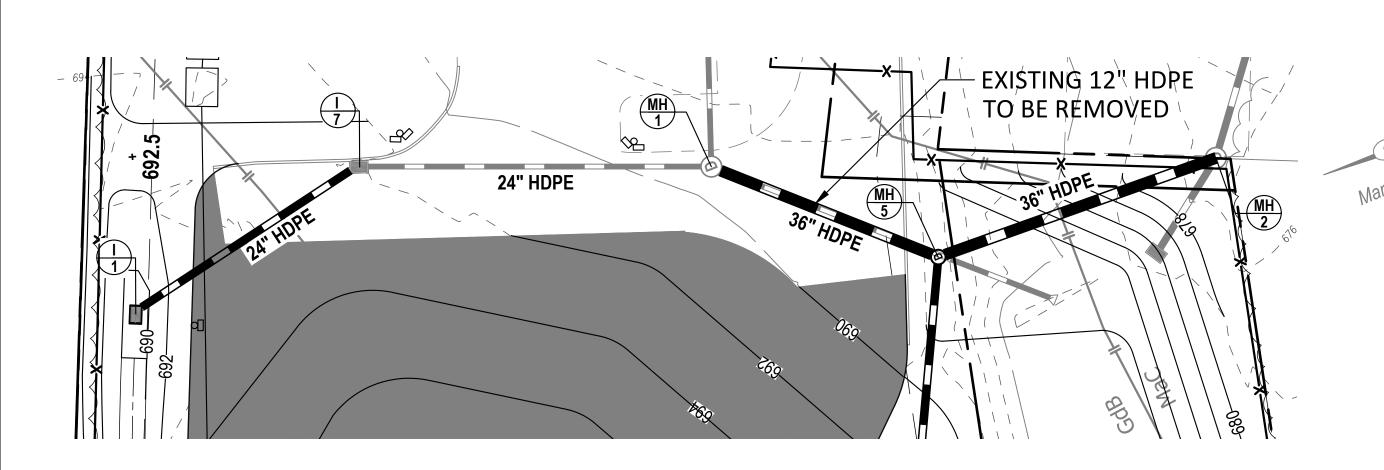


PLAN - INLET 1 - MANHOLE 2 SCALE: 1" = 30'

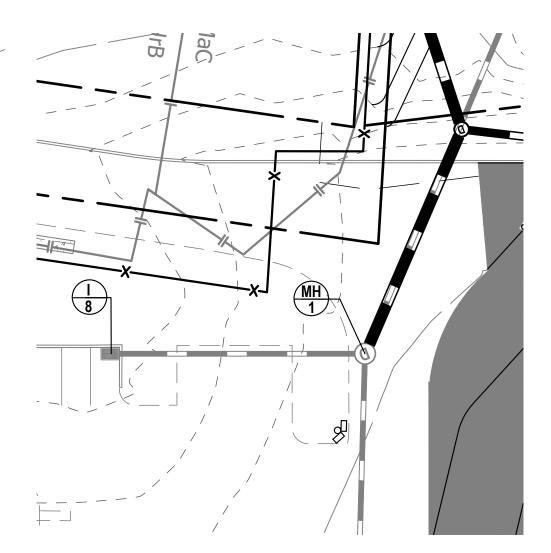

PLAN - INLET 8 - MANHOLE 1
SCALE: 1" = 30'

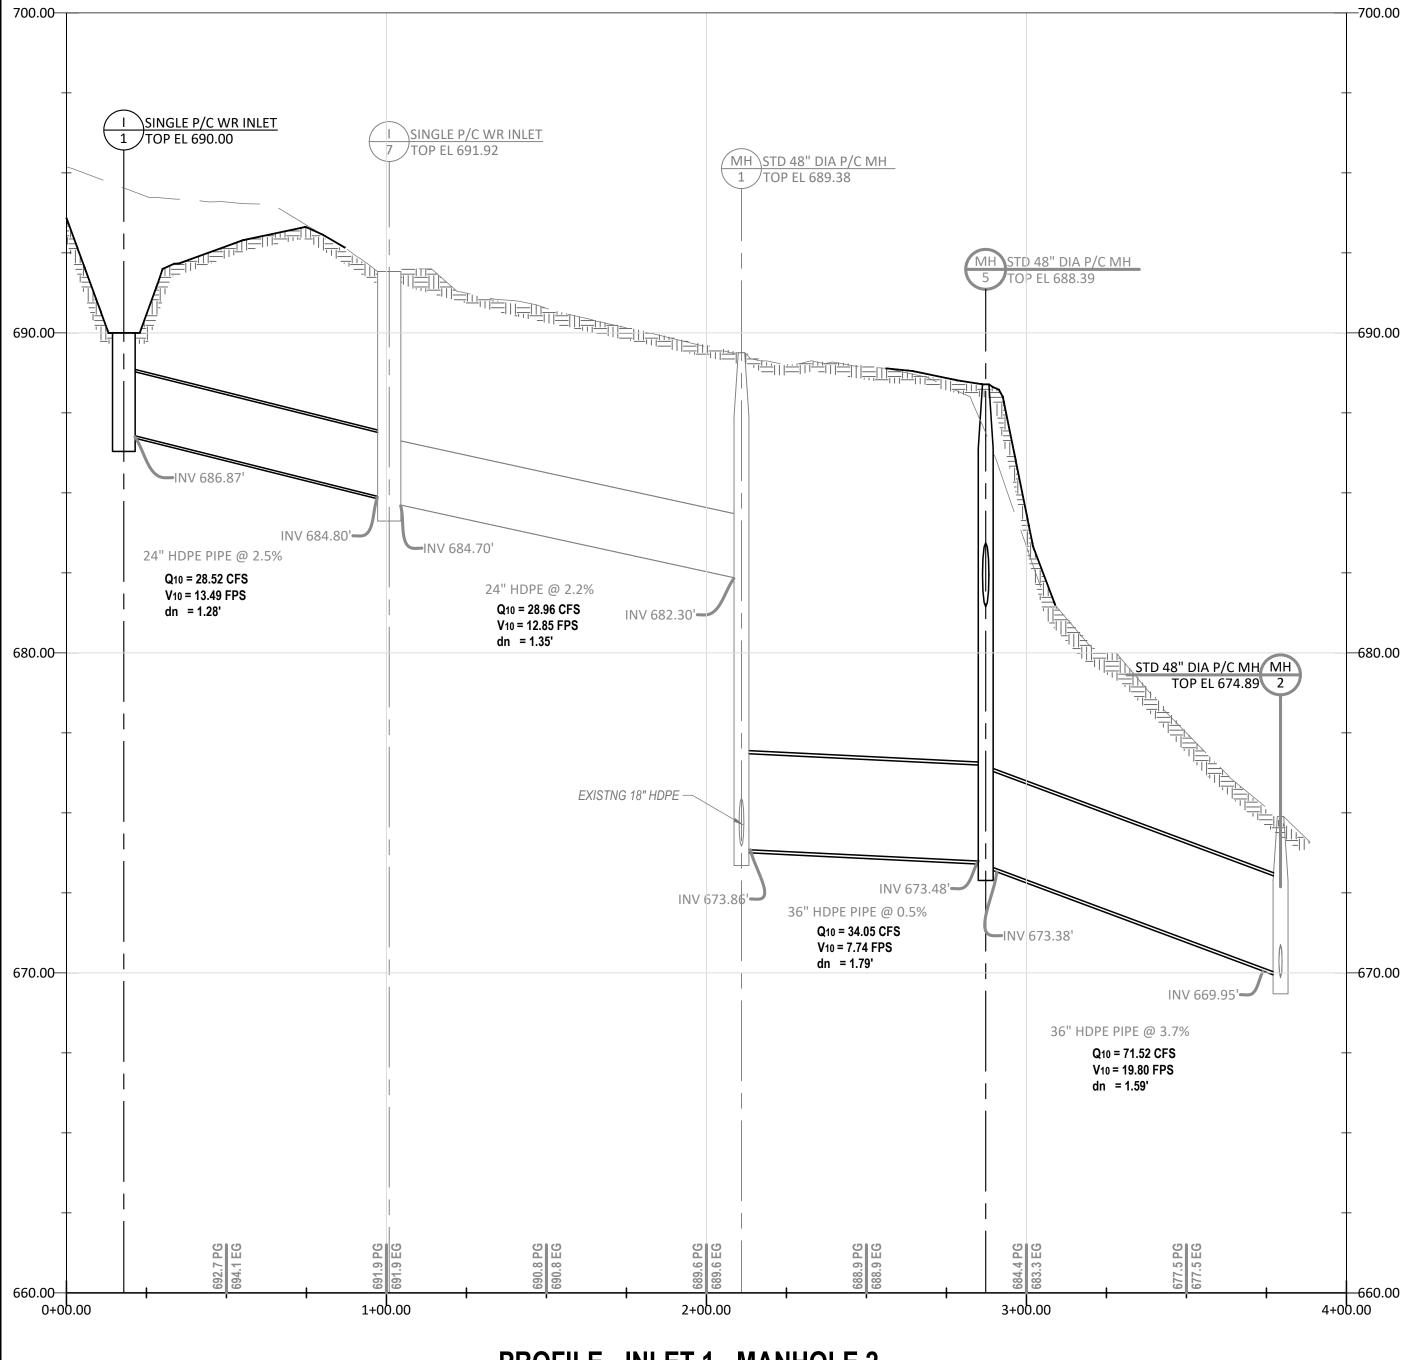

PROFILE - INLET 1 - MANHOLE 2 SCALE: H: 1" = 30' V: 1" = 10'

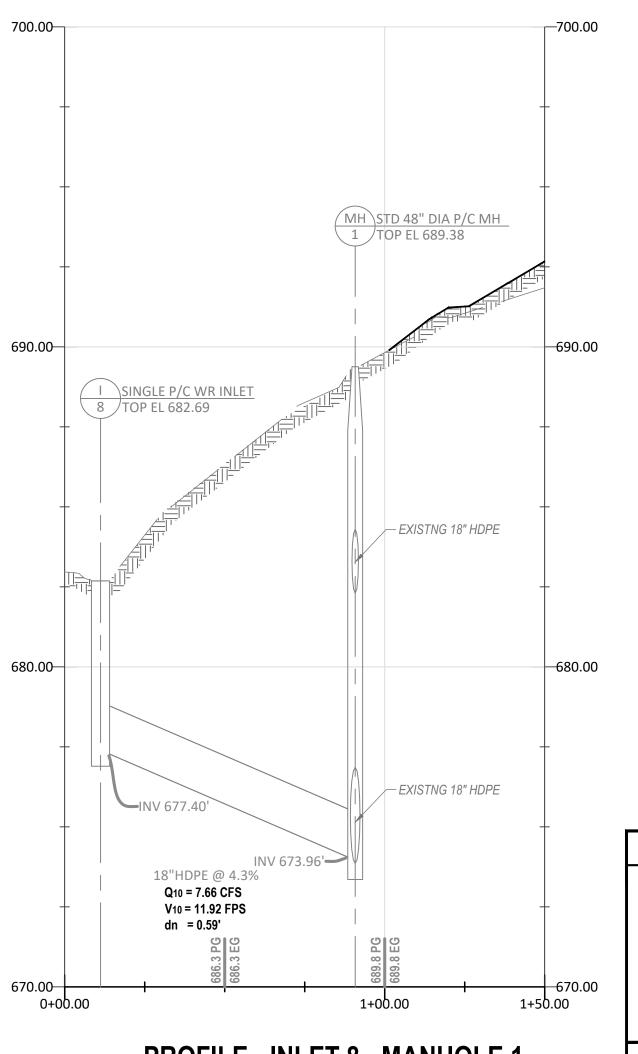

PROFILE - INLET 8 - MANHOLE 1
SCALE: H: 1" = 30' V: 1" = 10'

SWM STORM SEWER DESIGN: 10-Yr Storm & 130% 10-Yr Storm

Substitute Spreadsheet for Forms: SHA 61.1-492 & Carroll Cnty B-2

DESIGN BY: Randall A. Petkus, P.E.

STRUC	TURE	CONTRIBUTING A	REA			10	YEAR R	UNOFF				PIPE	1						
						Time	Rainf					Mann			Norm	Norm	Pipe		
		Subarea				Conc	Inten	Runoff	Q10	Size	Mat'l	Coef	Slope	Len	Depth	Veloc	Flow	Pipe	Capac
From	To	Ident.	CA	T_C	CA+	Tc+	I10	Q10	x 1.3	D	Type	n	So	L	dn	Vn	Q	Time	Qfull
			(ac)	(min)	(ac)	(min)	("/hr)	(cfs)	(cfs)	(in)			(' /ft)	(ft)	(ft)	(ft/s)	(cfs)	(min)	(cfs)
							***	R-1 TO	MH-5	***									
R-1	R-2	MBR1	0.46	5.0	0.46	5.0	7.00	3.20	4.16	15	HDPE	0.012	0.0100	100.0	0.69	5.95	4.16	0.28	7.0
R-2	MH-3	MBR2 (MBR1)	0.46	5.0	0.92	5.3	6.93	6.35	8.25	18	HDPE	0.012	0.0100	28.4	0.95	7.02	8.25	0.07	11.4
MH-3	R-3	(MBR1,MBR2)			0.92	5.4	6.91	6.33	8.23	18	HDPE	0.012	0.0125	171.5	0.88	7.66	8.23	0.37	12.7
R-3	R-4	MBR3 (MBR1, MBR2)	0.44	5.0	1.36	5.8	6.81	9.24	12.02	18	HDPE	0.012	0.0125	176.0	1.16	8.19	12.02	0.36	12.7
R-4	R-5	MBR4 (MBR1,MBR2,MBR3) MBR5 (MBR1,MBR2,MBR3,MB	0.42	5.0	1.78	6.2	6.72	11.94	15.52	21	HDPE	0.012	0.0125	111.5	1.19	8.88	15.52	0.21	19.2
R-5	R-6	R4) MBR6 (MBR1, MBR2, MBR3, MB	0.40	5.0	2.18	6.4	6.68	14.57	18.94	21	HDPE	0.012	0.0125	157.5	1.41	9.10	18.94	0.29	19.2
R-6	MH – 4	R4,MBR5) (MBR1,MBR2,MBR3,MBR4,M	0.44	5.0	2.62	6.7	6.61	17.35	22.55	24	HDPE	0.012	0.0125	16.2	1.38	9.74	22.55	0.03	27.4
MH – 4	MH-5	BR5,MBR6)		5.0	2.62	6.7	6.61	17.35	22.55	24	HDPE	0.012	0.0300	59.8	1.04	13.72	22.55	0.07	42.4

I-1 I-7	DA1	4.58 1	7.0 4.	58 17.0	4.79	21.94	28.52	24	HDPE 0.012	0.0250	82.9 1.28 13.49	28.52 0.1	0 38.7
I-2 MH-1	DA2 (DA1)	0.08 5	5.0 4.	66 17.1	4.78	22.27	28.96	24	HDPE 0.012	0.0220	110.0 1.35 12.85	28.96 0.1	4 36.3

*** I-8 TO MH-1 ***

I-3 MH-1 DA3 0.84 5.	0.84 5.0 7.00 5.89 7.66	18 HDPE 0.012 0.0430 79.7 0.59 11.92 7.66 0.11 23.6
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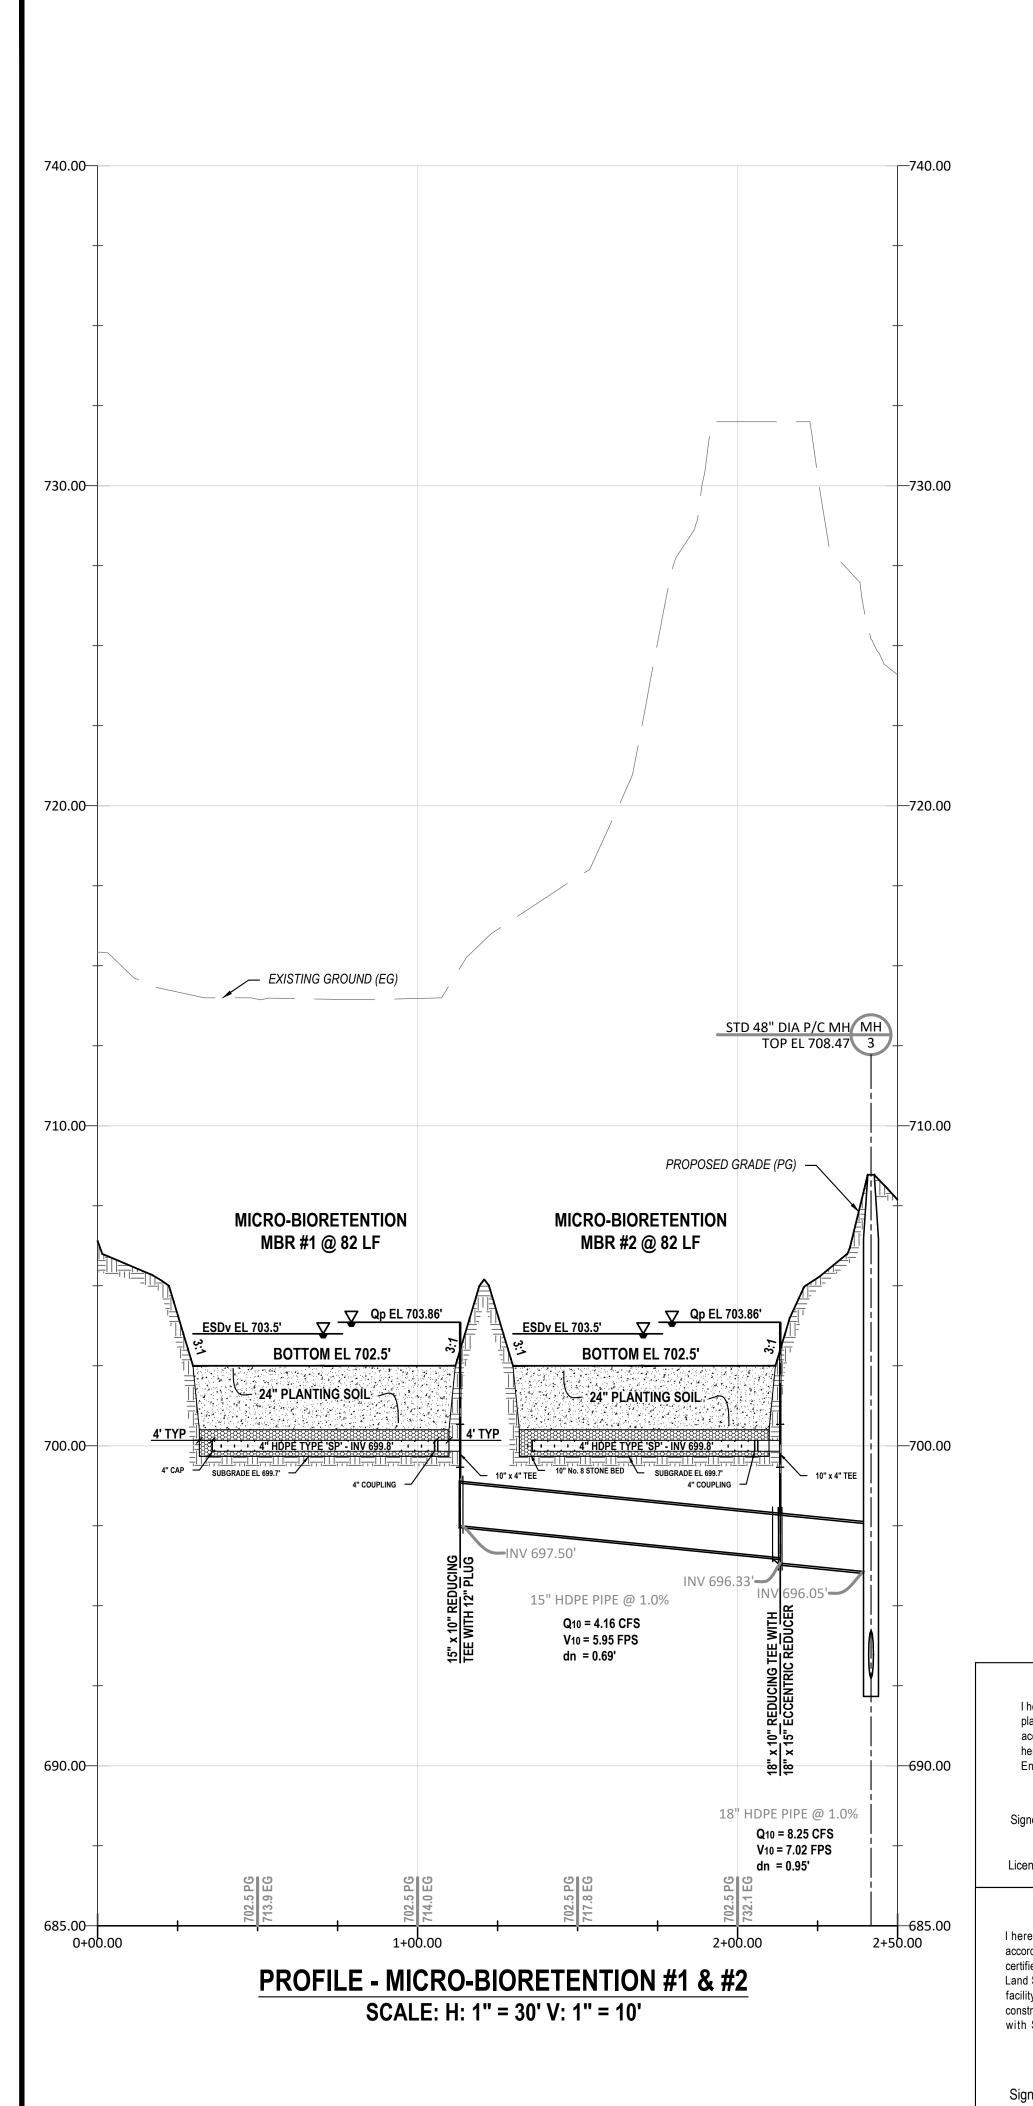
*** MH-1 TO MH-2 ***


MH-1	MH-5	(DA1,DA2,DA3)	0.00	5.0	5.50	17.2	4.76	26.19	34.05	36	HDPE	0.012	0.0050	76.3	1.79	7.74	34.05	0.16	51.1
		(DA1,DA2,DA3,(MBR1,																	
		MBR2,MBR3,MBR4,MBR5,																	
MH-5	MH-2	MBR6)	0.00	6.0	8.13	6.0	6.77	55.02	71.52	36	HDPE	0.012	0.0370	79.7	1.53	19.80	71.52	0.07	139.0

NOTES: The flows above are computed by the Rational Mehthod with a 1.3 factor increase for equivalent TR55 values.

	STORM DRAIN STRUCTURE SCHEDULE												
STRUCTURE NO.	TYPE	INV. IN ELEV.	INV. OUT ELEV.	BOTTOM ELEV.	TOP ELEV.	NORTHING	EASTING						
I1	MD 374.70		686.87	686.79	690.00	643595.3372	1313227.8592						
MH 3	MD 384.01	696.05	692.73	692.67	708.47	643578.2440	1312459.4856						
MH 4	MD 384.01	684.32	684.22	684.14	693.67	643399.3743	1313066.3063						
MH 5	MD 384.03	673.48 681.44	673.38	673.28	688.39	643356.8689	1313148.5969						

	OWNER / DEVELOPER			STORM DRAIN PL	AN AND PROFILE					
			ALL ROADS	LOT 3B, SECTION ONE ALL ROADS TRUCK BODIES (FORMERLY KLEIN'S WAREHOUSE FACILITY)						
	5214 KLEE MILL ROAD, LLC			TAX MAP - 68 GRID) - 07 PARCEL - 454					
	925 MERRITT BOULVARD		Surveyed By							
	DUNDALK, MD 2122 410-285-0600		BPR		BPR _{LLC}					
	410 200 0000		Computed By		LLC LLC					
			AEH / EDA		LAND SURVEYING & CIVIL ENGINEERING					
DATE	REVISIONS	ВУ	Drawn By		150 Airport Drive, Suite 4					
BATE	NE VIOIONO		JWF / EDA		Westminster, Maryland 21157 410 - 857 - 9030					
			Checked By		INFO@BPRSURVEYING.COM					
			RAP		IN OUS NOONVETING.OOM					
	BPR, LLC Job No. 23-1212		•		Carroll County File No. S - 24 - 0022					
Date: Novembe	er 11, 2024 Scale: <u>AS</u>	SHOWN_			Sheet 8 of 14					



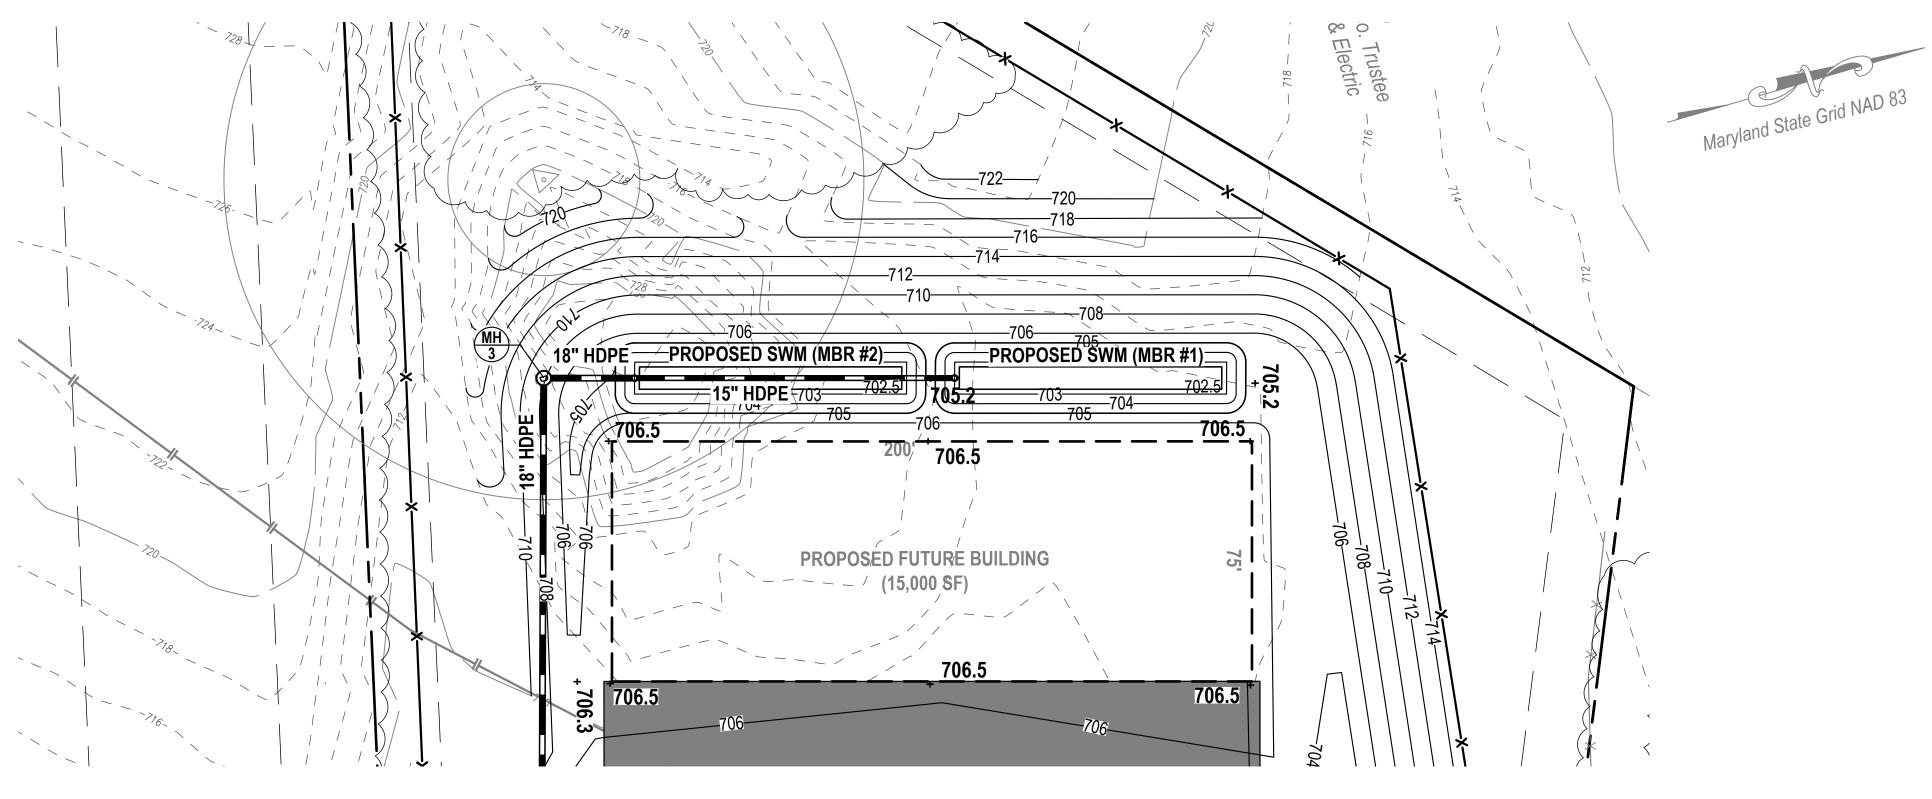

PLAN - MICRO-BIORETENTION #1 & #2 SCALE: 1" = 30'

Planting Mediun

The planting medium shall be 24"-48" thick and shall consist of 1/3 perlite or Solite, 1/3 compost and 1/3 topsoil. The perlite shall be coarse grade horticultural perlite. The compost shall be high grade compost free of stones and partially composted woody material. The topsoil component shall meet the following criteria: contain no more than 10% clay, 10-25% silt and 60-75% sand and be free of stones, stumps, roots or other similar objects larger than 2 inches.

The first layer of the planting medium shall be lightly tilled to mix it into the 6-inch sand layer, so as not to create a definitive boundary. The planting bed shall be flooded after placement. Any settlement that occurs shall be filled back to the design elevation.

Mulch

The mulch layer is an important part of the Micro-Bioretention device. Much of the pollutant removal capacity of the Micro-Bioretention system is within the mulch layer. The surface mulch layer will consist of standard double shredded aged hardwood mulch. The mulch should be applied uniformly to a depth of 3 inches. Yearly replenishing may be necessary. Pine bark is not acceptable.

ENGINEER'S "AS-BUILT" CERTIFICATION

I hereby certify that the facility/facilities shown on this/these plan(s) was constructed as shown on the "As-Built" plans and meets the approved plans and specifications. I also certify that this/these facilities were inspected in accordance with Sections § 136-22 and § 136-23 of the Charter and Code of the City of Westminster, MD and I hereby certify that these documents were prepared or approved by me, and I am a duly licensed Professional Engineer or Professional Land Surveyor, as appropriate, under the laws of the State of Maryland.

Signed:______ Date:_____

License No.:_____ Expiration Date:_____

DEVELOPER'S CERTIFICATION

I hereby certify that all proposed work shown on these construction drawing(s) will be conducted in strict accordance with these plans. I also understand that it is my responsibility to have the construction supervised and certified, including the submittal of "as- Built" plans certified by a registered Professional Engineer or Professional Land Surveyor, as appropriate, within thirty (30) days of completion of work on the stormwater management facility/facilities. I also certify that this/these stormwater management facility/facilities will be inspected during construction by a registered Professional Engineer or Professional Land Surveyor, as appropriate, in accordance with Sections § 136-22 and § 136-23 of the Charter and Code of the City of Westminster, MD.

Signed: _____ Date: _____

DAM BREACH STATEMENT The location of the impoundments of the Std M-5 Micro-Bioretention ESD Practices MBR #1, MBR #2, & MBR #3, do not represent undue risks to downstream properties or life and failure of the embankment will not result in loss of life or in damages that exceed the ability of the owner to pay.

Signed:______ Date:_____

Professional Engineer


License No.:_____ Expiration Date:_____

ENGINEER'S DESIGN CERTIFICATION

I hereby certify that these plans have been designed according to Chapter 136 of the Charter and Code of the City of Westminster, MD and I hereby certify that these documents were prepared or approved by me, and I am a duly licensed Professional Engineer or Professional Land Surveyor, as appropriate, under the laws of the State of Maryland.


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nse No.:	Expiration Date:	

	OWNER / DEVELOPER		MICRO-	BIORETENTION #1	I - #2 PLAN AND PROFILE
			ALL ROADS	•	CTION ONE RLY KLEIN'S WAREHOUSE FACILITY)
	5214 KLEE MILL ROAD, LLC			TAX MAP - 68 GRID) - 07 PARCEL - 454
	925 MERRITT BOULVARD		Surveyed By		
	DUNDALK, MD 2122 410-285-0600		BPR		BPR LLC
	410 200 0000		Computed By		LLC LLC
			AEH / EDA		LAND SURVEYING & CIVIL ENGINEERING
DATE	REVISIONS	BY	Drawn By		150 Airport Drive, Suite 4
DITTE	NE VIOLONO		JWF / EDA		Westminster, Maryland 21157 410 - 857 - 9030
			Checked By		INFO@BPRSURVEYING.COM
			RAP		IIII OGS. NOSKVETINO.SOM
	BPR, LLC Job No. 23-1212				Carroll County File No. S - 24 - 0022
Date: Novem	ber 11, 2024 Scale: <u>AS SH</u>	<u>IOWN</u>			Sheet 9 of 14

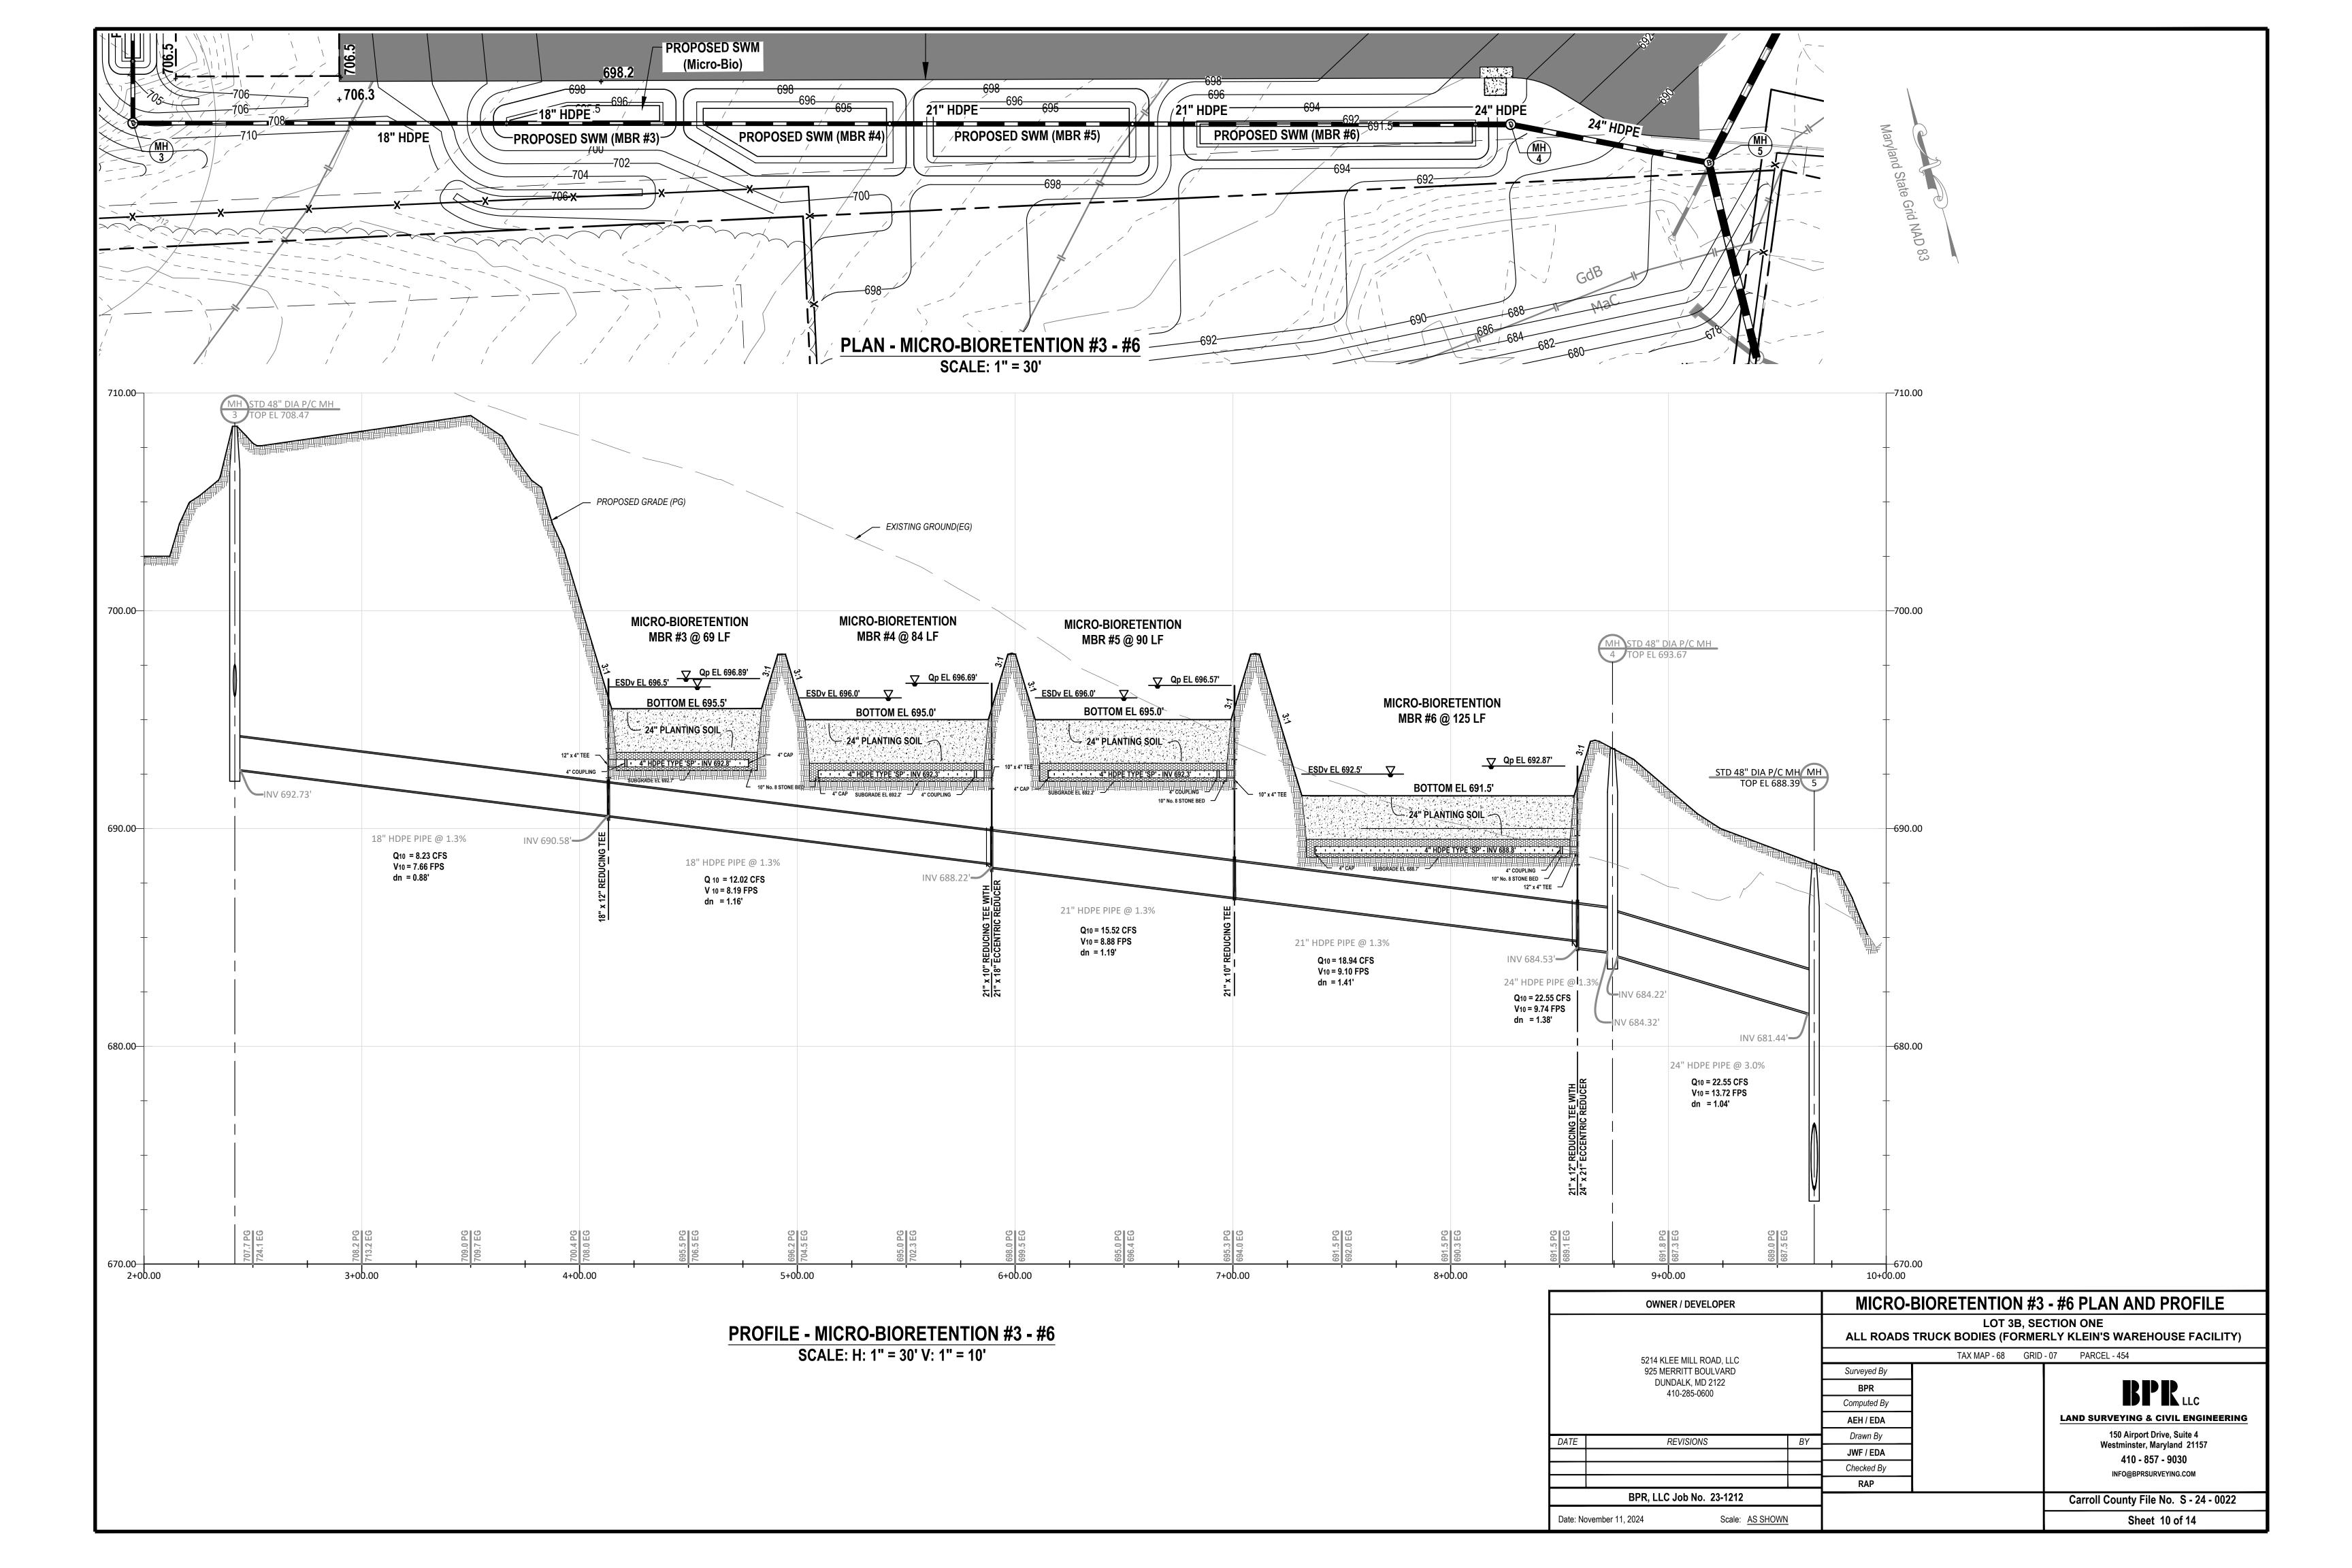

	M	BR #1	MI	BR #2	ME	BR #3	ME	3R #4	ME	BR #5	ME	3R #6
STAGE	INSPECT	INSPECTOR'S APPR.		INSPECTOR'S APPR.		INSPECTOR'S APPR.		OR'S APPR.	INSPECTOR'S APPR.		INSPECTOR'S APPR.	
	INITIALS	DATE	INITIALS	DATE	INITIALS	DATE	INITIALS	DATE	INITIALS	DATE	INITIALS	DATE
ENTIRE CONTRIBUTING DRAINAGE AREA TO THE MBR'S IS PAVED, ALL BUILDINGS CONSTRUCTED, AND MINIMUM 2" STAND OF DENSE GRASS IS ESTABLISHED ON ALL VEGETATED AREAS.												
BOTTOM, SIDE SLOPES, AND EMBANKMENT EXCAVATED AND FINE GRADED TO PLAN LINE AND GRADE.												
EMBANKMENT MATERIAL & COMPACTION IS AS SPECIFIED IN THE PLANS AND VERIFIED BY INSPECTION & TESTING FROM A GEOTECHNICAL ENGINEER.												
4" UNDERDRAIN PIPING AND NO. 8 STONE BEDDING PLACED. RISER PIPE EXTENDED TO WEIR ELEVATION AND UNDERDRAIN PIPE CONNECTED TO RISER.												
EMBANKMENT RESTORED AND FINAL GRADING COMPLETED. PLANTING SOIL PLACED AND BIO-RETENTION PLANTINGS COMPLETED AND MULCHED. DOWNSPOUTS LEADER PIPES ENTER ON LEVEL SLOPE & SPLASH BLOCK PLACED.												
ALL REMAINING DISTURBED VEGETATED AREAS STABILIZED WITH A 2" STAND OF DENSE GRASS.												
A SIGNED AND CERTIFIED AS-BUILT PLAN SUBMITTED TO THE CARROLL COUNTY BUREAU OF RESOURCE MANAGEMENT.												

MATERIAL	SPECIFICATION	SIZE	NOTES
Plantings	See Landscape Plan	N/A	Plantings are Site Specific and per Approved Landscape Plan
Seed Mix	Filter Bed Mix - Use Wet Meadow Mix per MD Standards and Specifications 707. See Table 3 (lb. min / micro-bioretention)	N/A	Used with Straw Mulch in Place of Shredded Hardwood Mulch.
Mulch	Shredded Hardwood	N/A	Aged 6 Months, Minimum.
Straw Mulch	MD Standards and Specifications 707. (200 lb. min / micro-bioretention)	N/A	Straw Mulch over seed bed.
Geotextile	Class "C" - Apparent Opening Size (ASTM -D-4751), Grab Tensile Strength (ASTM -D-4632), Puncture Resistance (ASTM-D-4833)	N/A	Sides Only. Not on Bottom Unless Specified on the Plans.
Underdrain Gravel	AASHTO M-43 No. 8 Stone	3" - 1"	Stone must be clean and washed
Underdrain Piping Riser Pipes	Slotted PVC or Slotted HDPE Type "SP" Pipes. Solid: Schedule 40 PVC or HDPE Type "S".	See Plan	Refer to Carroll County SWM Supplement Pg 87. All pipes must be double walled (smooth core) and slotted(no circular holes).
Sand	ASTM C-33 (3 Parts to 6 within Filter Media)	0.02" - 0.04"	Sand Substitutes such as Diabase and Graystone #10 are not Acceptable. No Calcium Carbonate & Dolomitic Sands Substitutions are Acceptable. No "Rock Dust" can be used for Sand. Manufactured Sand from approved sources may be used for filters. Manufactured sand may not be used in Dams.
Soil	Engineer Approved Loam with 20% or less Clay (1 Part to 6 within Filter Media)	N/A	
Wood Chips	Untreated "Green" (2 Part to 6 within Filter Media)	N/A	Untreated "Green" Wood Chips
Filter/Planting Media	Comprised of 3 Parts Sand, 2 Parts Wood Chips, 1 Part Soil	N/A	See Individual Materials Specifications.
Embankments & Trench Backfill (non-378)	Soils used for embankments and trench backfill shall be uniform and in accordance with MD 378 Code, except that fill material shall conform to Unified Soil Classification, GC, SC, SM, MH, ML, CH, or CL and be compacted to a density of not less than 95% of maximum dry density. Woody vegetation is prohibited on embankments.	N/A	See Earth Fill and Structure Backfill, Carroll County Construction Specifications Carroll County SWM Supplement, Page 130
Principal Spillway Pipe (non⊡378)	Shall be in accordance with MD 378 Code, except that all pipe joints are to be gasketed and completely watertight. Pipes connected to risers (inlets) shall be a single piece 20-feet long with no joints.	N/A	See Pipe Conduits, Carroll County Construction Specifications Carroll County SWM Supplement, Page 131

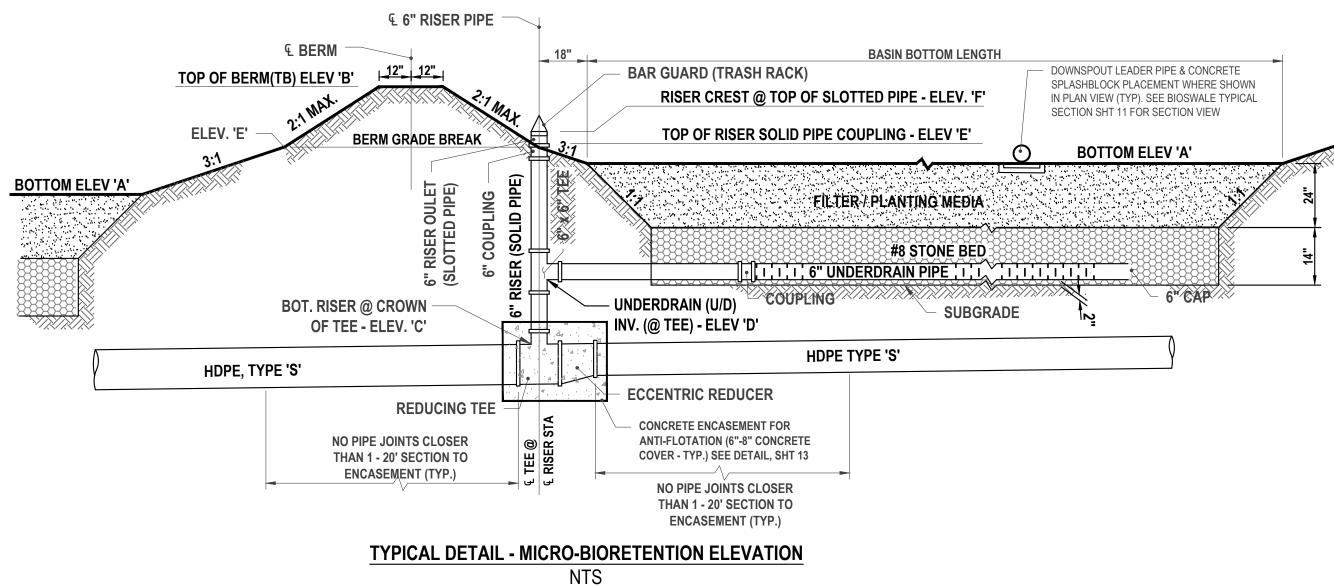


STORMWA	ATER MAINTENANCE SO	CHEDULE - GRASS SWALE									
Inspection Item	Inspection Requirements	Remedial Action									
Debri and Trash	Check for trash and debris in channel, including inlets, outlets, and area around facility.	Remove all trash and debris and dispose in an acceptable manner. Unclog all openings.									
Grass Cover	Grass in swale must be maintained at a height of 4 to 6 inches. Check for channelizing and bare spots.	Mow side slopes when grass exceeds 12 inches in height. Mow channel at least bi-annually. Remove grass clippings. Re-plant with topsoil, seed, and matting.									
SEASONAL INSPECTION AND AFTER A MAJOR STORM											
Inspection Item	Inspection Requirements	Remedial Action									
Sediment Accumulation	Check for accumulated sediment and clogged openings	When sediment accumulates to 2 inches in depth, remove sediment. Remove sediment from any clogged openings. Dispose of all sediment in an acceptable location.									
Erosion	Check inflow, channel, outfall, and side slopes for evidence of erosion, rills, gullies, and runoff channelization.	Re-plant with topsoil, seed, and matting. Re-grade if concentrated runoff to the facility is causing rills or gullying. Grade, vegetate, and/or armor to provide stabilize facility in accordance with approved plans.									
	ANNUAL INSPECTIO	ON .									
Inspection Item	Inspection Requirements	Remedial Action									
Maintenance Access	Check for accessibility to facility.	Prevent excessive vegetative growth, erosion, and obstructions on access way.									
Overall Function of Facility	Check that flow conveyance is operating as designed	Repair to good condition according to specifications on the approved plans.									


STD M-8 GRASS SWALE		
INSPECTION CHART		
STAGE	INSPECTOR	R'S APPROVA
	INITIALS	DATE
1. GRASS CHANNEL STAKED OUT PER PLAN LINE & GRADE.		
2. SWALE BOTTOM & SIDE SLOPES, EXCAVATED TO SUBGRADE.		
3. PLACEMENT OF 3" TOPSOIL, SEED & MULCH STABILIZATION IN GRASS SWALE.		
4. ALL VEGETATED DISTURBED AREAS ARE STABILIZED WITH A 2" STAND OF DENSE GRASS.		
5. SIGNED AND CERTIFIED AS-BUILT PLAN SUBMITTED TO THE CARROLL COUNTY BUREAU OF RESOURCE MANAGEMENT WITHIN 60 DAYS OF COMPLETION OF CONSTRUCTION.		
*Please notify the certifying professional, E 410-857-9030 48 hours prior to commencing		ıction
SEQUENCE OF CONSTRUCTION 1. Once the individual house has been construct lot grading is complete, contact the certifying Engineer/Professional Land Surveyor, BPR I (410)-857-9030. After the certifying Professinis/her approval, proceed as follows. 2. Excavate the Swale subgrade to plan line & grading topsoil on Swale bottom and side significant stabilize with permanent grass seed & mulch and the once the entire contributory area to the gras stabilized with pavement or a 2" stand of grading as-built certification to the Carroll County Build Management for bond release.	profession of the control of the con	onal given I is it an




- The Stormwater Management Facility/Facilities shown on these plans shall be constructed and maintained by the owner(s).
- Owner/his heirs or assigns shall be responsible for continuing maintenance of the facility/facilities, which shall include such items as mowing, cleaning and removing sediment, trees, shrubs and debris. Requirements and schedules for specific types of facilities and practices as listed on the plans are hereby included. The time period for this continuing maintenance shall be on "as-needed" basis but shall not be delayed longer than thirty (30) days.
- 3. Owner, his heirs or assigns shall be responsible for any structural damages or failure which may occur as a result of negligence, accident or misuse. In the event of structural damage, owner shall be responsible to make the necessary repairs as quickly as possible but in any case within thirty (30) days.
- 4. If after notice by the City to correct a violation requiring maintenance work, satisfactory corrections are not made by the owner(s) within (30) days the City may perform all necessary work to place the facility in proper working condition. The owners of the facility shall be assessed the cost of the work and any penalties. These monies shall be collected from a bond, which the developer is required to post with the City to cover such expenses until "completion of the facility". "Completion of the facility" is construed to mean that all contributory drainage areas are paved or supporting a 2" stand of dense grass and that the Carroll County Bureau of Resource Management has inspected construction and a registered professional engineer has certified that the "As-Built" plans meet the plans and specifications for construction. After "completion of the facility" the moneys may be collected by placing a lien on the property, or by including the costs and penalties on the property tax bill and collecting them as ordinary taxes by the City.
- Owner(s) shall grant right of entry to authorized City personnel for purposes of inspection monitoring and/or repair. Site visits for inspection and/or monitoring shall be conducted only during normal City working hours (8:00a.m. to 5:00p.m. Monday - Friday).
- This agreement including right-of entry for inspection/maintenance and repair shall be recorded in the Land Records of the County.

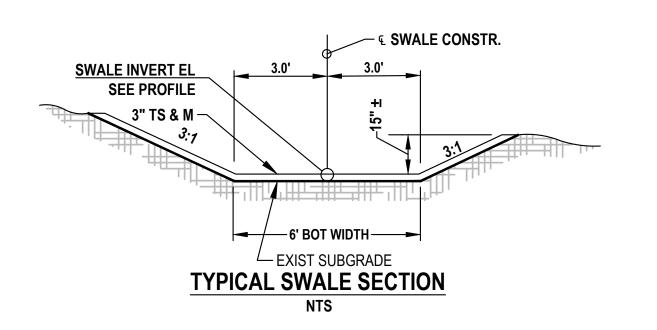

OWNER / DEVELOPER		STORMWATER MANAGEMENT NOTES & DETAILS				
5214 KLEE MILL ROAD, LLC 925 MERRITT BOULVARD DUNDALK, MD 2122 410-285-0600		LOT 3B, SECTION ONE ALL ROADS TRUCK BODIES (FORMERLY KLEIN'S WAREHOUSE FACILITY)				
		TAX MAP - 68 GRID - 07 PARCEL - 454				
		Surveyed By				
		BPR	BPR Computed By			
		Computed By				
		AEH / EDA		LAND SURVEYING & CIVIL ENGINEERING		
DATE REVISIONS	BY	Drawn By		150 Airport Drive, Suite 4		
NEVIOLOTO		JWF / EDA		Westminster, Maryland 21157 410 - 857 - 9030		
		Checked By		INFO@BPRSURVEYING.COM		
		RAP				
BPR, LLC Job No. 23-1212	•		Carroll County File No. S - 24 - 0022			
Date: November 11, 2024 Scale: AS SH			Sheet 11 of 14			

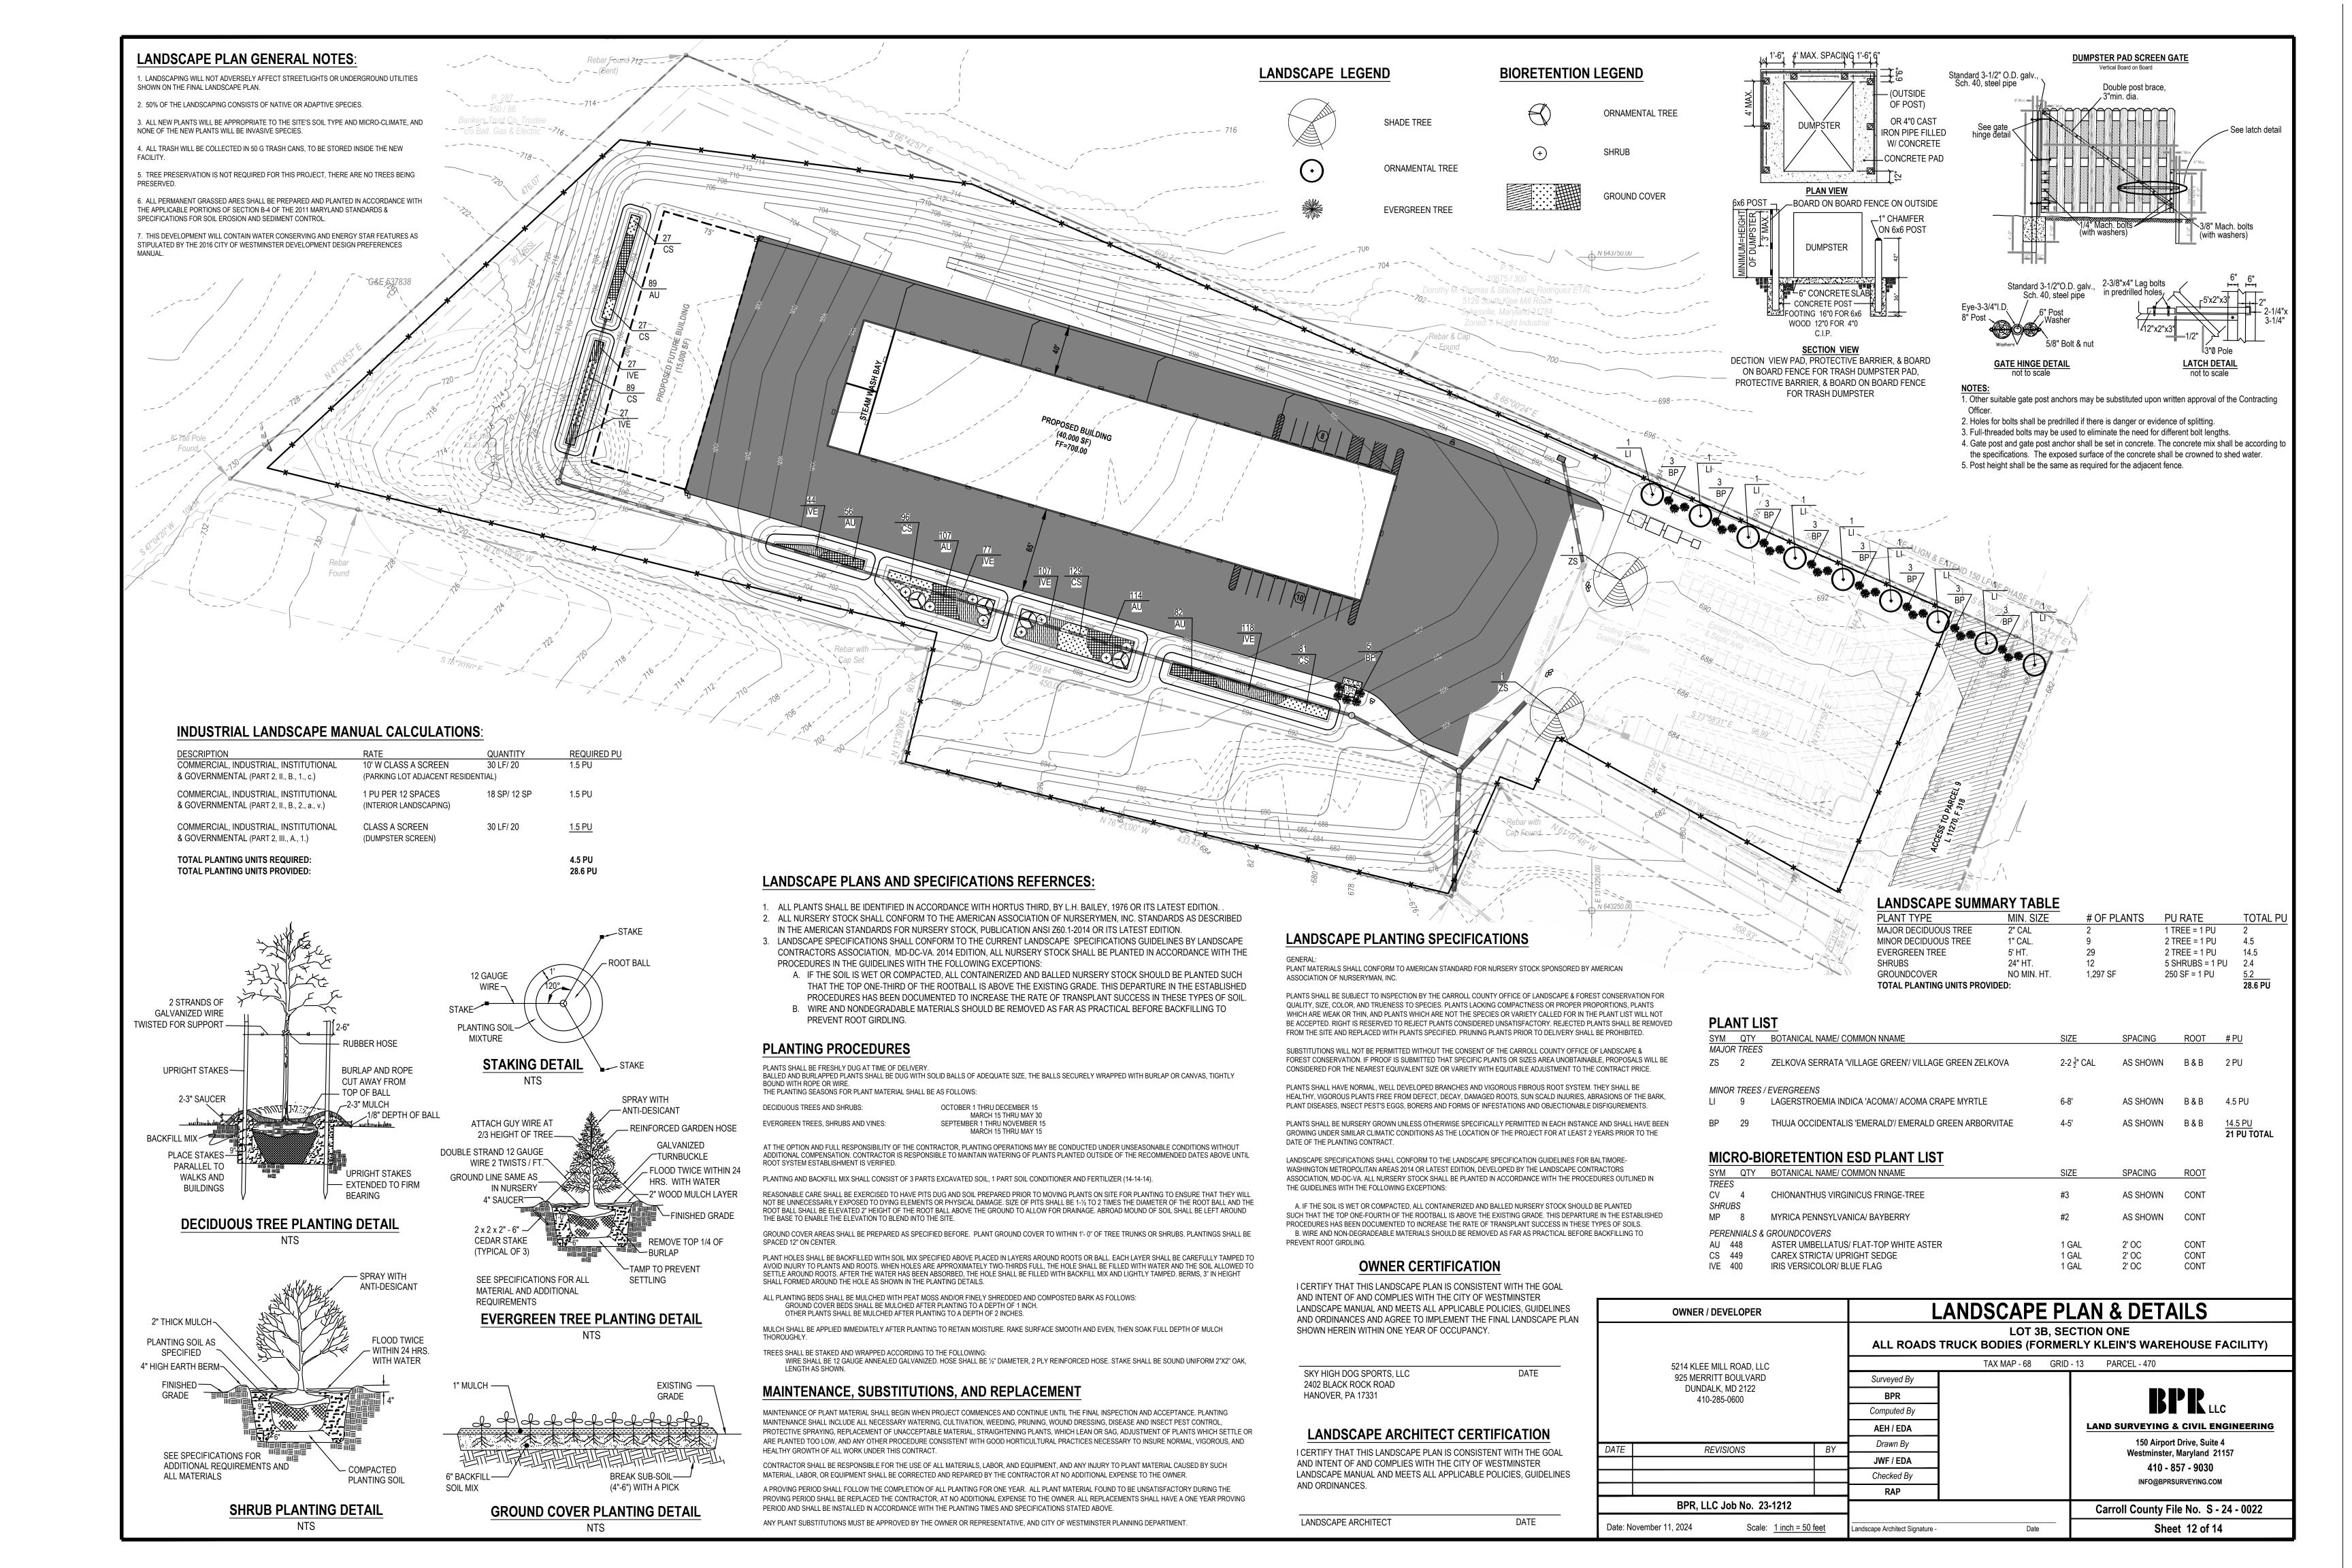

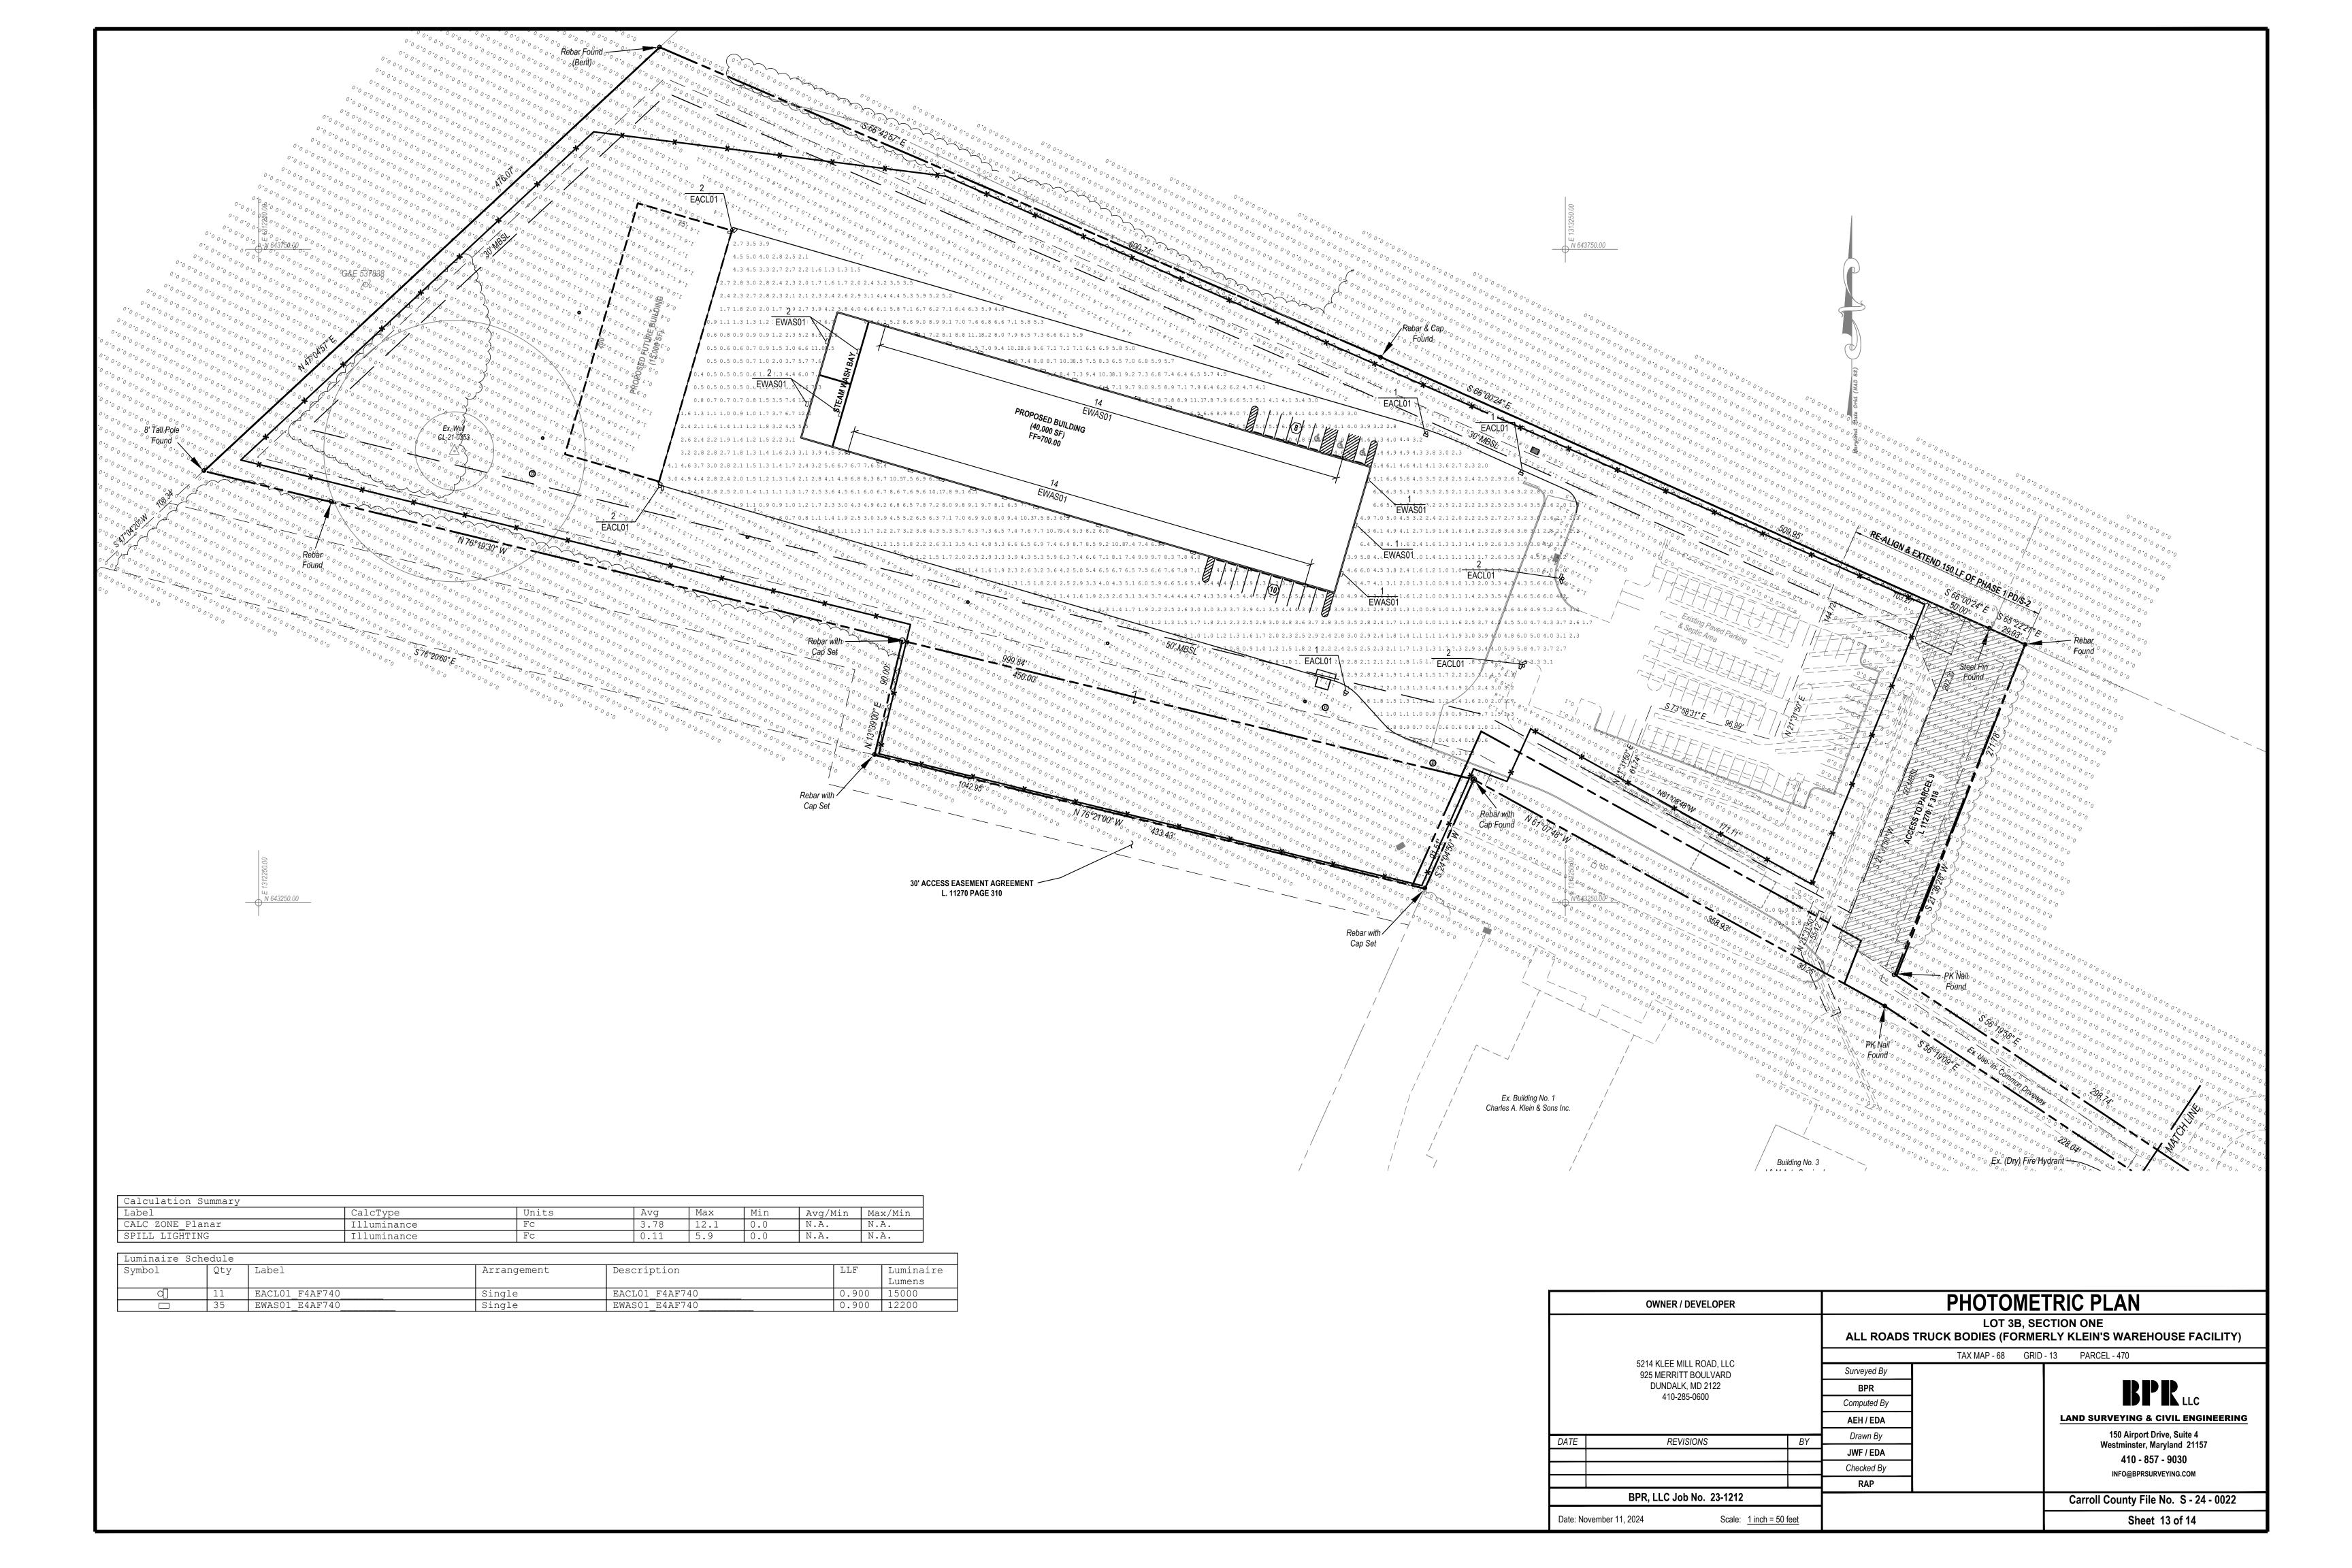







OWNER / DEVELOPER		BUILDING ELEVATIONS			
5214 KLEE MILL ROAD, LLC 925 MERRITT BOULVARD DUNDALK, MD 2122 410-285-0600		LOT 3B, SECTION ONE ALL ROADS TRUCK BODIES (FORMERLY KLEIN'S WAREHOUSE FACILITY)			
		TAX MAP - 68 GRID - 13 PARCEL - 470			
		Surveyed By			
		BPR		BPRLLC	
		Computed By			
		AEH / EDA		LAND SURVEYING & CIVIL ENGINEERING	
DATE	DATE REVISIONS	BY	Drawn By		150 Airport Drive, Suite 4
DATE			JWF / EDA	Westminster, Maryland 21157 410 - 857 - 9030	
			Checked By	Checked By	INFO@BPRSURVEYING.COM
			RAP		114 O@DI 1001.172 1 1110.000 III
BPR, LLC Job No. 23-1212			_		Carroll County File No. S - 24 - 0022
Date: November 11, 2024 Scale: Not to Scale				Sheet 14 of 14	