


GENERAL NOTES SITE DEVELOPMENT PLAN 1. EXISTING ZONING: I-2 HEAVY INDUSTRIAL 2. TOTAL AREA OF PROPERTY: 28.9 ACRES LIST OF DRAWINGS 3. TOTAL DEVELOPED AREA (LOD): 9,075 SF (.21 ACRES) PENGUIN RANDOM HOUSE 1. TITLE SHEET 4. PROPERTY OWNERSHIP: THE PROPERTY SHOWN HEREON IS OWNED BY RANDOM HOUSE INC., BY DEED **EXISTING CONDITIONS & DEMOLITION PLAN** DATED MAY 29, 1990, RECORDER AMONG THE LAND RECORDS OF CARROLL COUNTY IN LIBER 1212, FOLIO 141. SITE LAYOUT PLAN RANDOM HOUSE INC. 3RD AMENDED SITE PLAN c/o PENGUIN RANDOM HOUSE LLC - RYNE BARRALL **CONSTRUCTION DETAILS** 400 BENNETT CERF DRIVE SWM GRADING PLAN & ESD MAPPING. NOTES & DETAILS WESTMINSTER, MD 21157 FIRE PUMP UPGRADES 410-386-7725 STORMWATER MANAGEMENT NOTES & DETAILS 5. TAX MAP REFERENCE: TAX MAP 39 / GRID 20 / PARCEL 335 7th ELECTION DISTRICT CARROLL COUNTY, MARYLAND DEED REFERENCE: LIBER 1212 FOLIO 141 SEDIMENT EROSION CONTROL PLAN GRANTOR: COUNTY COMMISSIONERS DATE: MAY 29, 1990 PARCEL - 335 & 750 PUMP HOUSE BUIDLING ELEVATIONS **TAX MAP - 39 GRID - 20** Tax Map 39, Parcel 795 TAX MAP 39 / GRID 20 / PARCEL 750 9. VARIABLE WIDTH STREAM BUFFER DETERMINATION Mayor & Common Council CC FILE #: S-24-0005 DEED REFERENCE: LIBER 749 FOLIO 615 of Westminster Deed Book 807, Page 773 Š 68°44'38" E 5. TOPOGRAPHY: TOPOGRAPHY SHOWN HEREON IS A COMBINATION OF FIELD RUN - DATED AUGUST 2022, PREPARED BY BPR LLC - AND CARROLL COUNTY LIDAR PRODUCTS Zoned: Conservation AND CARROLL COUNTY DOES NOT WARRANT ITS ACCURACY FOR ANY PURPOSES. SCALE: 1inch = 2000 feet MARYLAND STATE HIGHWAY ADMINISTRATION 6. FIRE PROTECTION SOURCE: LOCATION OF THE NEAREST WATER SUPPLY AVAILABLE FOR FIRE PROTECTION **GIS DEPARTMENT** IS APROXIMATELY 30' AWAY, NEAR THE EXISTING (ON-SITE) WATER VALVE METER INSPECTION SEQUENCE NOTES CONTRACTOR SHALL NOTIFY THE CARROLL COUNTY BUREAU OF PERMITS AND INSPECTIONS AT 410-386-2674, AT LEAST ONE (1) DAY PRIOR TO BEGINNING ANY WORK. 7. EXISTING UTILITIES: THE LOCATION OF EXISTING UTILITIES SHOWN HEREON ARE APPROXIMATE ONLY CONTRACTOR SHALL VERIFY THE EXISTENCE, LOCATION, AND DEPTH OF ANY SITE COMPLIANCE INSPECTIONS ARE REQUIRED THE FOLLOWING STAGES DURING CONSTRUCTION. EXISTING UTILITIES AND SHALL NOTIFY THE ENGINEER/SURVEYOR OF ANY a. PROPOSED STRUCTURES STAKED OUT IN PROPER LOCATIONS AS SHOWN ON THESE APPROVED PLANS. DISCREPANCIES PRIOR TO BEGINNING WORK Tax Map 39, Parcel 798 b. PROPOSED FOUNDATIONS INSTALLED FOR ALL BUILDINGS SHOWN ON THESE APPROVED PLANS. Bennett Cerf Dr & Rte 27 8. MISS UTILITY: THE OWNER SHALL NOTIFY "MISS UTILITY" AT 1-800-257-7777 THREE WORKING c. SUB-GRADES ESTABLISHED FOR ALL DRIVES, PARKING LOTS, AND SURROUNDING GRADING. Penguin Random House LLC d. COMPLETION OF ALL DRIVES, PARKING LOTS, AND SURROUNDING GRADING. DAYS PRIOR TO THE BEGINNING OF WORK IN THE VICINITY OF EXISTING Deed Book 8845, Page 161 46.4578 Acres e. COMPLETION OF ALL WORK SHOWN ON THESE PLANS. IT IS THE CONTRACTOR'S RESPONSIBILITY TO CONTACT THE CARROLL COUNTY BUREAU OF PERMITS AND INSPECTIONS AT (410)-386-2674 9. PLAN DIMENSIONS: THE CONTRACTOR SHALL NOTE THAT IN CASE OF A DISCREPANCY BETWEEN THE UPON COMPLETION OF EACH PHASE OF CONSTRUCTION. SCALED AND FIGURED DIMENSIONS SHOWN ON THESE PLANS, THE FIGURED DIMENSIONS SHALL GOVERN. CONTRACTOR SHALL NOTIFY CARROLL COUNTY BUREAU OF RESOURCE MANAGEMENT. ENVIRONMENTAL INSPECTION SERVICES DIVISION Tax Map 39, Parcel 790 AT (410)-386-2210 PRIOR TO BEGINNING ANY WORK. ALL FOREST CONSERVATION PLAN DEVICES MUST BE IN PLACE PRIOR TO ANY PROJECT AREA-N 699920 Eden Farms 10. CHANGES TO THE PLAN: ANY CHANGES TO THIS PLAN WILL REQUIRE AN AMENDED SITE DEVELOPMENT Tax Map 39, Parcel 796 Section 3 PLAN TO BE APPROVED BY THE CARROLL COUNTY PLANNING AND ZONING Bennett Cerf Dr Zoned: R-20,000 Random House Inc. STREAM BUFFERS SHALL BE IDENTIFIED AT THE CONSTRUCTION SITE AND PROTECTED THROUGH THE INSTALLATION OF HIGHLY VISIBLE Deed Book 807, Page 776 WELL-ANCHORED FENCING (SHOULD DISTURBANCE BE PROPOSED IN THE VICINITY OF THE BUFFER) PRIOR TO ANY LAND CLEARING OR 2.4268 Acres GRADING. SUITABLE FENCING MEASURES INCLUDE BLAZE-ORANGE, PLASTIC, MESH FENCING; TWO OR THREE-STRAND WIRE FENCE WITH 11. SITE PLAN EXPIRATION: THIS SITE PLAN SHALL BECOME VOID EIGHTEEN MONTHS AFTER THE DATE OF Zoned: Conservatior THE APPROVAL IF NO BUILDING PERMIT OR ZONING CERTIFICATE HAS BEEN HIGHLY VISIBLE FLAGS; OR SNOW FENCING WITH HIGHLY VISIBLE FLAGS ON ANCHOR POSTS. IF A FOREST CONSERVATION AREA, AS ISSUED FOR THIS PROJECT, UNLESS AN EXTENSION OF THIS TIME LIMIT IS REQUIRED BY CHAPTER 150, FOREST CONSERVATION, OF THE CODE, COMPLETELY INCLUDES THE STREAM BUFFER AREA, THEN NO Tax Map 39, Parcel 650 ISSUED BY THE DIRECTOR OF THE DEPARTMENT OF PLANNING. Hahn Road Armory ADDITIONAL FENCING IS REQUIRED. PROTECTIVE FENCING SHALL BE INSTALLED AND INSPECTED BY THE COUNTY PRIOR TO THE ISSUANCE State of Maryland Tax Map 39, Parcel 750 OF ANY GRADING PERMIT. Deed Book 649, Page 620 #27 Cranberry Station SITE DATA 10.02 Acres Random House Inc. AFTER CONSTRUCTION HAS BEEN COMPLETED AND THE SITE IS STABILIZED, ALL STREAM BUFFER PROTECTIVE FENCING SHALL BE Zoned: Conservation Deed Book 749, Page 615 REMOVED FROM THE SITE FOR PROPER DISPOSAL; HOWEVER, SIGNS SHALL REMAIN IN PLACE AFTER CONSTRUCTION HAS BEEN 1. PROPOSED USE: **NEW FACILITY PUMP HOUSE** 10.36 Acres COMPLETED. 2. BUILDING HEIGHT THE DEVELOPER SHALL PROVIDE PERMANENT SIGNS TO IDENTIFY THE WATER RESOURCE PROTECTION EASEMENT AREA. THESE SIGNS 3. SIGNAGE: NO PROPOSED SIGNAGE SHALL BE INSTALLED AT 100 FEET INTERVALS AROUND THE PERIMETER OF THE EASEMENT. SIGNS SHALL BE CONSTRUCTED OF NON-BIODEGRADABLE MATERIALS AND AFFIXED TO POSTS OF LASTING MATERIALS (E.G., OAK OR METAL STAKES). POSTS SHALL BE FOUR 4. LIGHTING: NO PROPOSED SITE LIGHTING. THERE WILL BE BUILDING MOUNTED FIXTURES FEET ABOVE GROUND AND TWO FEET BELOW GROUND. 5. SOILS: URBAN LAND COMPLEX (UrB) - 0 TO 8 PERCENT SLOPES - HYDROLOGIC SOILD GROUP D ALL SIGNS MUST BE INSTALLED AT THE TIME OF DEED OF EASEMENT RECORDATION. Tax Map 39, Parcel 557 BRINKLOW CHANNERY LOAM (BrD) 15 TO 25 PERCENT SLOPES - HYDROLOGIC SOILD GROUP C Bennett Cerf Park CODORUS SILT LOAM (CdA) - 0 TO 3 PERCENT SLOPES - HYDROLOGIC SOILD GROUP C County Commissioners of THE CONTRACTOR SHALL NOT PROCEED TO NEXT PHASE OF CONSTRUCTION UNTIL GIVEN APPROVAL OF PRIOR PHASES. MANOR CHANNERY LOAM (MbD) - 15 TO 25 PERCENT SLOPES - HYDROLOGIC SOILD GROUP B Carroll County N 37°20'17" E Deed Book 443, Page 117 6. FIRE PROTECTION: Tax Map 39, Parcel 335 7.31 Acres #400 Hahn Road Zoned: Conservation THE NEW BUILDING WILL BE SPRINKLERED. AN EXISTING FIRE HYDRANT LOCATED AT THE WATER VALVE METER **CARROLL COUNTY SIGNATURE BLOCKS** Random House Inc. HOUSE WILL BE USED, TO BE IN COMPLIANCE WITH THE FOLLOWING FIRE PROTECTION REQUIREMENTS: Deed Book 1212, Page 141 18.54 Acres A. PROVIDE A 333 FT RADIUS OF COVERAGE FOR THE ENTIRE BUILDING FOOTPRINT CARROLL COUNTY PLANNING AND ZONING COMMISSION Zoned: I-2 B. PROVIDE A MAXIMUM 100' DISTANCE TO THE FIRE DEPARTMENT CONNECTION 7. PUBLIC WATER & SEWAGE SERVICE: THIS SITE IS SERVED BY EXISTING CITY OF WESTMINSTER PUBLIC WATER & SEWER SERVICES. 8. STORMWATER MANAGEMENT (SWM): THIS PROJECT IS IN COMPLIANCE WITH CARROL COUNTY SWM CODE. ESD TO THE MEP HAS BEEN ACHIEVED ENTIRELY BY CARROLL COUNTY HEALTH DEPARTMENT THE IMPLEMENTATION OF MICRO-SCALE ESD PRACTICES, AND THE COUNTY HAS DETERMINED THAT HERE IS NO HISTORICAL FLOODING PROBLEMS OR UNCONTROLLED DEVELOPMENT OCCURRING DOWNSTREAM OF THIS PROJECT. 9. SEDIMENT & EROSION CONTROL: MISS UTILITY Tax Map 103, Parcel 4682 THIS PROJECT IS IN COMPLIANCE WITH CHAPTER 152 OF THE CARROLL COUNTY GRADING AND SEDIMENT CONTROL CODE. COMMUNITY WATER SUPPLY AND/ OR COMMUNITY SEWERAGE SYSTEMS ARE IN CONFORMANCE 280 Woodward Road UNDER SECTION 152,005 FOR PROJECTS WHICH DISTURB BETWEEN 5,000 TO 30,000 SF. THE PROJECT WILL MEET THE Wal-Mart Real Estate WITH THE CARROLL COUNTY MASTER PLAN. SEDIMENT CONTROL REQUIREMENTS OF THE COUNTY'S "STANDARD SEDIMENT AND EROSION CONTROL PLAN" AS DIRECTED ENLARGEMENT AREA— Deed Book 3227, Page 689 BY THE GRADING PERMIT. A DESIGNED SEDIMENT CONTROL PLAN IS NOT REQUIRED. Tax Map 39, Parcel 750 13.04 Acres 27 Cranberry Station CoW Zoning: B 10. WATER RESOURCE PROTECTION: Random House Inc. CARROLL COUNTY SOIL CONSERVATION DISTRICT Deed Book 749, Page 615 DESIGNATED WATER RESOURCE PROTECTION AREA(S): THIS SITE LIES WITHIN THE METAVOLCANIC 10.36 Acres CCCM BEFORE YOU DIG CALL ROCK-SAPROLITE AQUIFER - WITHIN AN AQUIFER PROTECTION AREA. A SURFACE WATER MANAGEMENT AREA AND A THIS PLAN IS APPROVED FOR SOIL EROSION AND SEDIMENT CONTROL BY THE CARROLL SOIL Zoned: I-2 'PO1' PROTECT YOURSELF, GIVE TWO WORKING DAYS NOTICE MULTIPLE MANAGEMENT AREA. IT IS NOT WITHIN A CARBONITE ROCK AREA, A WELLHEAD PROTECTION AREA, OR NEAR ANY CONSERVATION DISTRICT. EXISTING OR POTENTIAL MUNICIPAL WELL SITES OR WELL SITE BUFFERS. N 698778 STREAM USE & DRAINAGE BASIN DESIGNATION: THE SITE IS WITHIN THE LIBERTY RESERVOIR DRAINAGE BASIN IUST BE DONE IN COMPLIANCE WITH T (02130907). THE ADJACENT STREAM (LONGWELL RUN) HAS A STREAM USE DESIGNATION OF I-P. TIER II HIGH QUALITY WATERS: THE SUBJECT PROPERTY DOES RESIDE WITHIN A TIER II CATCHMENT W/ NO ASSIMILATIVE Tax Map 103, Parcel 4682 THE CONTRACTOR TO CALL MISS UTILITY CAPACITY REMAINING - AS DESIGNATED BY THE MARYLAND DEPARTMENT OF THE ENVIRONMENT (MDE). Woodward Road Sec 2 CITY OF WESTMINSTER SIGNATURE BLOCKS Tax Map 39, Parcel 371 HOURS PRIOR TO ANY CONSTRUCTION United States Postal Service 440 Hahn Road FLOODPLAIN: THERE ARE BOTH 100 YEAR & 500 YEAR FLOODPLAIN AREAS WITHIN THE PROPERTY LIMITS AND Deed Book 1178, Page 984 Hahn Brothers Inc. CITY OF WESTMINSTER, DIRECTOR OF PUBLIC WORKS DIRECTLY ADJACENT TO THE PROJECT LIMITS OF DISTURBANCE. Deed Book 198, Page 355 CoW Zoning: B Zoned: I-2 TOXIC SUBSTANCES: THE DEVELOPMENT SHOWN BY THIS PLAN DOES NOT INVOLVE THE STORAGE, USE, SALE OR MAINTENANCE OF ANY REGULATED SUBSTANCES, AND NO SUCH ACTIVITIES ARE INTENDED FOR THIS PROPERTY. REGULATED SUBSTANCES ARE PROHIBITED. 11. TRAFFIC CONTROL PLAN: NOT APPLICABLE **ENGINEERS CERTIFICATION SITE MAP** 12. GARBAGE COLLECTION: NOT APPLICABLE 8/7/24 ADDRESS COUNTY COMMENTS 13. PARKING TABULATION: NOT APPLICABLE 6/6/24 ADDRESS COUNTY COMMENTS I hereby certify that these construction drawings and associated computations were prepared **SCALE: 1"=150"** 4/12/24 ADDRESS COUNTY COMMENTS by me or under my supervision and comply with all applicable standards and regulations of DATE Carroll County. I have reviewed these documents with the Owner/Developer. TITLE SHEET LEGEND **EXISTING PROPOSED** PENGUIN RANDOM HOUSE NAME (PRINTED) **EDGE OF PAVEMENT** EDGE OF PAVEMENT PROPERTY LINE SUBJECT PROPERTY LINE SUBJECT MD REGISTRATION N^O: EXP DATE: FIRE PUMP UPGRADES PROPERTY LINE ADJOINER PROPERTY LINE ADJOINER **DENOTES CONTOURS DENOTES CONTOURS** 7th ELECTION DISTRICT CARROLL COUNTY, MARYLAND TAX MAP - 39 GRID - 20 PARCEL - 335 & 750 SSF DENOTES SUPER SILT FENCE DENOTES EDGE OF ROAD DENOTES SUPER SILT FENCE DENOTES EDGE OF ROAD — SSF — **SIGNATURE** DENOTES SILT FENCE DENOTES SILT FENCE **DENOTES CURB** DENOTES CURB Surveyed By Drawn By OWNER / DEVELOPER CERTIFICATION OWNER / DEVELOPER M.JM CENTER LINE ROAD CENTER LINE ROAD • • • • • • • • • • • • • LIMITS OF DISTURBANCE LIMITS OF DISTURBANCE • • • • • • • • • • Computed By Checked By I/WE hereby certify that all proposed work shown on these construction drawing(s) has been **DENOTES BUILDING DENOTES BUILDING OVERHEAD UTILITIES** OVERHEAD UTILITIES BPR BPR reviewed by me/us and that I/WE fully understand what is necessary to accomplish this work DENOTES WATER LINE **DENOTES WATER LINE GUARD RAIL** and that the work will be conducted in strict accordance with these plans. I/WE also understand **GUARD RAIL** FEBRUARY 22, 2024 0 00 0 00 0 that any changes to these plans will require an amended plan to be reviewed and approved by CONCRETE PENGUIN RANDOM SANITARY SEWER LINE SANITARY SEWER LINE CONCRETE ___s__ the Carroll County Planning and Zoning Commission before any change in the work is made. SURVEYORS - LAND PLANNERS 1 OF 9 **HOUSE LLC** STORMDRAIN MANHOLE STORMDRAIN MANHOLE PAVEMENT (DRIVEWAYS / ROADS) PAVEMENT (DRIVEWAYS / ROADS) C/O RYNE BARRALL 150 AIRPORT DRIVE - SUITE 4 Scale: 1" = 150' 400 BENNETT CERF DRIVE WATER VALVE WESTMINSTER, MARYLAND 21157 WV_O-SANITARY SEWER MANHOLE SANITARY SEWER MANHOLE WATER VALVE WESTMINSTER, MD 21157 PHONE: (410)-857-9030 BPR Drawing No.: 22-0614 Name(s) (Printed) SANITARY SEWER CLEAN OUT SANITARY SEWER CLEAN OUT WATER METER WATER METER 410-386-7725 OR (410)-876-0333 FAX: (410)-876-1532 FIRE HYDRANT FIRE HYDRANT HANDICAP PARKING 25% TO 50% SLOPES WWW.BPRSURVEYING.COM CC FILE #: S-24-0005 HANDICAP PARKING 50% OR GREATER SLOPES Signed Date

MJM

MJM

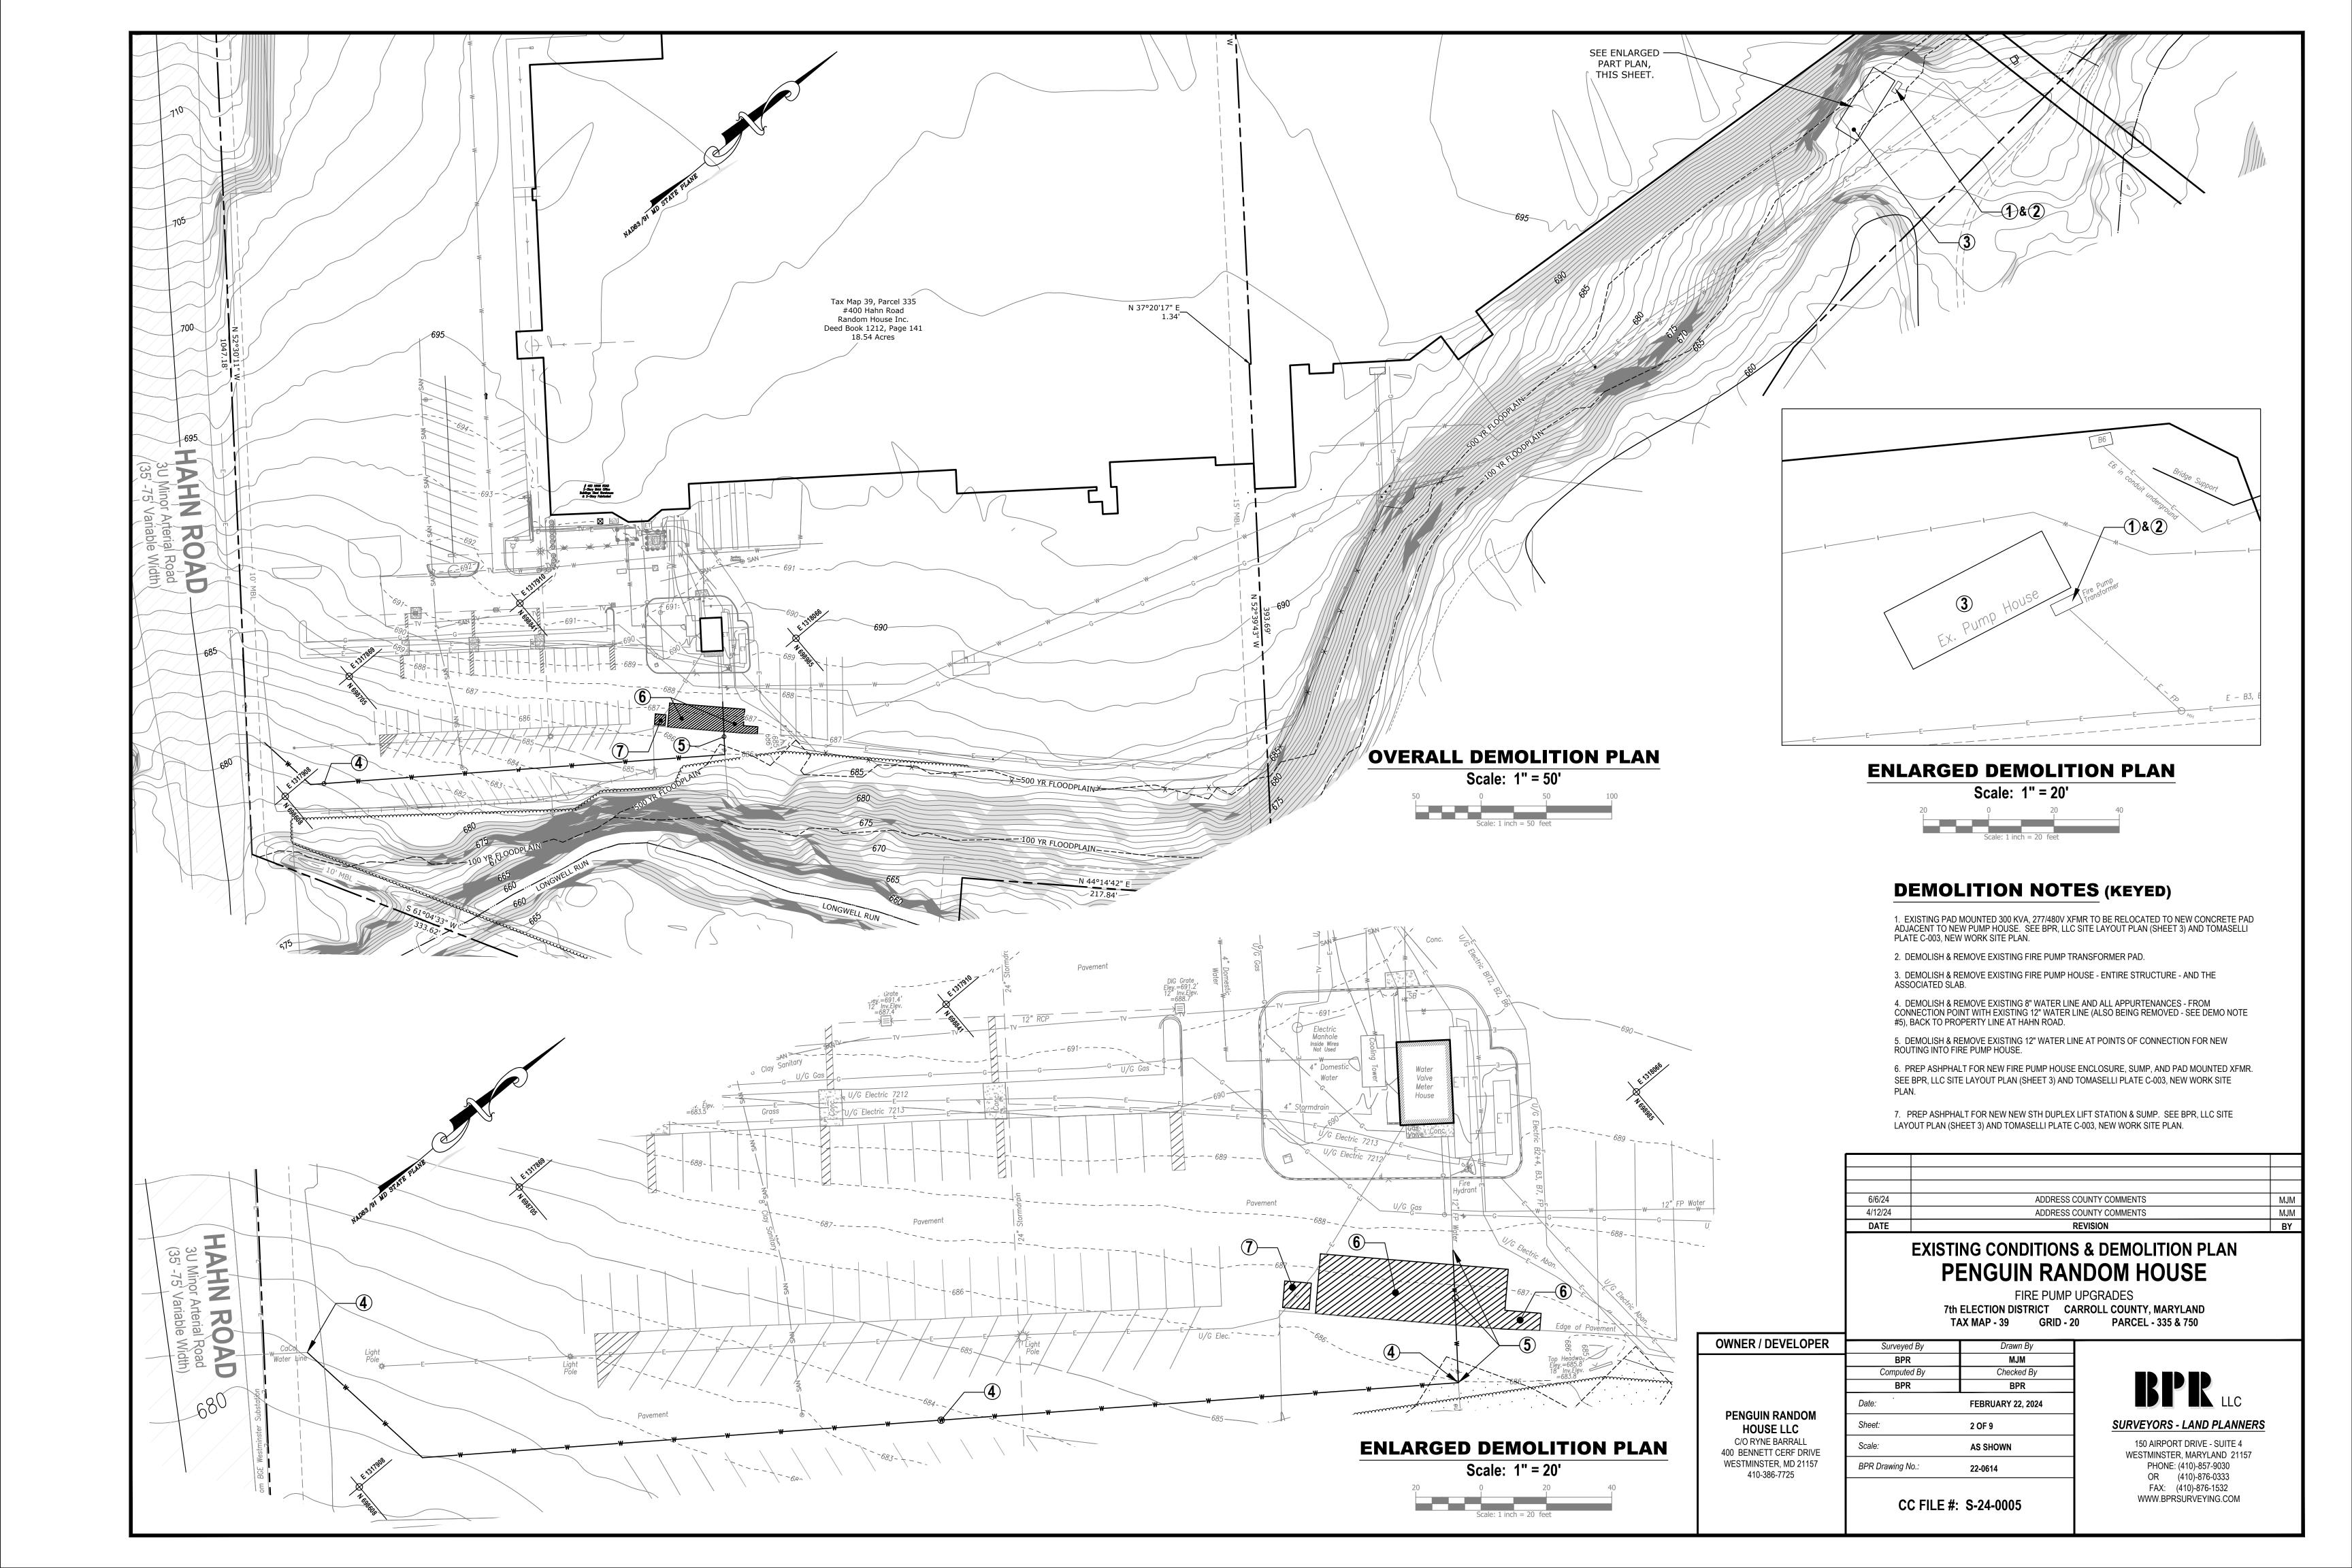

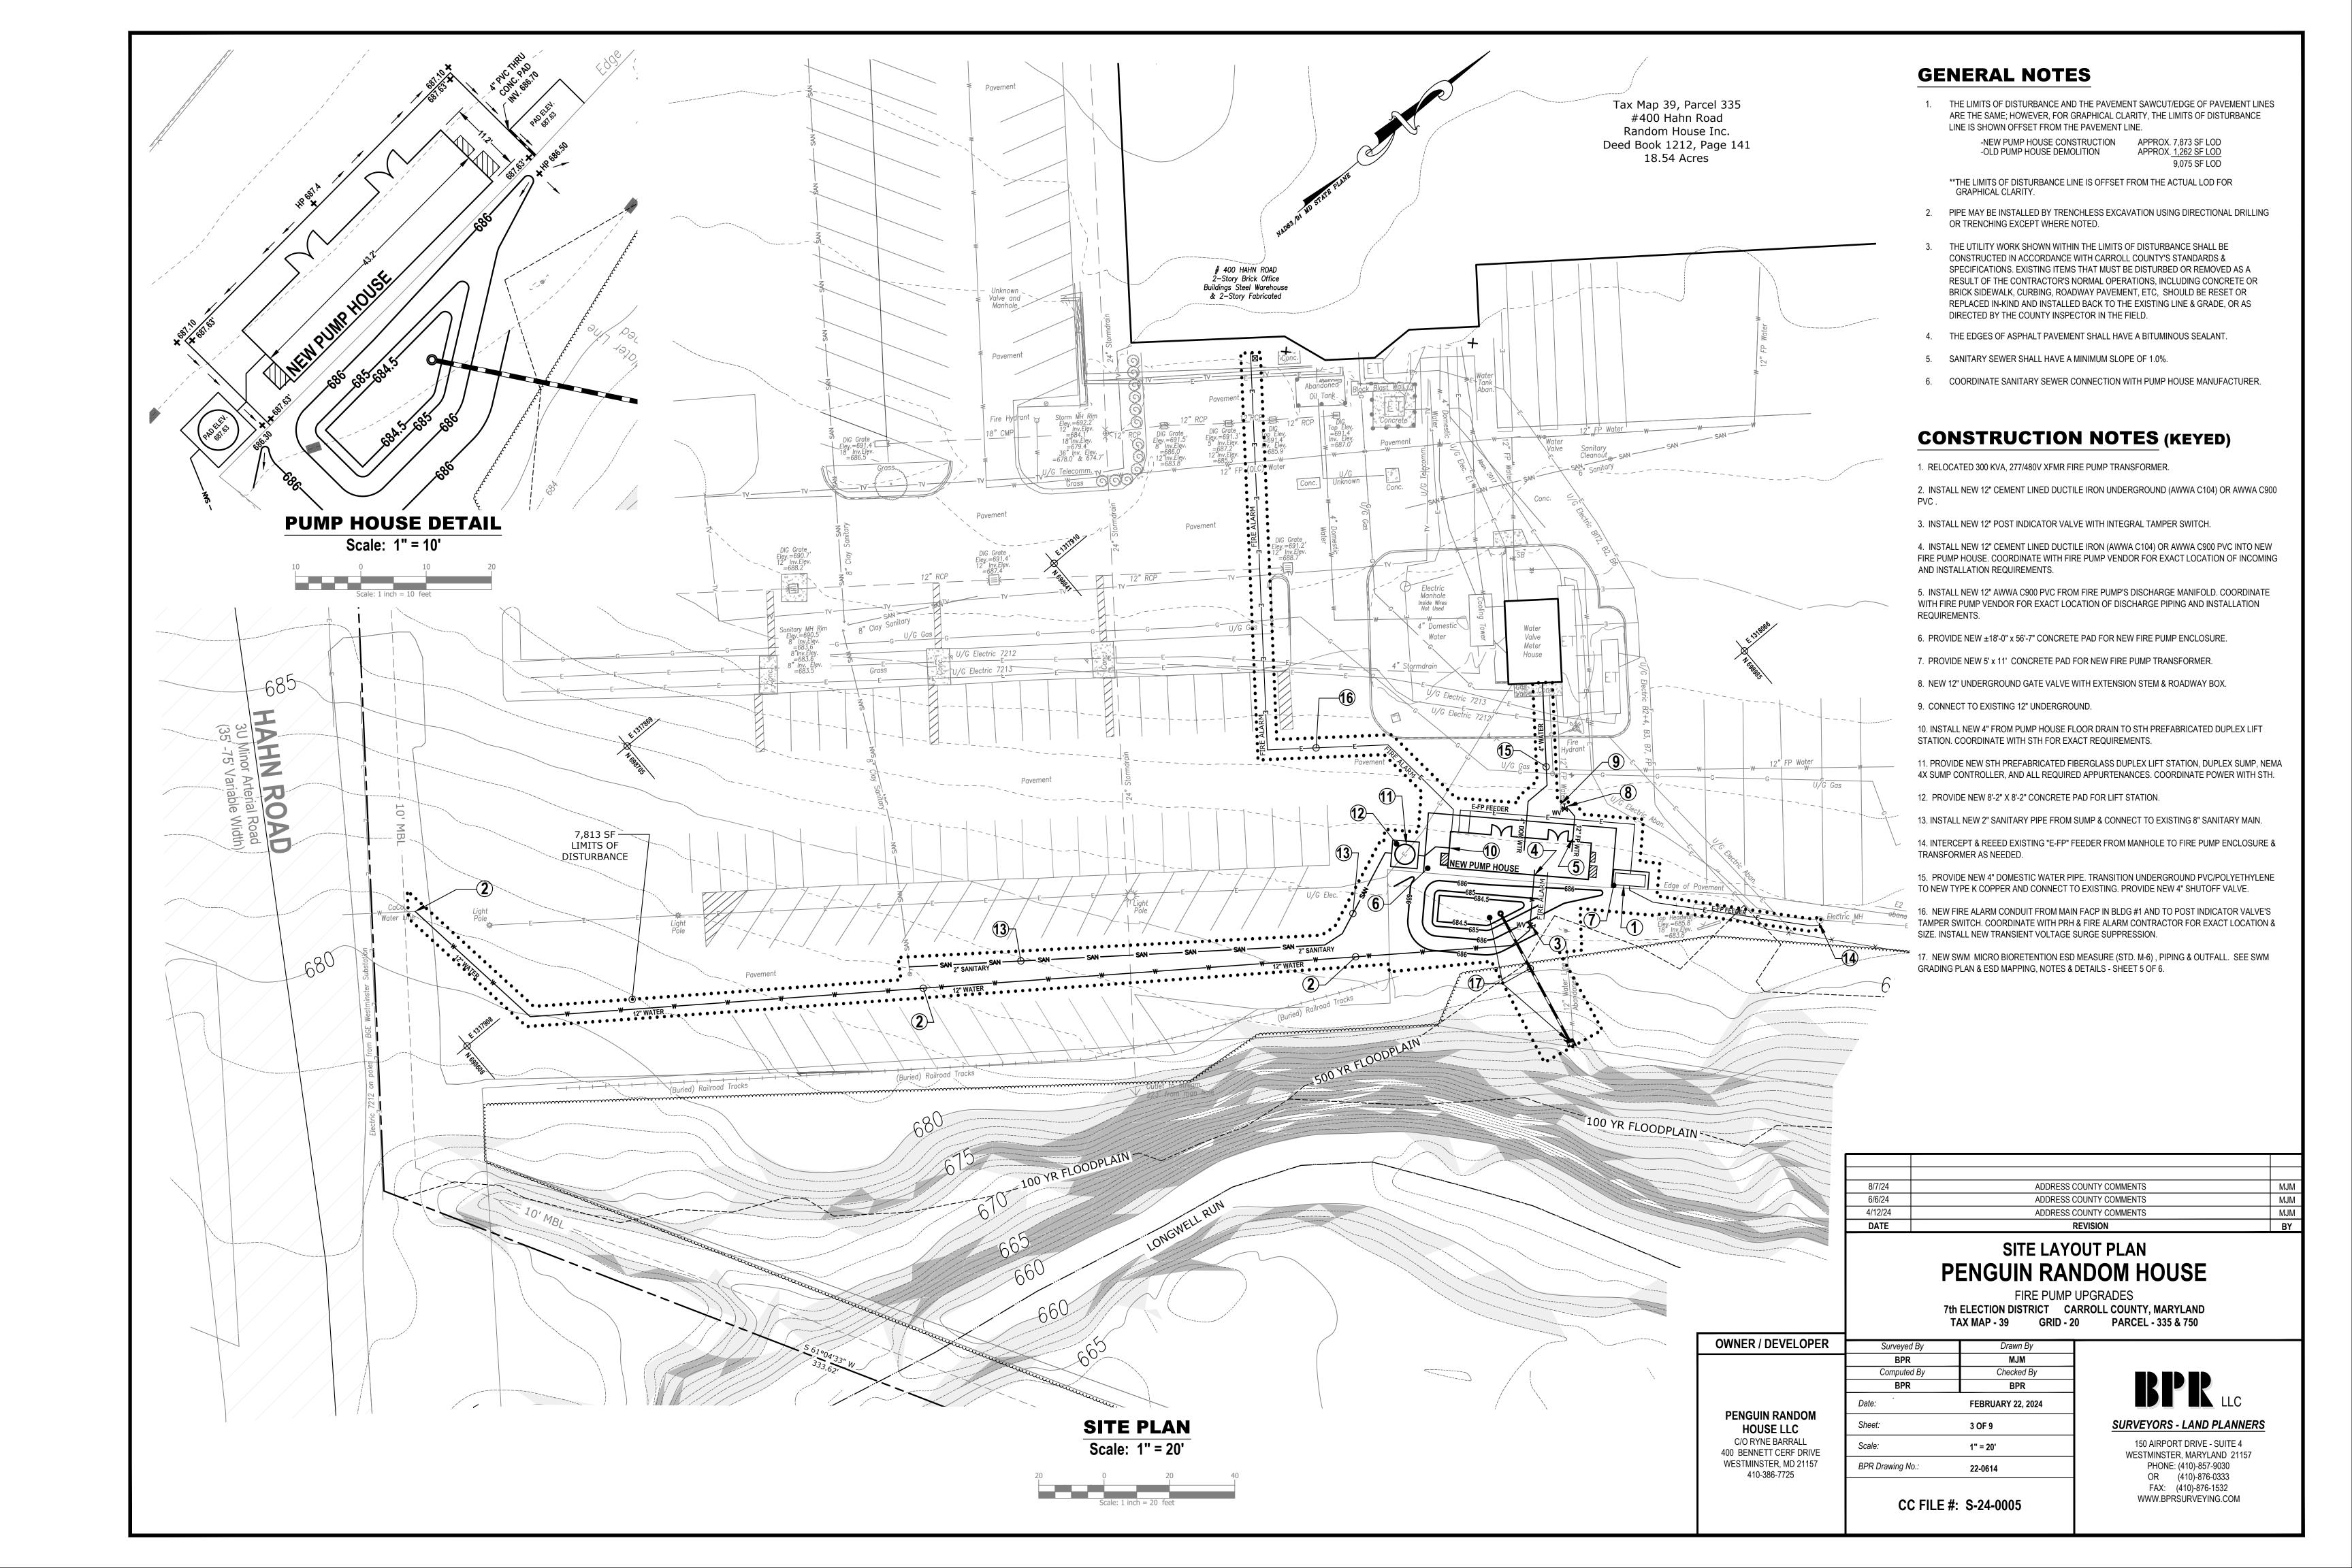

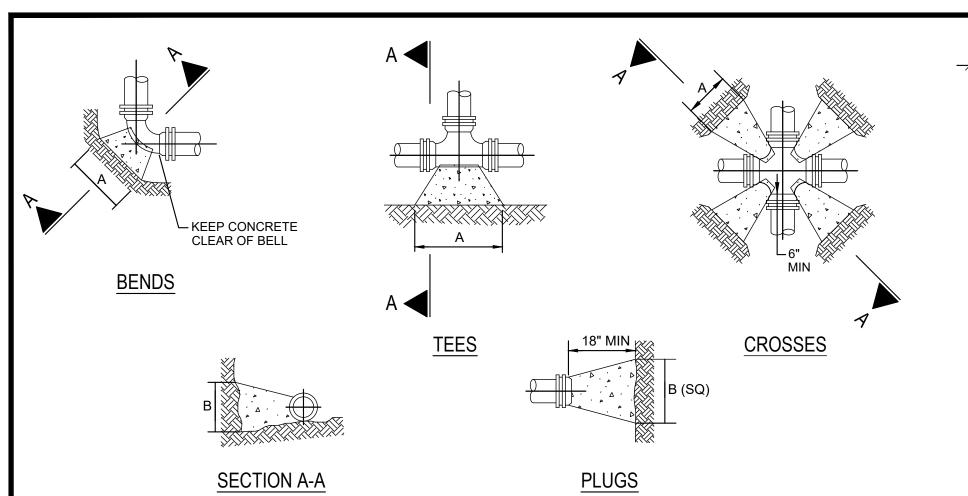



	REQUIRED BEARING AREA ON UNDISTRUBED SOIL AND TYPICAL DIMENSIONS														
	CROSS	SES/90° I	BENDS	4	5° BEND	S	11-	1/4° BEN	IDS	22-	·1/2° BEI	NDS	TEE	S & PLU	GS
SIZE	AREA SQ. FT.	"A"	"B"	AREA SQ. FT.	"A"	"B"	AREA SQ. FT.	"A"	"B"	AREA SQ. FT.	"A"	"B"	AREA SQ. FT.	"A"	"B"
6"	4.0	32"	18"	2.2	18"	16"	0.6	5"	18"	1.1	9"	18"	2.8	23"	18"
8"	7.0	42"	24"	3.8	23"	24"	1.0	6"	24"	2.0	12"	24"	5.0	30"	24"
10"	11.0	53"	30"	6.3	30"	30"	1.6	8"	30"	3.1	15"	30"	8.0	38"	30"
12"	16.1	64"	36"	10.0	40"	36"	2.2	9"	36"	4.4	18"	36"	11.3	45"	36"
14"	21.6	74"	42"	12.5	43"	42"	3.0	10"	42"	5.0	21"	42"	15.5	53"	42"
16"	28.3	85"	48"	17.7	53"	48"	4.0	12"	48"	7.7	23"	48"	20.1	60"	48"


* SURFACE AREA OF BEARING SOIL IS PROVIDED FOR 200 PSI MAXIMUM PRESSURE (INCLUDING SURGE) AND 2000 PSF SOI BEARING. IF PRESSURE IS HIGHER OR SOIL BEARING IS POTENTIALLY LOWER, CONSULT THE ENGINEER FOR ADJUSTMENTS.

- COVER OVER TOP OF PIPE SHALL BE BELOW THE FROST LINE OR 30"MINIMUM, 72"MAXIMUM ACCORDING TO REGULATORY REQUIREMENTS. IF GRADING PLANS RECEIVED BY THE ENGINEER/OWNER WITH THE REQUEST FOR WATER MAIN LAITY INDICATED ADJUSTMENTS TO EXISTING GRADE, THEN PIPE SHALL BE INSTALLED TO MEET MINIMUM AND MAXIMUM COVER FROM PROPOSED GRADES SHOWN ON THE SAID PLANS.
- 2. THRUST BLOCKS SHALL BE BUILT AGAINST UNDISTURBED SOIL WITH ADEQUATE BACKING TO PREVENT MOVEMENT OF FITTINGS
- 3. NO THRUST BLOCKS TO BE PLACED IN SEWER LATERAL DITCHES.
- 4. THRUST BLOCKING MUST FIT WITHIN THE EASEMENT.
- 5. IN SOME CASES, ADDITIONAL RESTRAINT MAY BE REQUIRED BASE ON 150 PSI STATIC PRESSURE, PLUS 50 PSI WATER HAMMER AND 2000 PSF SOIL BEARING.
- POLYETHYLENE ENCASEMENT IS REQUIRED ON ALL DI. PIPE AND FITTINGS
- 7. THRUST BLOCKING SHALL BE PERFORMED SUCH THAT PIPE JOINS AND BOLTS ARE ACCESSIBLE.
- 8. SUFFICIENT CLEARANCE SHALL BE ALLOWED BETWEEN CONCRETE AND BOLTS FOR FUTURE MAINTENANCE.
- 9. ALL ANCHOR BOLTS SHALL BE STAINLESS STEEL, MINIMUM 3/4" DIAMETER
- 10. ALL M.J. AND FGL. FITTINGS TO RECEIVE THRUST BLOCKS SHALL BE WRAPPED IN POLYWRAP. CONTRACTOR SHALL ENSURE THAT POLYWRAP EXTENDS FAR ENOUGH BEYOND THE FITTING TO ENCLOSE ALL BOLTS WITHIN THE POLYWRAP.
- 11. THRUST BLOCKING DETAILS ARE SHOWN HERE FOR TYPICAL INSTALLATIONS. IN SOME CASES, ADDITIONAL RESTRAINTS MAY BE
- 12. PORTLAND CEMENT CONCRETE USED FOR THRUST BLOCKS SHALL BE MIN 3000 PSI CONCRETE
- 13. FOR UNSTABLE SOIL CONDITIONS, CHECK WITH ENGINEER FOR THRUST BLOCK DIMENSIONS.
- 14. FOR MAIN SIZES GREATER THAN 16", SEE ENGINEER FOR THRUST BLOCK DIMENSIONS.

THRUST BLOCK DETAIL

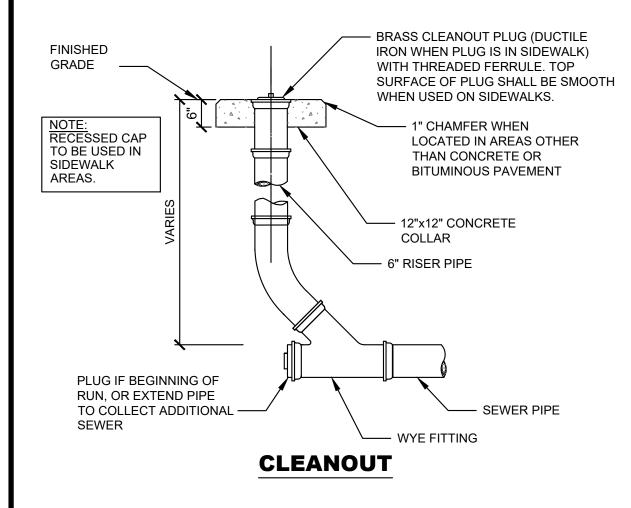

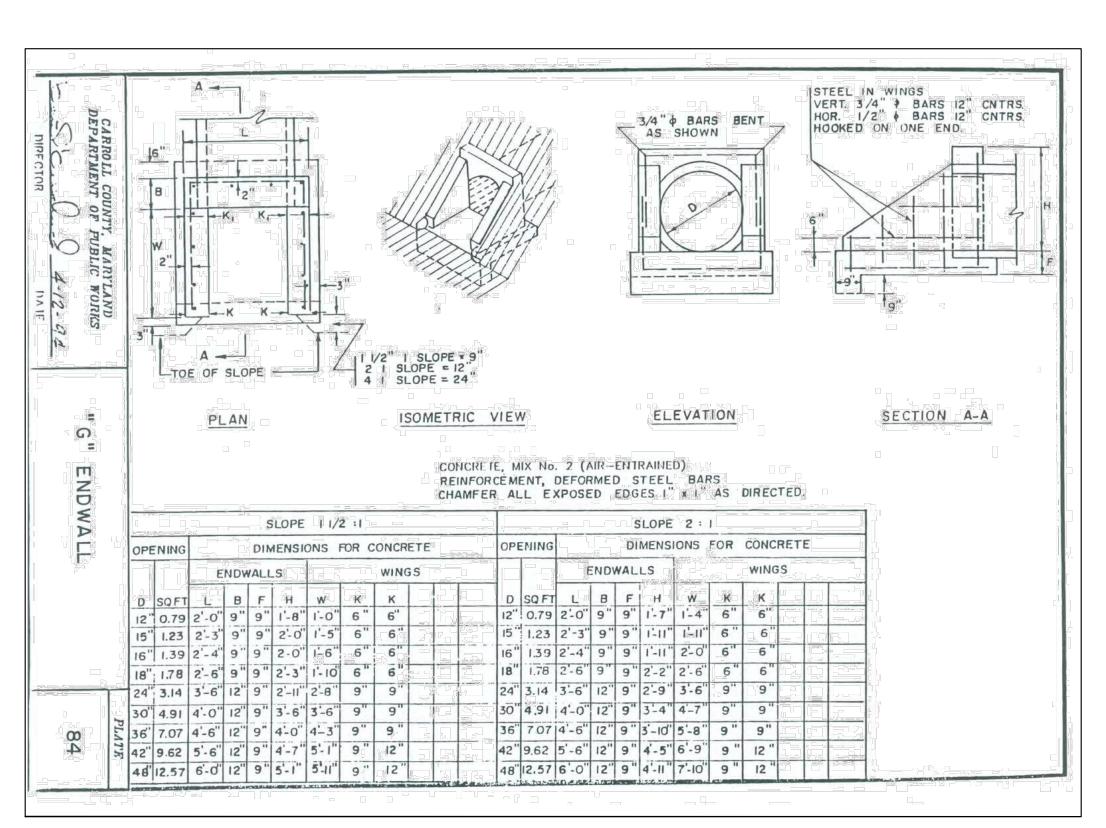

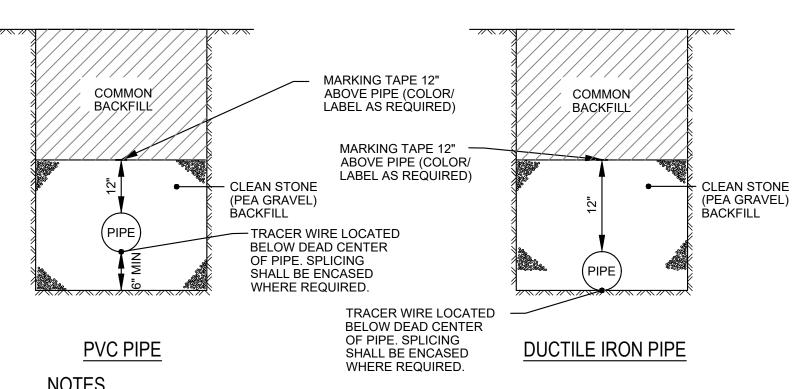

CAUTION MUST BE EXERCISED TO ENSURE PROPER PLACEMENT OF EMBEDMENT MATERIAL UNDER

- THE HAUNCHES OF THE PIPE POLYETHYLENE ENCASING ON ALL DUCTILE IRON PIPES, FITTINGS, VALVE AND APPURTENANCES. IF EDGE OF SAW CUT IS <= 4 LINEAR FEET FROM CURB LINE, REMOVE PAVEMENT TO CURB. STONE BACKFILL TO BE MECHANICALLY COMPACTED IN 6"-12" LIFTS.
- REFER TO SPECIFICATIONS FOR DESCRIPTION OF BACKFILL AND BEDDING MATERIAL TYPICAL TRENCH WIDTH SHALL BE PIPE OUTER DIAMETER + 2'. RETURN SURFACE CONDITIONS TO EXISTING LINE, GRADE, AND SURFACE (HYDROLOGIC CONDITION).

1" RADIUS

1' - 8"

1. COMBINATION CURB AND GUTTER, TYPE "D" MEETS SHA MD 620.02-01

2. CONCRETE 28-DAY STRENGTH SHALL BE A MINIMUM OF 3500 PSI

CONCRETE CURB & GUTTER

3. PROVIDE EXPANSION JOINTS AT A MAXIMUM OF 20 FEET

GUTTER PLAN SAME

ADJACENT PAVEMENT

CROSS SLOPE AS

OPEN TRENCH DETAIL UNDER NON PAVED AREAS

* 6" OR MATCH

EXISTING CURB HEIGHT

- 2" MDOT SUPERPAVE ASPHALT MIX 9.5 MM SURFACE - PG 64S-22, LEVEL 2 4" MDOT SUPERPAVE ASPHALT MIX 19 MM BASE - PG 64S-22, LEVEL 2 GENERAL NOTES: 1. ALL CONCRETE SHALL BE 3000 PSI. — 4" MDOT GRADED AGGREGATE BASE 2. EXPANSION JOINTS SHALL BE CONSTRUCTED EVERY 20' APART. CONTROL JOINTS SHALL BE CONSTRUCTED EVERY 5'-0". — FLOWABLE FILL

BITUMINOUS PAVEMENT

AND SEAL

EXISTING

BITUMINOUS

PAVEMENT

12" MIN

GRADED

AGGREGATE

BASE OR CR-6

MARKING TAPE 12"

ABOVE PIPE (COLOR/

LABEL AS REQUIRED)

TRACER WIRE LOCATED

BELOW DEAD CENTER

OF PIPE. SPLICING

WHERE REQUIRED.

SHALL BE ENCASED

- 7" CONCRETE 4" BASE COURSE USING GRADED AGGREGATE — COMPACTED SUBGRADE

- NEW

PAVEMENT

• CLEAN STONE

STONE BACKFILL TO BE MECHANICALLY COMPACTED IN 6"-12" LIFTS.

TYPICAL TRENCH WIDTH SHALL BE PIPE OUTER DIAMETER + 2'.

PVC PIPE

BACKFILL

(PEA GRAVEL)

SAWCUT

EXISTING -

BITUMINOUS

12" MIN GRADED

MARKING TAPE 12" ABOVE PIPE (COLOR/

LABEL AS REQUIRED)

TRACER WIRE LOCATED

BELOW DEAD CENTER

OF PIPE. SPLICING

SHALL BE ENCASED

WHERE REQUIRED.

CAUTION MUST BE EXERCISED TO ENSURE PROPER PLACEMENT OF EMBEDMENT MATERIAL UNDER THE

POLYETHYLENE ENCASING ON ALL DUCTILE IRON PIPES, FITTINGS, VALVE AND APPURTENANCES.

IF EDGE OF SAW CUT IS <= 4 LINEAR FEET FROM CURB LINE, REMOVE PAVEMENT TO CURB.

REFER TO SPECIFICATIONS FOR DESCRIPTION OF BACKFILL AND BEDDING MATERIAL

AGGREGATE

BASE OR CR-6

PAVEMENT

AND SEAL

– NEW

PAVEMENT

• CLEAN STONE


DUCTILE IRON PIPE

(PEA GRAVEL)

BACKFILL

- 4. ALL SIDEWALKS SHALL BE CONSTRUCTED WITH TOOLED 1/4" EDGE AND JOINT RADII.

COCRETE PAVEMENT SECTION

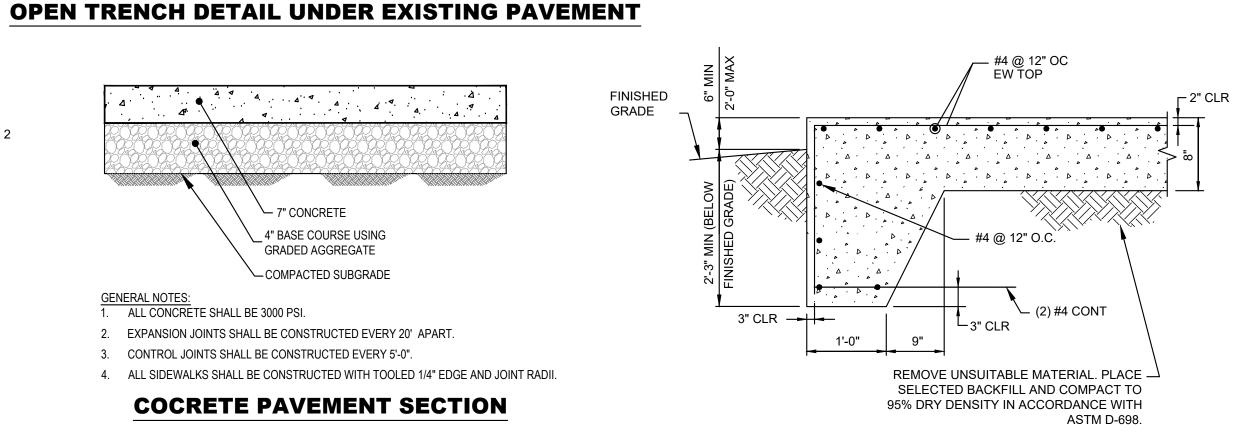

— WWF 6 X 6 - W2.9 X W2.9

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CONCRETE SIDEWALK

-COMPACTED


SUBGRADE

— 5" CONCRETE (3500 PSI)


— 4 " MINIMUM

AGGREGATE BASE

FIRE PUMP ENCLOSURE & TRANSFORMER CONCRETE PAD

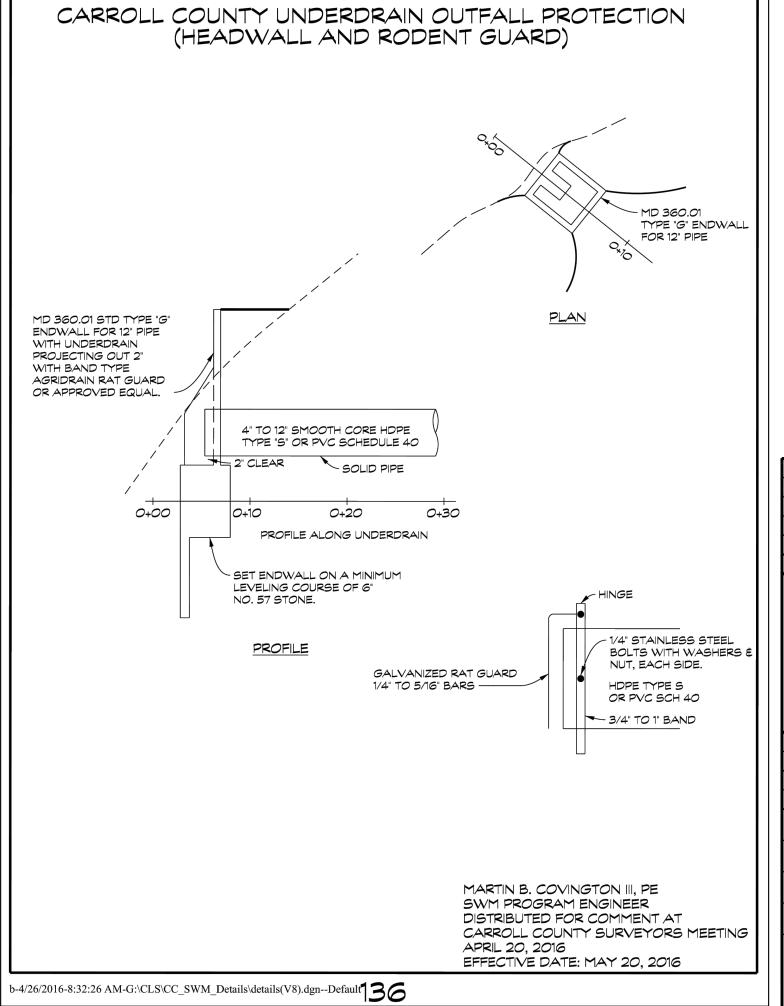

OWNER / DEVELOPER PENGUIN RANDOM **HOUSE LLC** C/O RYNE BARRALL 400 BENNETT CERF DRIVE WESTMINSTER, MD 21157 410-386-7725

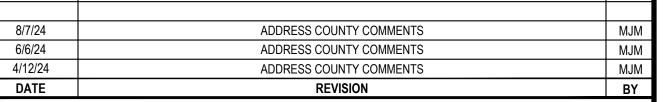


CONSTRUCTION DETAILS PENGUIN RANDOM HOUSE

FIRE PUMP UPGRADES 7th ELECTION DISTRICT CARROLL COUNTY, MARYLAND TAX MAP - 39 GRID - 20 PARCEL - 335 & 750


Surveyed By	Drawn By
BPR	МЈМ
Computed By	Checked By
BPR	BPR
Date:	FEBRUARY 22, 2024
Sheet:	4 OF 9
Scale:	AS SHOWN
BPR Drawing No.:	22-0614

CC FILE #: S-24-0005

SURVEYORS - LAND PLANNERS 150 AIRPORT DRIVE - SUITE 4 WESTMINSTER, MARYLAND 21157 PHONE: (410)-857-9030 OR (410)-876-0333 FAX: (410)-876-1532 WWW.BPRSURVEYING.COM

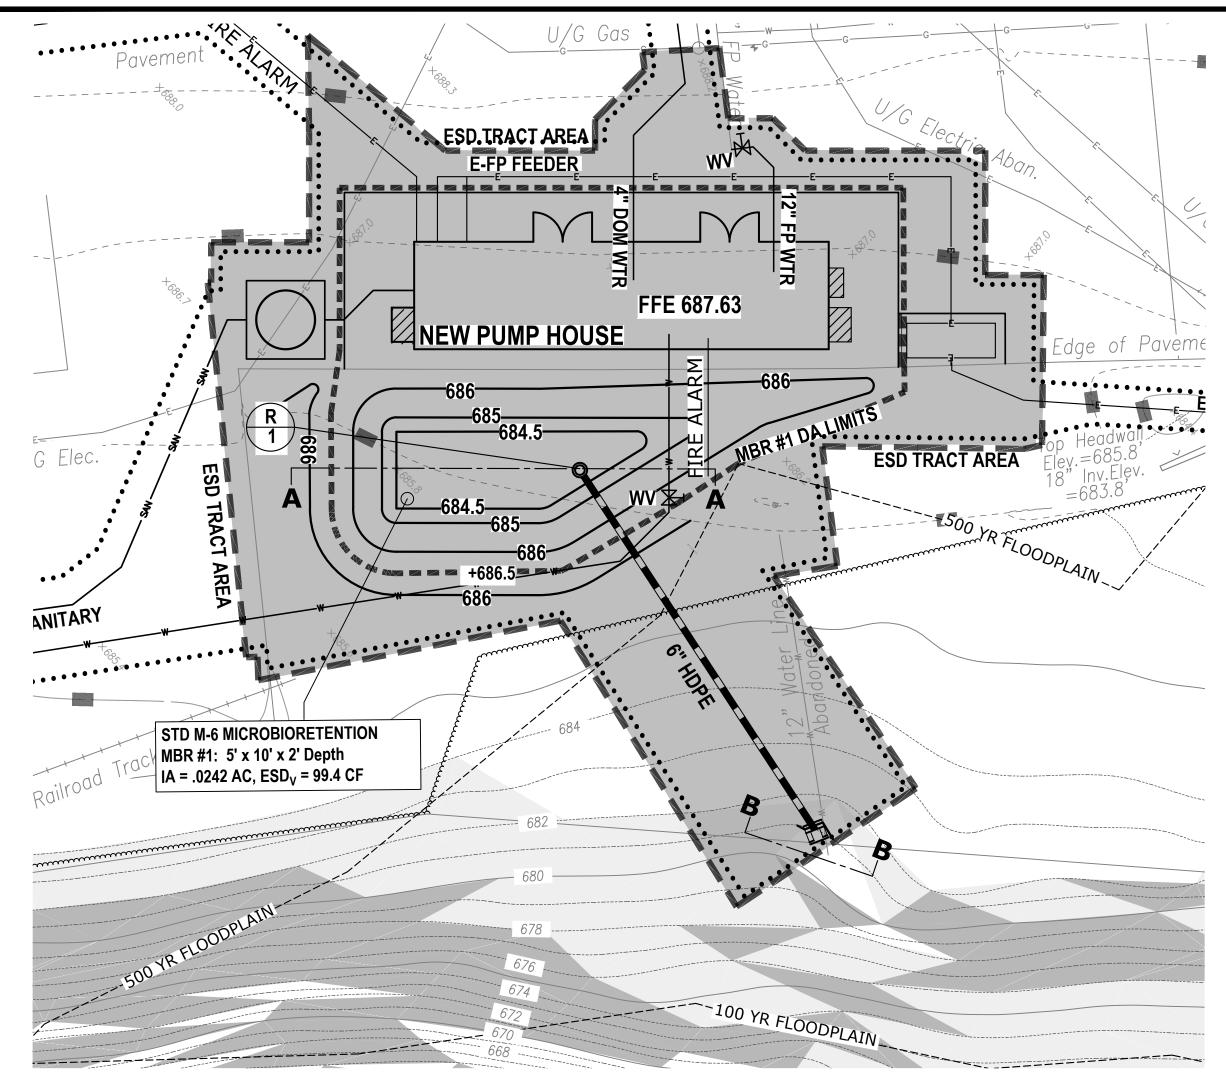

PLAN - MICRO-BIORENTION ESD #1

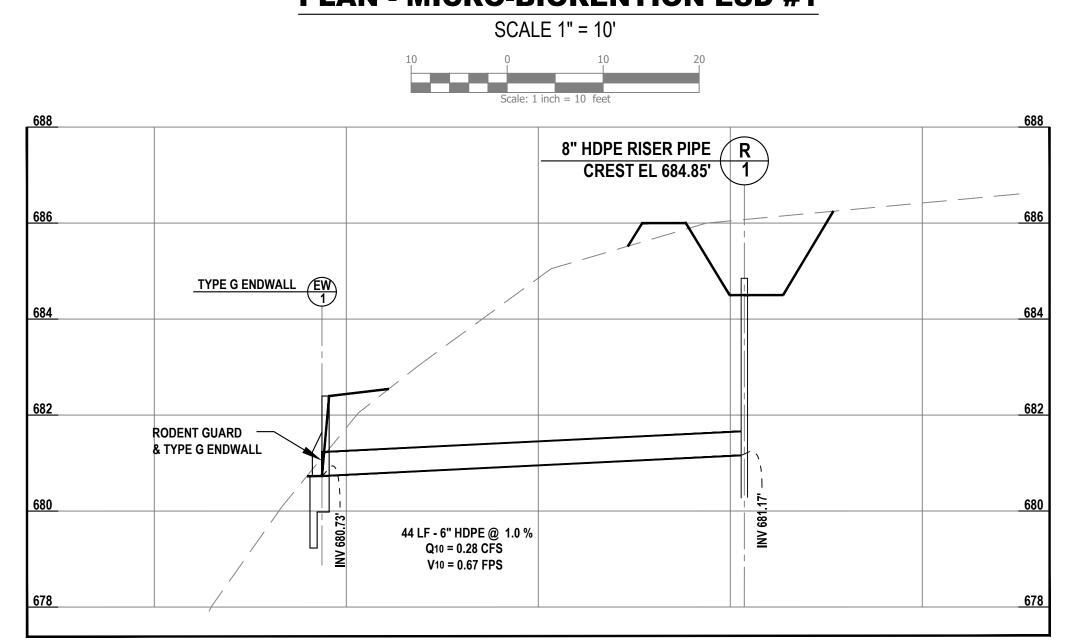


PROFILE R-1 TO EW-1

SCALE: H: 1" = 10' V: 1" = 2'

SEQUENCE OF CONSTRUCTION

- 1. Once the entire contributing drainage area to the MBR'S is paved, all buildings constructed, and minimum 2" stand of dense grass is established on all vegetated areas, contact the certifying inspector @ 410-857-9030 at least 48 prior to construction.
- 2. Excavate and grade the micro-bioretention bottom, side slopes, and embankment to meet plan line & grade. Embankment material and compaction shall be in accordance with the embankment specifications provided in the plans and verified by the geotechnical engineer
- specified above. Material and compaction test results shall be made readily available.
 Compact / prepare the subgrade with a vibratory plate or smooth drum roller. Place cushion soils or geotextile if required. All aspects of Liner placement shall be in accordance with the plan and manufacuter specification.
- 4. Place the No. 8 stone bedding construct the 4" underdrain piping as the stone placement progresses. Remove the riser temporary plug and complete the riser Installation to the weir crest elevation. Connect the 4" underdrain to the riser tee.
- 5. Restore any part of the embankment if disturbed during the riser installation in step 4 above, and complete final grading. Place planting soil over the stone bedding and complete the plantings and mulching. Extend the downspouts into the bioretention area when shown on the plans and install the splash block end treatment.
- 6. After the remaining disturbed areas have been stabilized with a 2" stand of dense grass, submit a signed and certified as-built plan to the Carroll County Bureau of Resource Management.

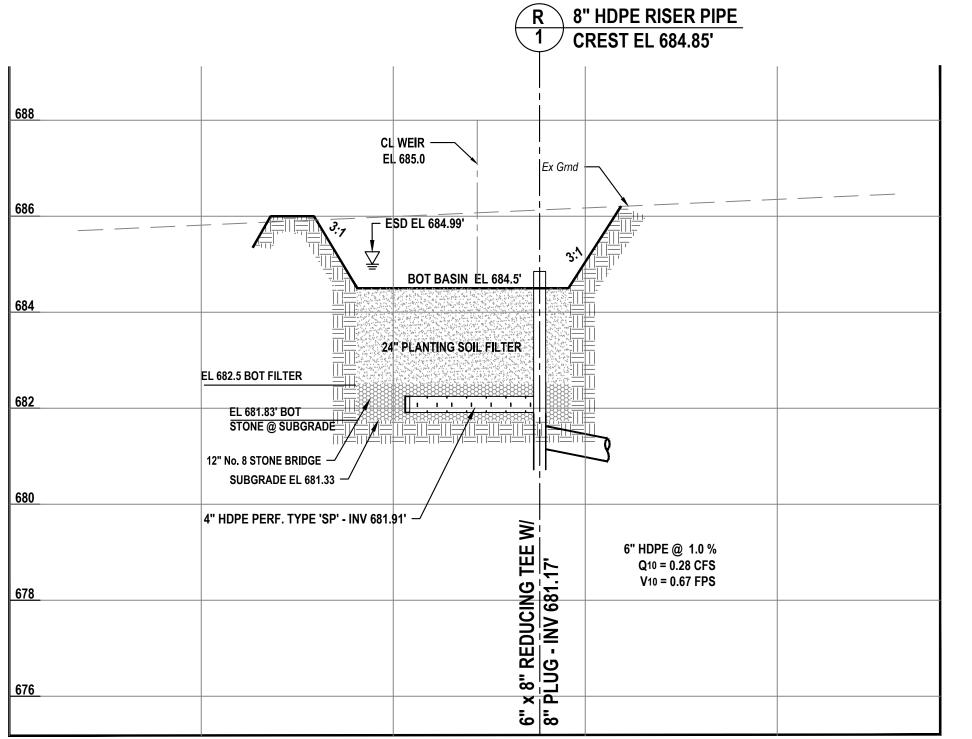

SECTION AA - PROFILE

SCALE: H: 1" = 10' V: 1" = 2'

MICRO-BIORETENTION MONTHLY INSPECTION

	STORMWATER MAINTEN	ANCE SCHEDULE				
Inspection Item	Inspection Requirements	Remedial Action				
Debris and Trash	Check for trash and debris in facility including inlets, outlets, conveyance systems, and area around facility.	Remove all trash and debris and dispose in an acceptable manner. Unclog all openings.				
Plant Composition and Health	Compare plant composition with approved plans. Check for invasive species or weeds. Check for dead or dying vegetation.	Remove invasive species and weeds. Replace dead plants in accordance with approved landscaping plan, OR Reseed and Remulch per Filter Bed Mix.				
Vegetative Cover	Check for channelizing, erosion, and bare spots. Check for vegetation blocking inlets, weirs, and outlet.	Remove or cut back vegetation around inlet, weirs, and Outlet Structures. Mow side slopes when grass exceeds 12 inches in height, but do not mow filter bed. If using Filter Bed Mix, may mow bed twice per year. Remove Grass Clippings. Re-seed or re-plant in accordance with approved landscaping plans.				
Mulch Layer	Check mulch for adequate cover, sediment accumulation or discoloration.	Replace and remove old mulch and excess sediment. Provide adequate mulch cover according to approved design				
SEASONAL INSPECTION AND AFTER A MAJOR STORM						
Inspection Item	Inspection Requirements	Remedial Action				
Dewatering	Check ponding levels. Surface storage must dewater within 48 hours of rainfall. Noticeable odors, stained water on the filter surface or at the outlet, or the presence of algae or aquatic vegetation are indicators of anaerobic conditions and inadequate dewatering of the facility.	Remove and replace top few inches of media. If the facility does not function as intended after the above action, excavate, remove, clean and replace stone, underdrain, media, and plants in accordance with approved plans.				
Erosion	Check inlets, filter bed, outlets, and side slopes for erosion, rills, gullies, and runoff channelization.	Re-grading may be required when concentrated flow causes rills or gullying through the facility. Grade, vegetate, and/or armor to provide stable conveyance in accordance with approved plans.				
Sediment Accumulation	Check for accumulated sediment in conveyance systems and on filter bed. Check for clogged openings(Blockages).	When sediment accumulates to 1 inch depth, remove sediment. Remove sediment from clogged openings. Dispose of all sediment in an acceptable location.				
	ANNUAL INSPE	CTION				
Inspection Item	Inspection Requirements	Remedial Action				
Structural Components	Check for evidence of structural deterioration, spalling, or cracking. Inlet and outlet structures as well as riprap outfalls must be in good condition.	Repair to good condition according to specifications on the approved plans.				
Overall Function of Facility	Check that practice is functioning as designed.	Repair to good condition according to specifications on the approved plans.				

DEVELOPER'S CERTIFICATION

I hereby certify that all proposed work shown on these construction drawing(s) will be conducted in strict accordance with these plans. I also understand that it is my responsibility to have the construction supervised and certified, including the submittal of "as- Built" plans certified by a registered Professional Engineer or Professional Land Surveyor, as appropriate, within thirty (30) days of completion of work on the stormwater management facility/facilities. I also certify that this/these stormwater management facility/facilities will be inspected during construction by a registered Professional Engineer or Professional Land Surveyor, as appropriate, in accordance with Sections § 136-22 and § 136-23 of the Charter and Code of the City of Westminster, MD.

ENGINEER'S DESIGN CERTIFICATION
ereby certify that these plans have been designed according to Chapter 136 of the Charter and Code of the City estminster, MD and I hereby certify that these documents were prepared or approved by me, and I am a du ensed Professional Engineer or Professional Land Surveyor, as appropriate, under the laws of the State of Maryland

Expiration Date:

License No.

ENGINEER'S "AS-BUILT" CERTIFICATION

I hereby certify that the facility/facilities shown on this/these plan(s) was constructed as shown on the "As-Built" plans and meets the approved plans and specifications. I also certify that this/these facilities were inspected in accordance with Sections § 136-22 and § 136-23 of the Charter and Code of the City of Westminster, MD and I hereby certify that these documents were prepared or approved by me, and I am a duly licensed Professional Engineer or Professional Land Surveyor, as appropriate, under the laws of the State of Maryland.

Signed:	Date:
icense No.:	Expiration Date:

	MBR #1 STAGE INSPECTOR'S A							
	STAGE	INITIALS	DATE					
1	ENTIRE CONTRIBUTING DRAINAGE AREA TO THE MBR'S IS PAVED, ALL BUILDINGS CONSTRUCTED, AND MINIMUM 2" STAND OF DENSE GRASS IS ESTABLISHED ON ALL VEGETATED AREAS.	INTIVALO	DAIL					
2	BOTTOM, SIDE SLOPES, AND EMBANKMENT EXCAVATED AND FINE GRADED TO PLAN LINE AND GRADE.							
3	EMBANKMENT MATERIAL & COMPACTION IS AS SPECIFIED IN THE PLANS AND VERIFIED BY INSPECTION & TESTING FROM A GEOTECHNICAL ENGINEER.							
4	4" UNDERDRAIN PIPING AND NO. 8 STONE BEDDING PLACED. RISER PIPE EXTENDED TO WEIR ELEVATION AND TRASH RACK INSTALLED. UNDERDRAIN PIPE CONNECTED TO RISER AND ANTI-FLOAT ANCHOR INSTALLED							
5	EMBANKMENT RESTORED AND FINAL GRADING COMPLETED. PLANTING SOIL PLACED AND BIO-RETENTION PLANTINGS COMPLETED AND MULCHED. DOWNSPOUTS LEADER PIPES ENTER ON LEVEL SLOPE & SPLASH BLOCK PLACED.							
6	ENDWALL PLACED AND CONNECTED TO DRAIN PIPE. RODENT GUARD INSTALLED ON ENDWALL							
7	ALL REMAINING DISTURBED VEGETATED AREAS STABILIZED WITH A 2" STAND OF DENSE GRASS.							
8	A SIGNED AND CERTIFIED AS-BUILT PLAN SUBMITTED TO THE CARROLL COUNTY BUREAU OF RESOURCE MANAGEMENT.							
(NOTIFY CERTIFYING ENGINEER'S 48 HRS PRICE CONSTRUCTION CERTIFYING ENGINEER'S NAME: BPR, LLC	OR TO COM	MENCINO					

UTILITY TRENCHING INSPECTION CHART

STAGE

PHONE #: (410) 857-9030


PHONE #:__

GEOTECHNICAL ENGINEER'S NAME:

MBR #1

INSPECTOR'S APPR.

		INITIALS	DATE	
1	ENTIRE CONTRIBUTING DRAINAGE AREA TO THE MBR'S IS PAVED, ALL BUILDINGS CONSTRUCTED, AND MINIMUM 2" STAND OF DENSE GRASS IS ESTABLISHED ON ALL VEGETATED AREAS.			
2	BOTTOM, SIDE SLOPES, AND EMBANKMENT EXCAVATED AND FINE GRADED TO PLAN LINE AND GRADE.			
3	EMBANKMENT MATERIAL & COMPACTION IS AS SPECIFIED IN THE PLANS AND VERIFIED BY INSPECTION & TESTING FROM A GEOTECHNICAL ENGINEER.			
4	4" UNDERDRAIN PIPING AND NO. 8 STONE BEDDING PLACED. RISER PIPE EXTENDED TO WEIR ELEVATION AND UNDERDRAIN PIPE CONNECTED TO RISER.			
5	EMBANKMENT RESTORED AND FINAL GRADING COMPLETED. PLANTING SOIL PLACED AND BIO-RETENTION PLANTINGS COMPLETED AND MULCHED. DOWNSPOUTS LEADER PIPES ENTER ON LEVEL SLOPE & SPLASH BLOCK PLACED.			OWNER / DEVELOPER
6	ALL REMAINING DISTURBED VEGETATED AREAS STABILIZED WITH A 2" STAND OF DENSE GRASS.			
7	A SIGNED AND CERTIFIED AS-BUILT PLAN SUBMITTED TO THE CARROLL COUNTY BUREAU OF RESOURCE MANAGEMENT.			PENGUIN RANDOM HOUSE LLC
C	NOTIFY CERTIFYING ENGINEER'S 48 HRS PRICEONSTRUCTION CERTIFYING ENGINEER'S NAME: BPR, LLC	MENCING	C/O RYNE BARRALL 400 BENNETT CERF DRIVE WESTMINSTER, MD 21157 410-386-7725	

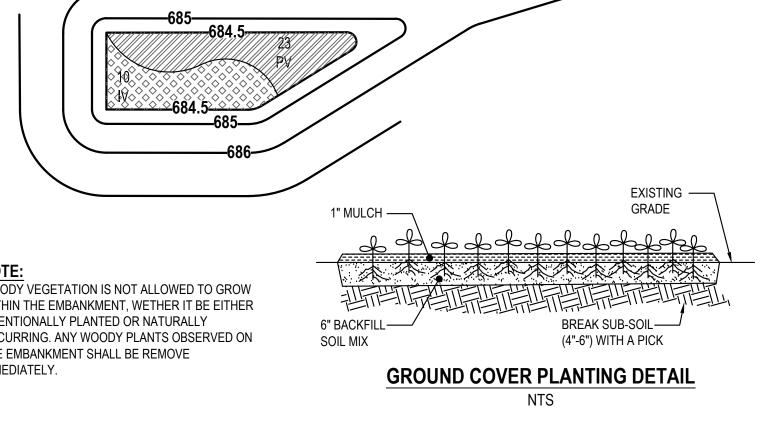

	PLANTING LIST								
NTITY	ID / SYMBOL	BOTANNICAL NAME / COMMON NAME	PLANT SPECIFICATION						
10	IV	ITEA VIRGINICA / ITEA	1 Gallon Pot, 4' o.c.						
23	PV	PANCIUM VIRGATUM / SWITCHGRASS	3" Pot, 2' o.c.						

MICRO BIO #1 PLANTING PLAN

SCALE: 1" = 10'

MATERIAL	SPECIFICATION	SIZE	NOTES
Plantings	See Landscape Plan	N/A	Plantings are Site Specific and per Approved Landscape Plan
Seed Mix	Filter Bed Mix - Use Wet Meadow Mix per MD Standards and Specifications 707. See Table 3 (lb. min / micro-bioretention)	N/A	Used with Straw Mulch in Place of Shredded Hardwood Mulch.
Mulch	Shredded Hardwood	N/A	Aged 6 Months, Minimum.
Straw Mulch	MD Standards and Specifications 707. (200 lb. min / micro-bioretention)	N/A	Straw Mulch over seed bed.
Geotextile	Class "C" - Apparent Opening Size (ASTM -D-4751), Grab Tensile Strength (ASTM -D-4632), Puncture Resistance (ASTM-D-4833)	N/A	Sides Only. Not on Bottom Unless Specified on the Plans.
Underdrain Gravel	AASHTO M-43 No. 8 Stone	3" - 1 <u>"</u>	Stone must be clean and washed
Underdrain Piping Riser Pipes	Slotted PVC or Slotted HDPE Type "SP" Pipes. Solid: Schedule 40 PVC or HDPE Type "S".	See Plan	Refer to Carroll County SWM Supplement Pg 87. All pipes must be double walled (smooth core) and slotted(no circular holes).
Sand	ASTM C-33 (3 Parts to 6 within Filter Media)	0.02" - 0.04"	Sand Substitutes such as Diabase and Graystone #10 are not Acceptable. No Calcium Carbonate & Dolomitic Sands Substitutions are Acceptable. No "Rock Dust" can be used for Sand. Manufactured Sand from approved sources may be used for filters Manufactured sand may not be used in Dams.
Soil	Engineer Approved Loam with 20% or less Clay (1 Part to 6 within Filter Media)	N/A	
Wood Chips	Untreated "Green" (2 Part to 6 within Filter Media)	N/A	Untreated "Green" Wood Chips
Filter/Planting Media	Comprised of 3 Parts Sand, 2 Parts Wood Chips, 1 Part Soil	N/A	See Individual Materials Specifications.
Embankments & Trench Backfill (non-378)	Soils used for embankments and trench backfill shall be uniform and in accordance with MD 378 Code, except that fill material shall conform to Unified Soil Classification, GC, SC, SM, MH, ML, CH, or CL and be compacted to a density of not less than 95% of maximum dry density. Woody vegetation is prohibited on embankments.	N/A	See Earth Fill and Structure Backfill, Carroll County Construction Specifications Carroll County SWM Supplement, Page 130
Principal Spillway Pipe (non⊡378)	Shall be in accordance with MD 378 Code, except that all pipe joints are to be gasketed and completely watertight. Pipes connected to risers (inlets) shall be a single piece 20-feet long with no joints.	N/A	See Pipe Conduits, Carroll County Construction Specifications Carroll County SWM Supplement, Page 131

8/7/24	ADDRESS COUNTY COMMENTS	MJM
6/6/24	ADDRESS COUNTY COMMENTS	MJM
4/12/24	ADDRESS COUNTY COMMENTS	MJM
DATE	REVISION	BY

SWM GRADING PLAN & ESD MAPPING, NOTES & DETAILS PENGUIN RANDOM HOUSE

FIRE PUMP UPGRADES
7th ELECTION DISTRICT CARROLL COUNTY, MARYLAND
TAX MAP - 39 GRID - 20 PARCEL - 335 & 750

BPR MJM Computed By Checked By BPR BPR **FEBRUARY 22, 2024** PENGUIN RANDOM Sheet: 5 OF 9 **HOUSE LLC** C/O RYNE BARRALL Scale: **AS SHOWN** 400 BENNETT CERF DRIVE WESTMINSTER, MD 21157 BPR Drawing No.: 22-0614 410-386-7725

Surveyed By

BPK LLC

SURVEYORS - LAND PLANNERS

150 AIRPORT DRIVE - SUITE 4
WESTMINSTER, MARYLAND 21157

CC FILE #: S-24-0005


Drawn By

150 AIRPORT DRIVE - SUITE 4
WESTMINSTER, MARYLAND 21157
PHONE: (410)-857-9030
OR (410)-876-0333
FAX: (410)-876-1532
WWW.BPRSURVEYING.COM


	MONTHLY INSPECTION						
Inspection Item	Inspection Requirements	Remedial Action					
Vegetative Cover and Erosion	Check for vegetation over 4" in height. Check the Soil Restoration area for channelizing and bare spots.	Mow grass/remove trees and shrubs. re-grade if the concentrated flow is causing rills or gullying on the surface. re-seed as necessary.					
	SEASONAL INSPECTION AND AFTER A MAJOR STORM						
Inspection Item	Inspection Requirements	Remedial Action					
Inflow	Ensure sheet flow from pavement to grass area.	Remove debris and vegetation, regrade and re-seed as necessary to ensure sheet floe from pavement.					
Dewatering	Check for soft areas and/or soil saturated to the surface.	If necessary, excavate, remove, and replace the soil and re-seed.					
	ANNUAL INSPECTIO)N					
Inspection Item	Inspection Requirements	Remedial Action					
Overall Function	Check that grass areas remain and have not been compacted or paved.	Repair to good condition according to specifications on the approved plans.					

	PAVEMENT REMO							
	INSPECTION CH	ART						
		M	BR #1					
	STAGE	INSPECT	OR'S APPR.					
		INITIALS	DATE					
1	PAVEMENT AND GRAVEL BASE REMOVED AND DISPOSED OF OFFSITE, MINIMUM 6"							
2	SUBSOIL BROKEN UP TO 20" IN DEPTH. TILL OR MIX IN 10" MINIMUM TOPSOIL BUT AS MUCH AS NECESSARY TO BRING THE SURFACE TO 4" ABOVE ORIGINAL GRADE.							
3	SOIL RESTORED AND FINAL GRADING COMPLETED. PLANTING SOIL PLACED AND SEEDED AND MULCHED.							
4	A SIGNED AND CERTIFIED AS-BUILT PLAN SUBMITTED TO THE CARROLL COUNTY BUREAU OF RESOURCE MANAGEMENT.							
*NOTIFY CERTIFYING ENGINEER'S 48 HRS PRIOR TO COMMENCING CONSTRUCTION CERTIFYING ENGINEER'S NAME: BPR, LLC								
F	PHONE #: (410) 857-9030							
	GEOTECHNICAL ENGINEER'S NAME:PHONE #:							


	STACE		INSPECTOR'S APPR.	
STAGE		INITIALS	DATE	
1	EXISTING BITUMINOUS PAVING SAWCUT 12" BEYOND EDGE OF TRENCH IN PAVED AREAS.			
2	TRENCH EXCAVATED TO A WIDTH OF PIPE OUTER DIAMETER +2'.			
3	PVC PIPE INSTALLED ON MINIMUM 6" CLEAN STONE BACKFILL. DUCTILE IRON PIPE INSTALLED ON TRENCH SUBGRADE. TRACER WIRE LOCATED BELOW DEAD CENTER OF PIPE. SPLICING SHALL BE ENCASED WHERE REQUIRED			
4	TRENCH BACKFILLED WITH CLEAN STONE BACKFILL. MARKING TAPE PLACED 12" ABOVE PIPE.			
5	UTILITY TRENCHING RETURNED EXISTING LINE, GRADE, AND HYDROLOGIC CONDTIONS.			
6	A SIGNED AND CERTIFIED AS-BUILT PLAN SUBMITTED TO THE CARROLL COUNTY BUREAU OF RESOURCE MANAGEMENT.			
C	NOTIFY CERTIFYING ENGINEER'S 48 HRS PRICE CONSTRUCTION CERTIFYING ENGINEER'S NAME: BPR, LLC HONE #: (410) 857-9030	OR TO COM	MENCING	

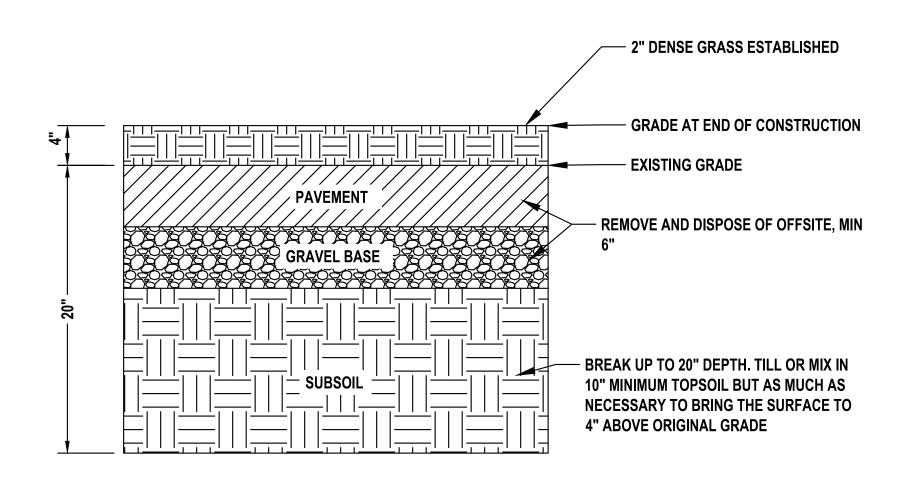

PAVEMENT REMOVAL "URBAN SOIL RESTORATION" DETAIL **EXISTING FIRE PUMP HOUSE** NTS

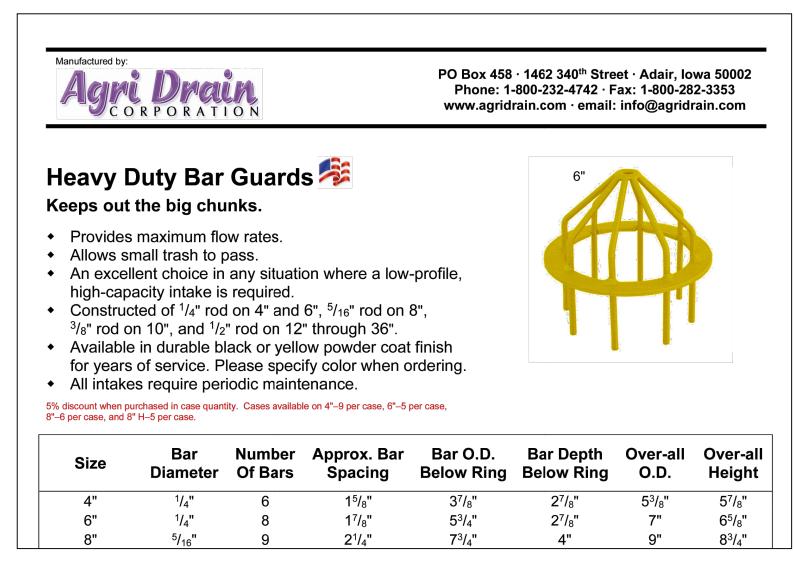


8" BAR GUARD FOR MICRO-BIORETENTION RISER PIPE R-1

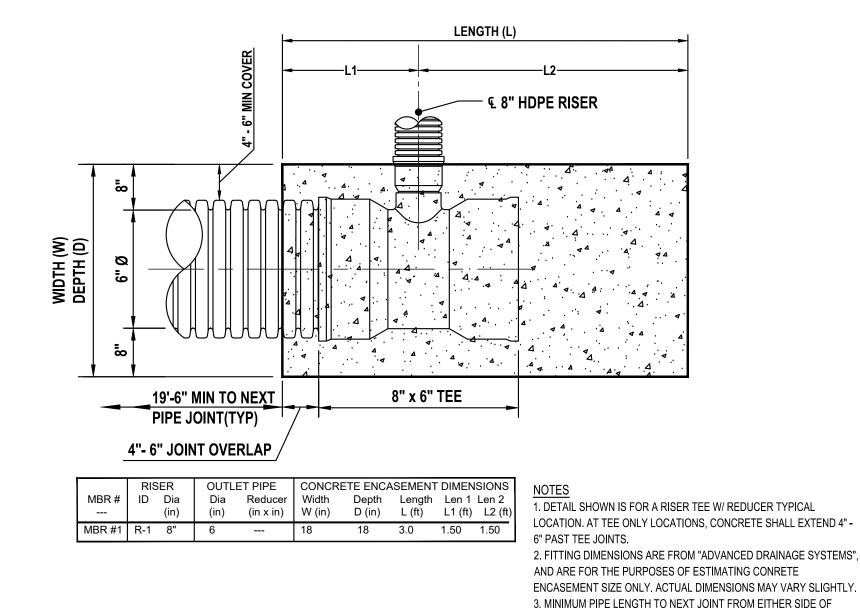

CONCRETE ENCASEMENT FOR ANTI-FLOATATION DETAIL (@8" HDPE RISER FOR MICROBIORETENTION #1)

FITTING JOINTS IS 20'-0".

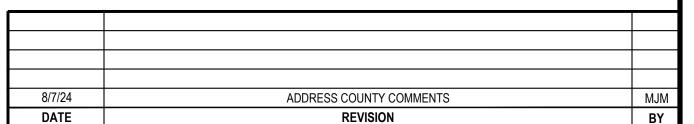

STORMWATER MANAGEMENT NOTES & DETAILS PENGUIN RANDOM HOUSE


FIRE PUMP UPGRADES 7th ELECTION DISTRICT CARROLL COUNTY, MARYLAND TAX MAP - 39 GRID - 20 PARCEL - 335 & 750


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OWNER / DEVELOPER	Surveyed By	Drawn By	
	BPR	МЈМ	
	Computed By	Checked By	
	BPR	BPR	
DENOUGH DANDOM	Date:	FEBRUARY 22, 2024	
PENGUIN RANDOM HOUSE LLC	Sheet:	6 OF 9	
C/O RYNE BARRALL 400 BENNETT CERF DRIVE	Scale:	AS SHOWN	
WESTMINSTER, MD 21157 410-386-7725	BPR Drawing No.:	22-0614	
553 1120			

CC FILE #: S-24-0005

SURVEYORS - LAND PLANNERS 150 AIRPORT DRIVE - SUITE 4 WESTMINSTER, MARYLAND 21157

PHONE: (410)-857-9030 OR (410)-876-0333 FAX: (410)-876-1532 WWW.BPRSURVEYING.COM

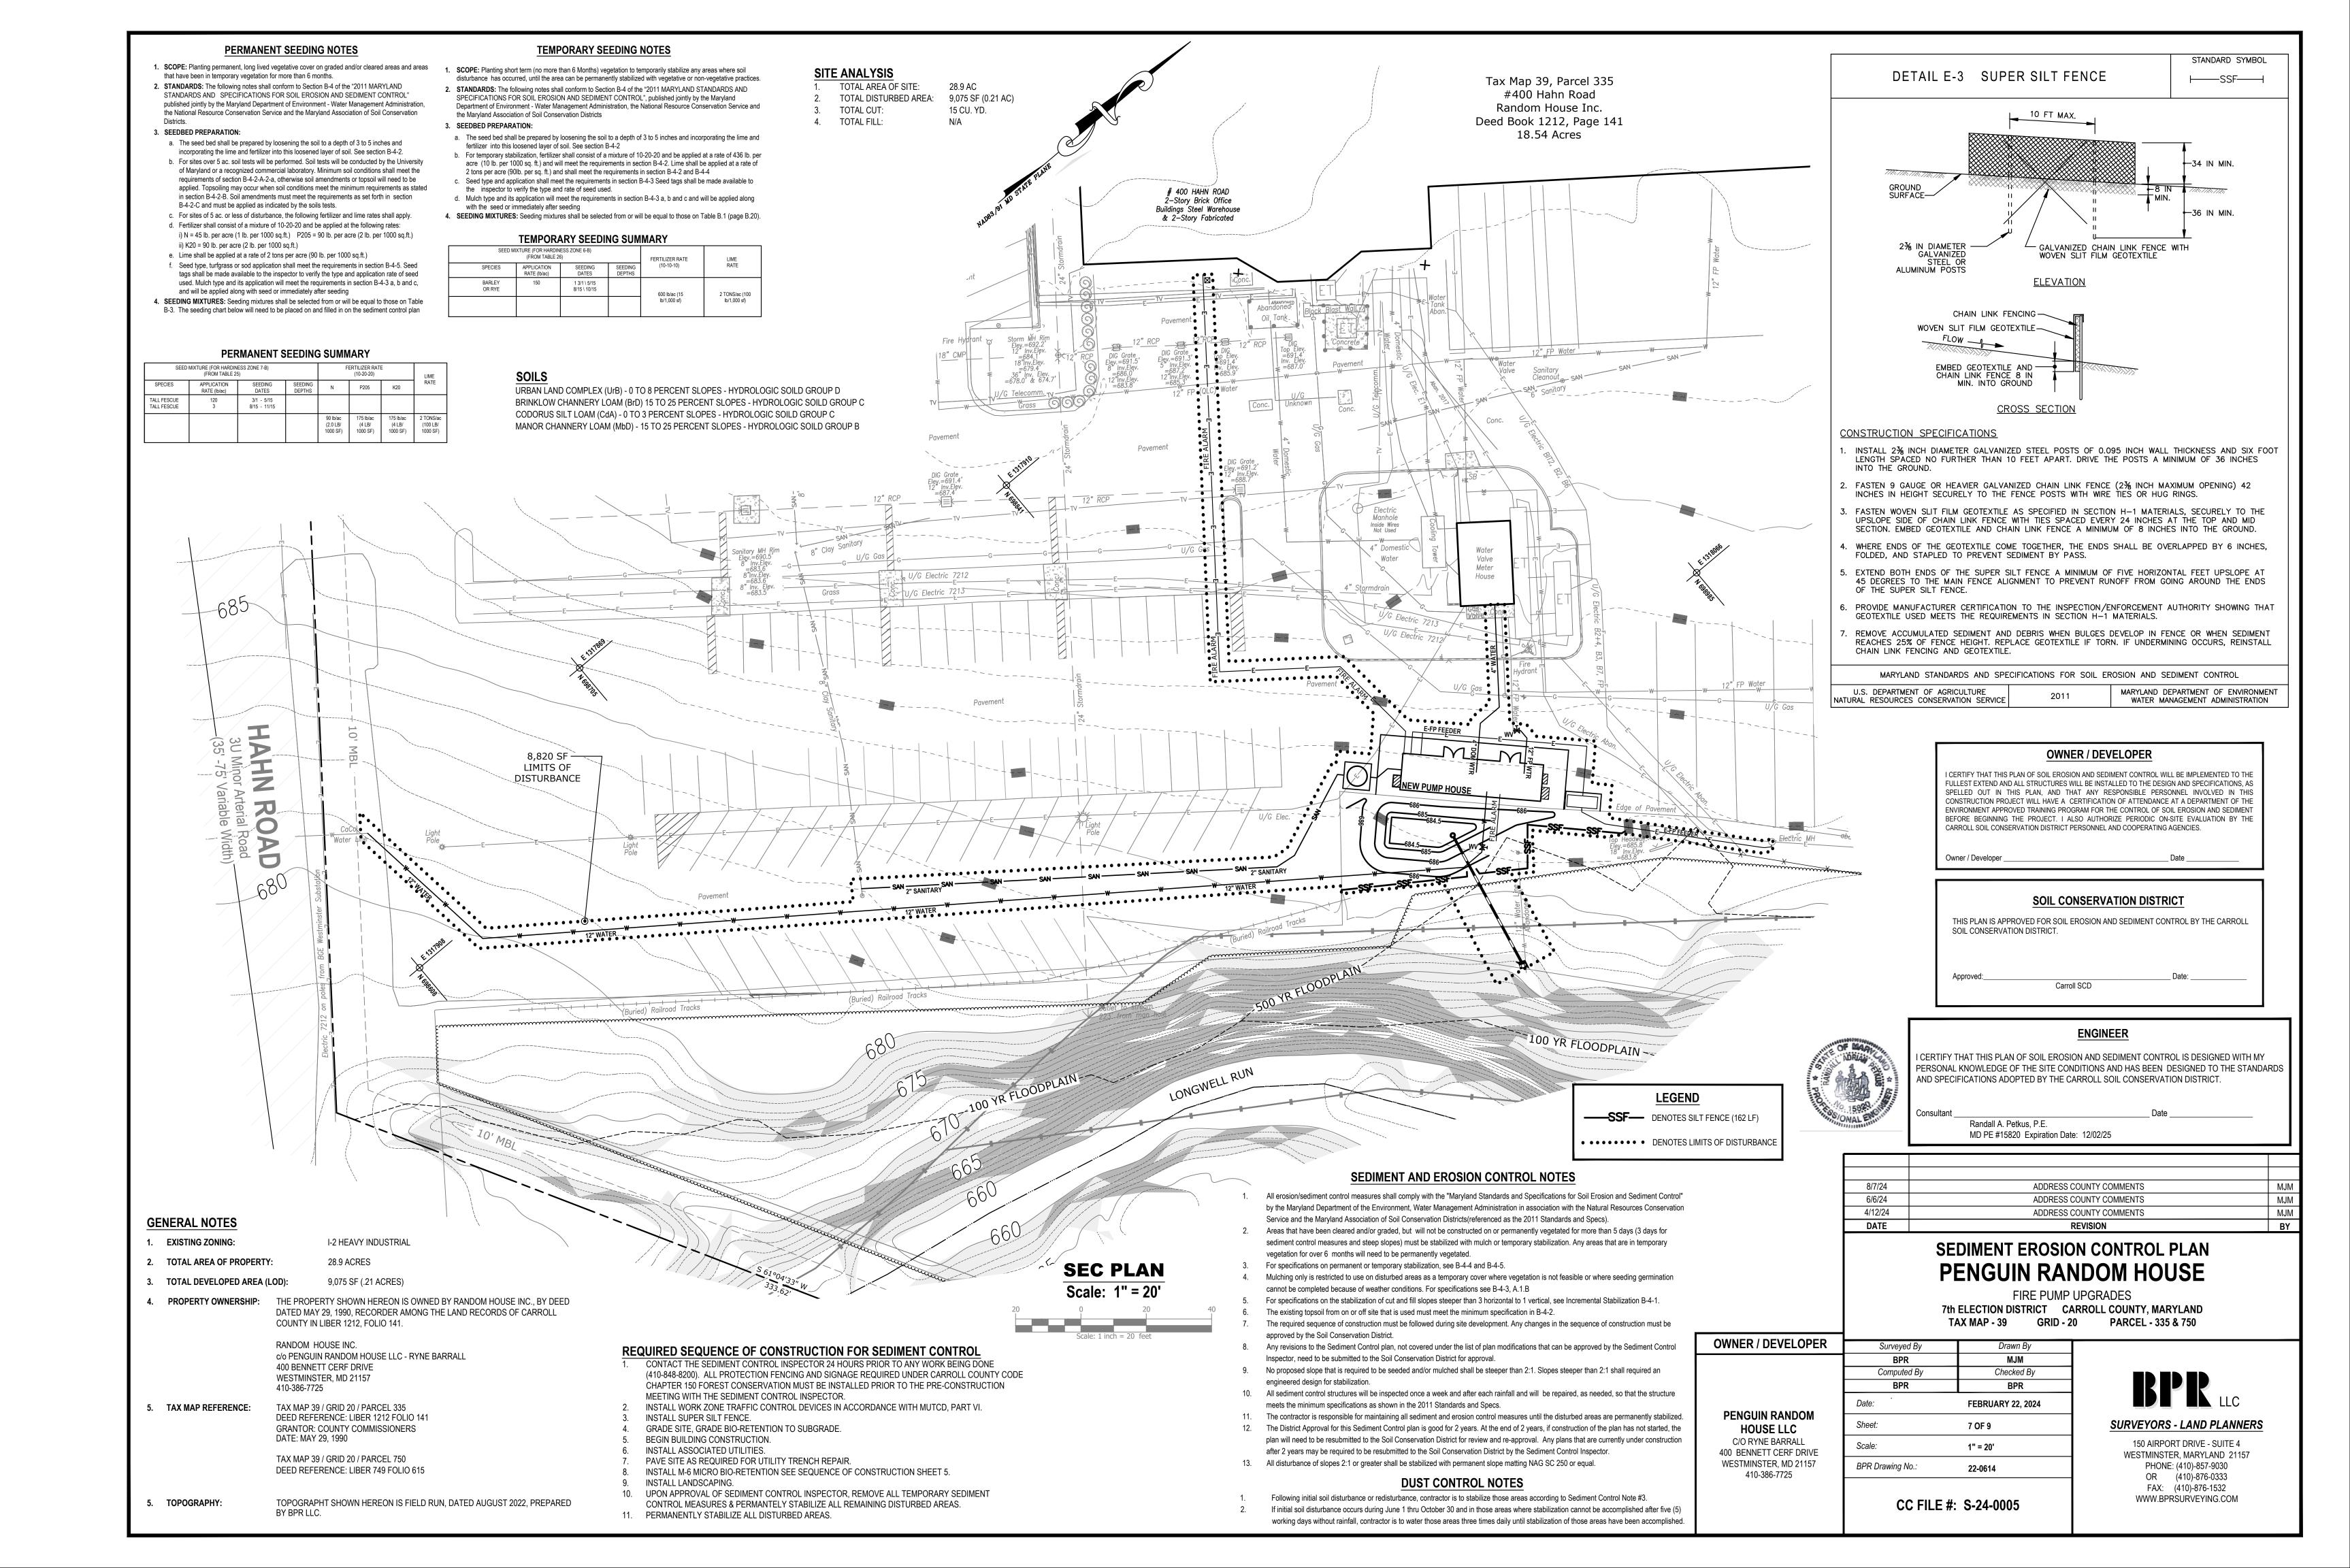

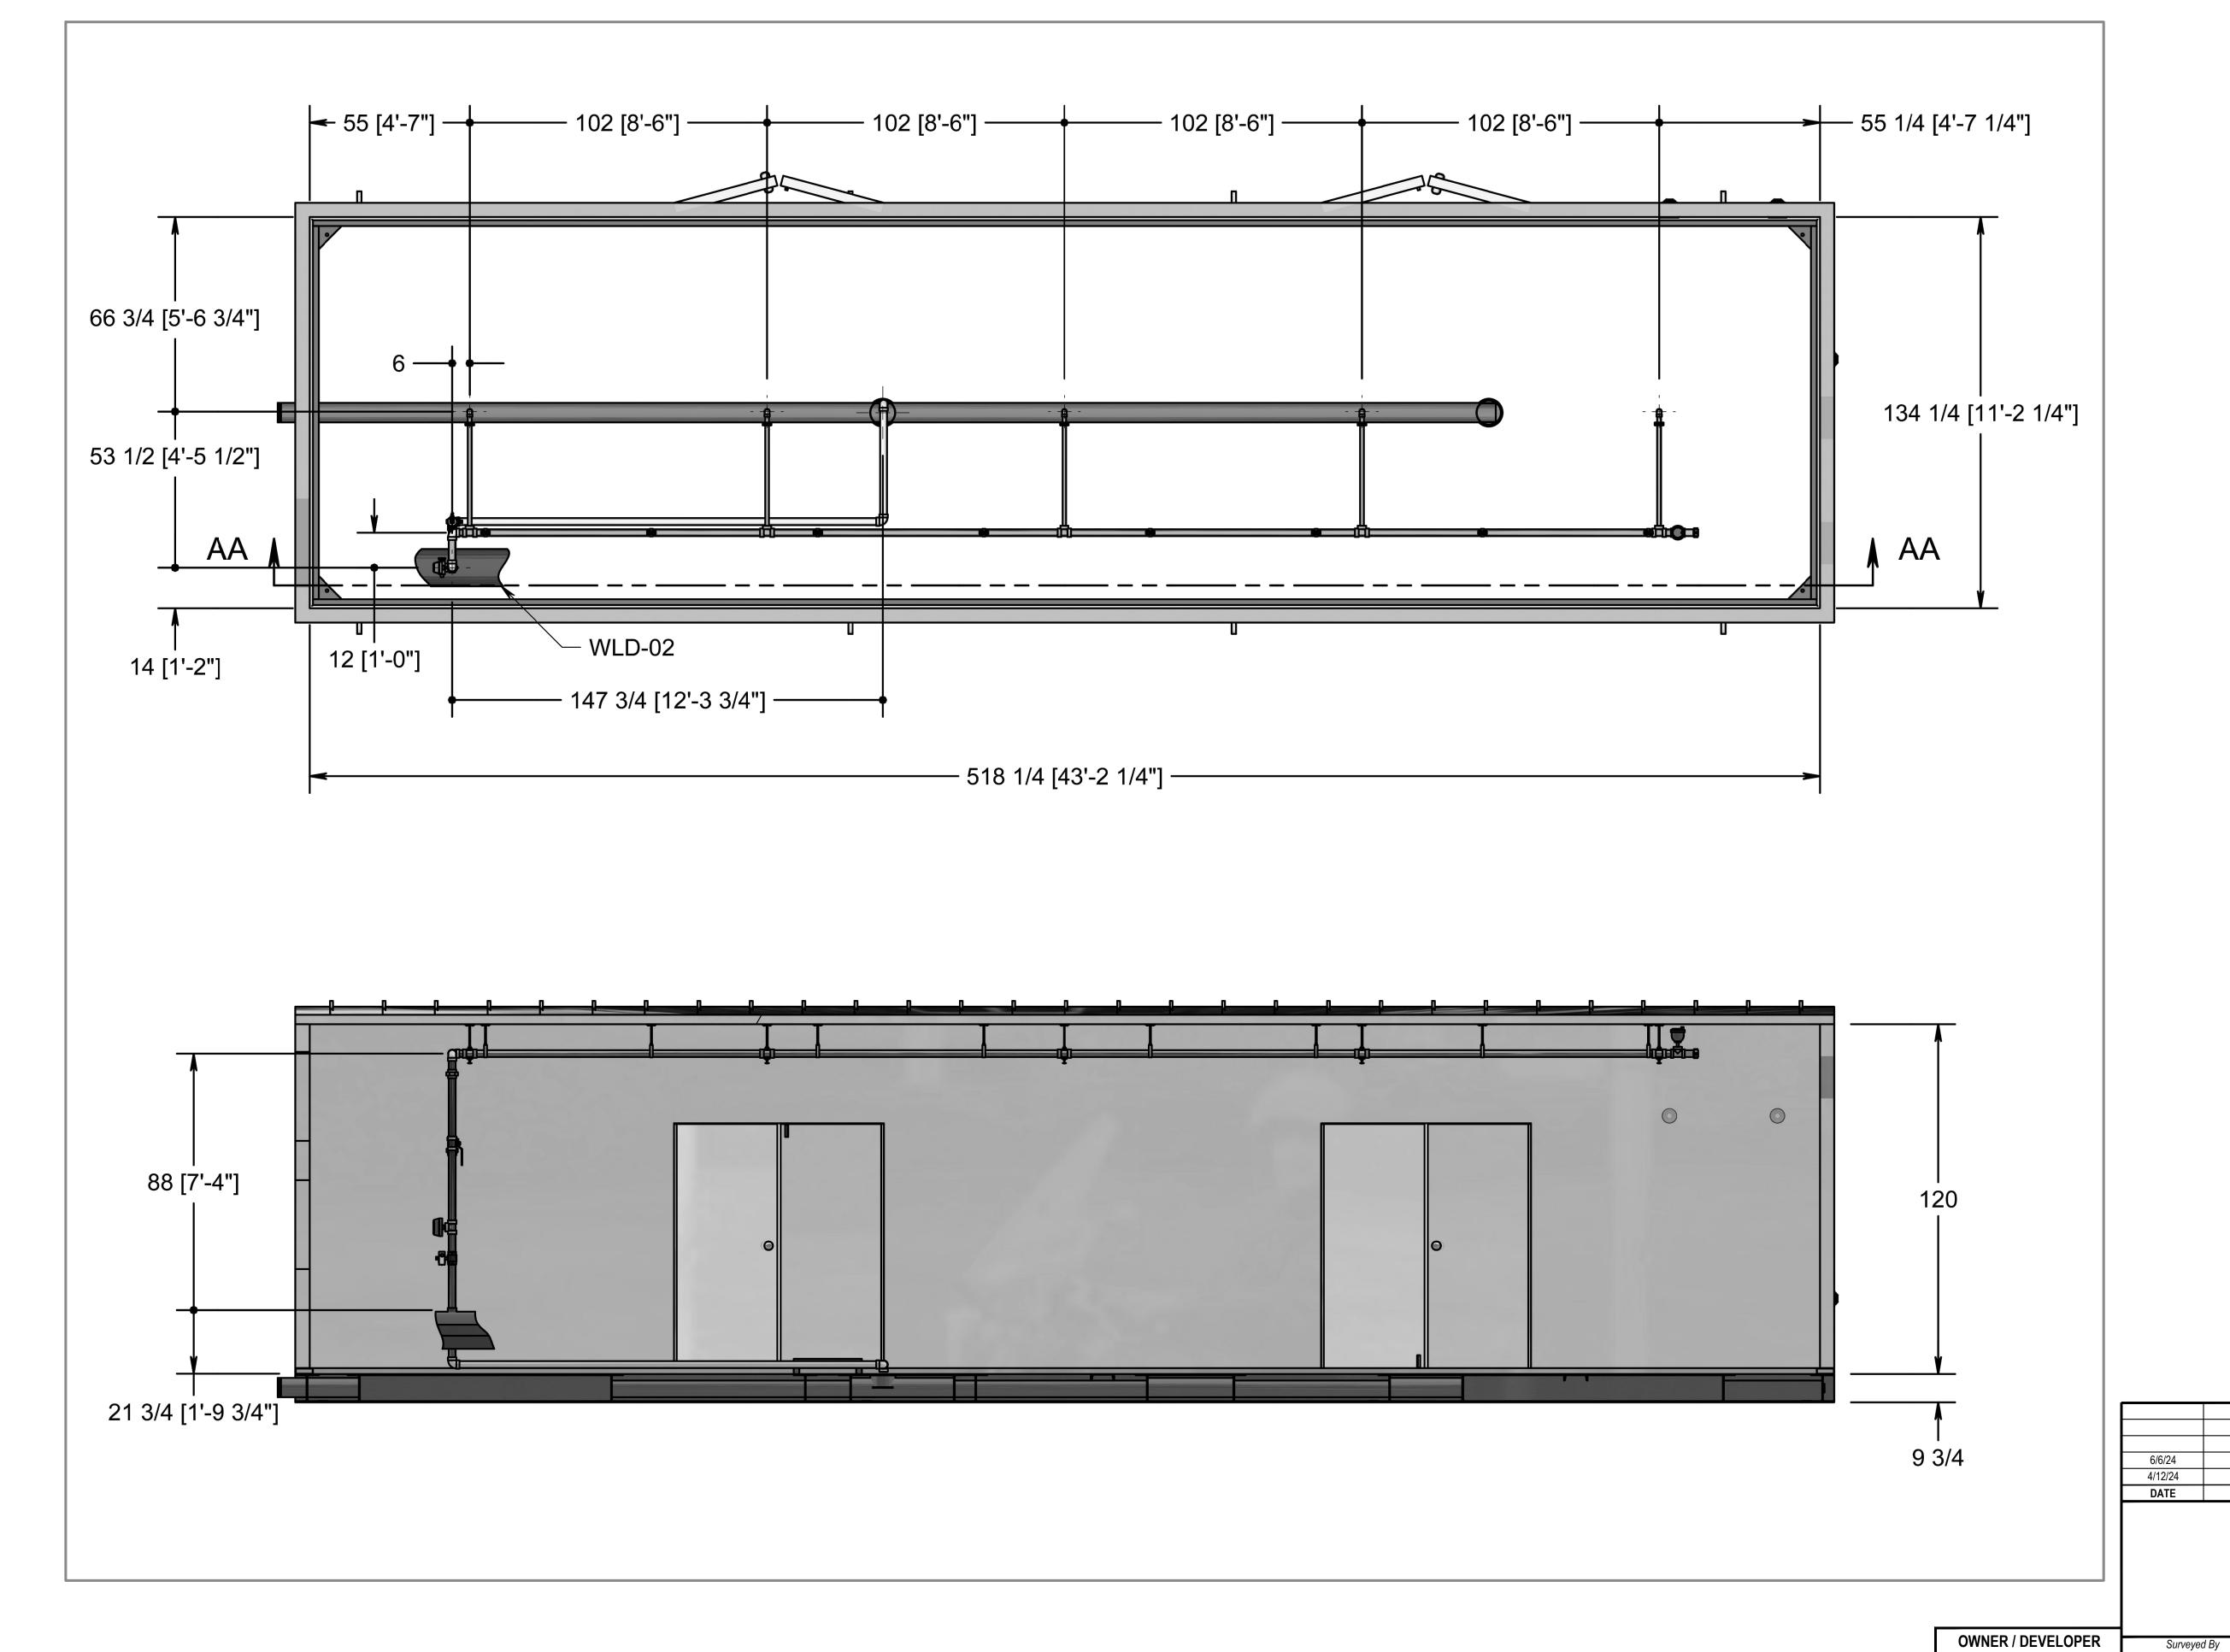

DATE	REVISION	BY
4/12/24	ADDRESS COUNTY COMMENTS	MJM
6/6/24	ADDRESS COUNTY COMMENTS	MJM

PUMP HOUSE BUILDING ELEVATIONS PENGUIN RANDOM HOUSE

FIRE PUMP UPGRADES 7th ELECTION DISTRICT CARROLL COUNTY, MARYLAND
TAX MAP - 39 GRID - 20 PARCEL - 335 & 750

> Drawn By MJM

	BPR	MJM
	Computed By	Checked By
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DENOLUN DANDOM	Date:	FEBRUARY 22, 2024
PENGUIN RANDOM HOUSE LLC	Sheet:	8 OF 9
C/O RYNE BARRALL 400 BENNETT CERF DRIVE	Scale:	NOT TO SCALE
WESTMINSTER, MD 21157 410-386-7725	BPR Drawing No.:	22-0614



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