
1. 2.	EXISTING ZONING: TOTAL AREA OF PROPERTY		INDUSTRIAL S			
3.	TOTAL DEVELOPED AREA (L	OD): 9,075 SF (.	21 ACRES)			
4.	PROPERTY OWNERSHIP:	DATED MAY 29, 1990, RE COUNTY IN LIBER 1212,	CORDER AMONG THE	Y RANDOM HOUSE INC., BY DEED AND RECORDS OF CARROLL		
		RANDOM HOUSE INC. c/o PENGUIN RANDOM H 400 BENNETT CERF DRI WESTMINSTER, MD 2115 410-386-7725	/E	RALL		
5.	TAX MAP REFERENCE:	TAX MAP 39 / GRID 20 / F DEED REFERENCE: LIBE GRANTOR: COUNTY CON DATE: MAY 29, 1990 TAX MAP 39 / GRID 20 / F	R 1212 FOLIO 141 /MISSIONERS			
5.	TOPOGRAPHY:	DEED REFERENCE: LIBE	R 749 FOLIO 615	FION OF FIELD RUN - DATED		
		AND CARROLL COUNTY	DOES NOT WARRANT I	ARROLL COUNTY LIDAR PRODUCTS TS ACCURACY FOR ANY PURPOSES.		<u>}</u>
6.	FIRE PROTECTION SOURCE:			VAILABLE FOR FIRE PROTECTION NG (ON-SITE) WATER VALVE METER		
7.	EXISTING UTILITIES:	CONTRACTOR SHALL VE	RIFY THE EXISTENCE, SHALL NOTIFY THE EN	HEREON ARE APPROXIMATE ONLY. LOCATION, AND DEPTH OF ANY IGINEER/SURVEYOR OF ANY		
8.	MISS UTILITY:			-800-257-7777 THREE WORKING HE VICINITY OF EXISTING		
9.	PLAN DIMENSIONS:		DIMENSIONS SHOWN O	OF A DISCREPANCY BETWEEN THE N THESE PLANS, THE FIGURED		
10.	CHANGES TO THE PLAN:			N AMENDED SITE DEVELOPMENT NTY PLANNING AND ZONING		
11.	SITE PLAN EXPIRATION:	THE APPROVAL IF NO BU	JILDING PERMIT OR ZO	N MONTHS AFTER THE DATE OF NING CERTIFICATE HAS BEEN ISION OF THIS TIME LIMIT IS		
	ITE DATA					_
	PROPOSED USE: BUILDING HEIGHT:	NEW FACILITY PUM	P HOUSE			
	SIGNAGE:	NO PROPOSED SIG	NAGE.			
4.	LIGHTING:	NO PROPOSED SITE	E LIGHTING. THERI	E WILL BE BUILDING MOUNTED	FIXTURES.	
5. \$	SOILS:	BRINKLOW CHANNE CODORUS SILT LOA	ERY LOAM (BrD) 15 M (CdA) - 0 TO 3 PE	PERCENT SLOPES - HYDROLOG TO 25 PERCENT SLOPES - HYD ERCENT SLOPES - HYDROLOGI	ROLOGIC SOILD GRO C SOILD GROUP C	1
6.	FIRE PROTECTION:	MANOR CHANNERY	LOAM (MDD) - 15 T	O 25 PERCENT SLOPES - HYDR	OLOGIC SOILD GROU	Jh R
			_	E HYDRANT LOCATED AT THE V OWING FIRE PROTECTION REC		२
				IRE BUILDING FOOTPRINT		
7. I	PUBLIC WATER & SEWA	GE SERVICE:	-			
8. 3	STORMWATER MANAGE	MENT (SWM): OMPLIANCE WITH CA	RROL COUNTY SW	JBLIC WATER & SEWER SERVIO M CODE. ESD TO THE MEP HA	S BEEN ACHIEVED E	
9. 9			,	CCURRING DOWNSTREAM OF		
	UNDER SECTION 152.0 SEDIMENT CONTROL	005 FOR PROJECTS V REQUIREMENTS OF 1	/HICH DISTURB BE THE COUNTY'S "ST/	E CARROLL COUNTY GRADING A TWEEN 5,000 TO 30,000 SF. THE ANDARD SEDIMENT AND EROSI PLAN IS NOT REQUIRED.	E PROJECT WILL MEE	ET THE Tax
10.		RESOURCE PROTEC		S SITE LIES WITHIN THE METAV ON AREA, A SURFACE WATER M		
	MULTIPLE MANAGEME EXISTING OR POTENT	ENT AREA. IT IS NOT IAL MUNICIPAL WELL	WITHIN A CARBON SITES OR WELL SI	TE ROCK AREA, A WELLHEAD I	PROTECTION AREA,	OR NEAR ANY
	(02130907). THE ADJA	CENT STREAM (LONG	GWELL RUN) HAS A	STREAM USE DESIGNATION O	F I-P.	
	CAPACITY REMAINING	- AS DESIGNATED B	Y THE MARYLAND	DEPARTMENT OF THE ENVIRON	NMENT (MDE).	/
	DIRECTLY ADJACENT TOXIC SUBSTANCES:			NCE. LAN DOES NOT INVOLVE THE S	TORAGE, USE, SALE	OR
	REGULATED SUBSTAN	NCES ARE PROHIBITE	D.	UCH ACTIVITIES ARE INTENDEI	D FOR THIS PROPER	тү. \\
12.	TRAFFIC CONTROL PLA GARBAGE COLLECTION	I: NOT APPLICA	BLE.			
-	PARKING TABULATION STORMWATER MANAG					
	COMMISSIONERS OF	CARROLL COUNTY AS	S AN EASEMENT OF	CE AGREEMENT" IS TO BE GRA ACCESS TO THE COUNTY CO SIMULTANEOUSLY HEREWITH.	MMISSIONERS OR AU	
		<u>EXIS</u>			LEGEND	
	PROPERTY LI	NE SUBJECT		EDGE OF PAVEMENT		
	PROPERTY LIN	NE ADJOINER	777	DENOTES CONTOURS		PROPERTY LINE ADJOIN
	DENOTES ED		SSF SF			DENOTES EDGE OF RO/ DENOTES CURB
	DENOTE CENTER LI		• • • • • • • • • • • •			CENTER LINE ROAD
	DENOTES			OVERHEAD UTILITIES		DENOTES BUILDING
	DENOTES W			SOME		— DENOTES WATER LINE
	SANITARY S	EWER LINE IN MANHOLE				- SANITARY SEWER LINI STORMDRAIN MANHO
D S		IN MANHOLE WER MANHOLE	P.	AVEMENT (DRIVEWAYS / ROAD WATER VALVE	s) © S)	STORMDRAIN MANHO
0		/ER CLEAN OUT	WM _D	WATER METER	() ()	SANITARY SEWER CLEAN
	25% TO 509	% SLOPES	₩ •	FIRE HYDRANT	Ġ.	HANDICAP PARKING
		TER SLOPES	Ġ.	HANDICAP PARKING	1	

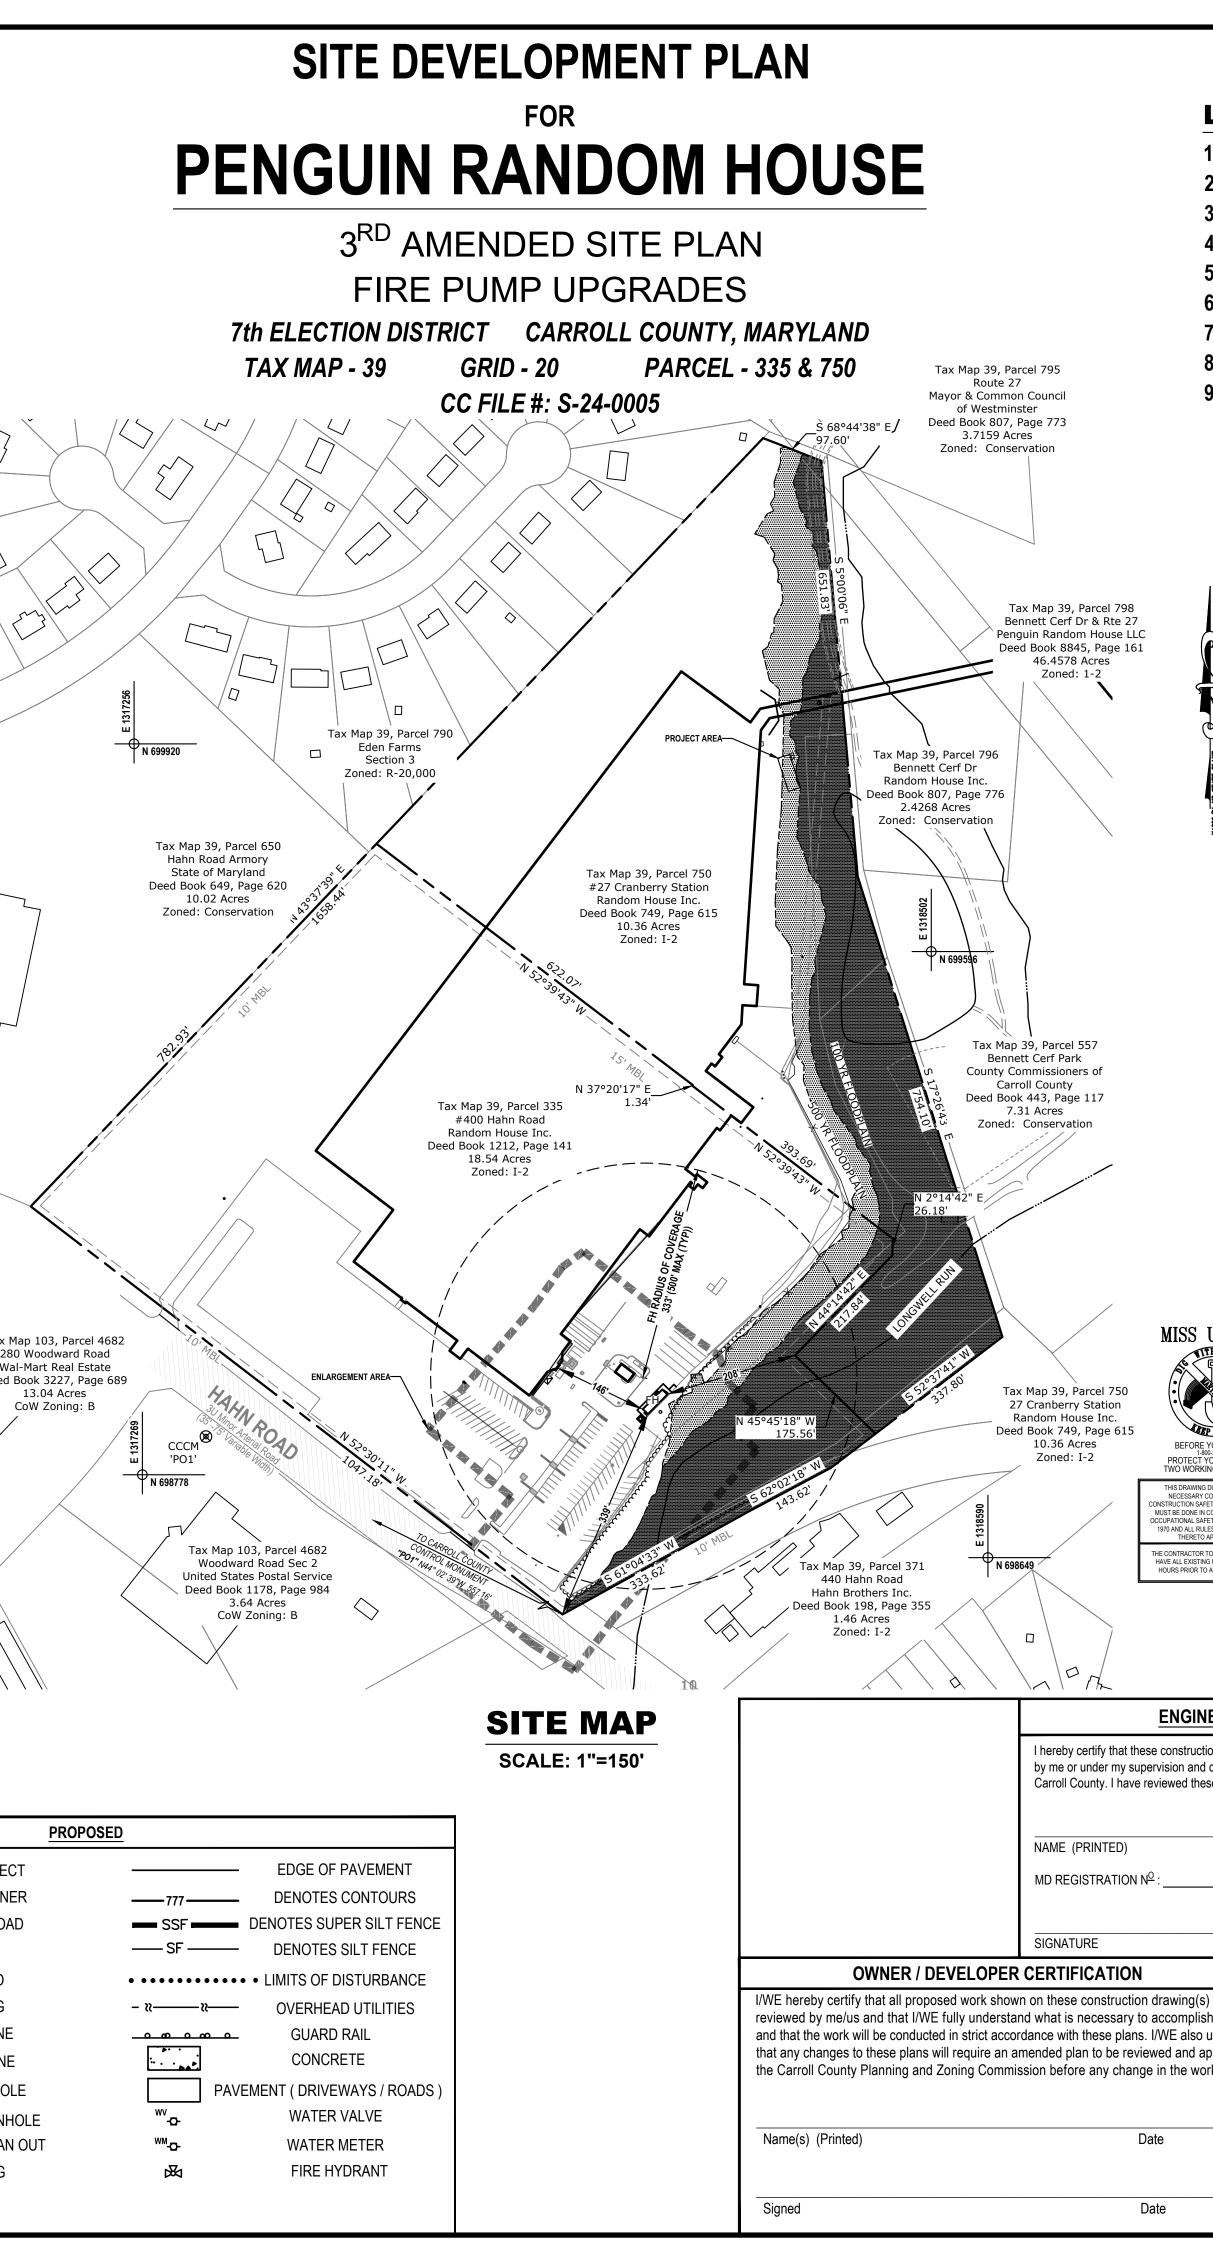

LIST OF DRAWINGS

- 1. TITLE SHEET
- 2. EXISTING CONDITIONS & DEMOLITION PLAN
- 3. SITE LAYOUT PLAN
- 4. CONSTRUCTION DETAILS
- 5. SWM GRADING PLAN & ESD MAPPING, NOTES & DETAILS
- 6. STORMWATER MANAGEMENT NOTES & DETAILS
- 7. SEDIMENT EROSION CONTROL PLAN
- 8. PUMP HOUSE BUIDLING ELEVATIONS
- 9. VARIABLE WIDTH STREAM BUFFER DETERMINATION

INSPECTION SEQUENCE NOTES 1. CONTRACTOR SHALL NOTIFY THE CARROLL COUNTY BUREAU OF PERMITS AND INSPECTIONS AT 410-386-2674, AT LEAST ONE (1) DAY

PRIOR TO BEGINNING ANY WORK.

- SITE COMPLIANCE INSPECTIONS ARE REQUIRED THE FOLLOWING STAGES DURING CONSTRUCTION.
- a. PROPOSED STRUCTURES STAKED OUT IN PROPER LOCATIONS AS SHOWN ON THESE APPROVED PLANS.
- b. PROPOSED FOUNDATIONS INSTALLED FOR ALL BUILDINGS SHOWN ON THESE APPROVED PLANS.
 c. SUB-GRADES ESTABLISHED FOR ALL DRIVES, PARKING LOTS, AND SURROUNDING GRADING.
- d. COMPLETION OF ALL DRIVES, PARKING LOTS, AND SURROUNDING GRADING.
- e. COMPLETION OF ALL WORK SHOWN ON THESE PLANS.

IT IS THE CONTRACTOR'S RESPONSIBILITY TO CONTACT THE CARROLL COUNTY BUREAU OF PERMITS AND INSPECTIONS AT (410)-386-2674 UPON COMPLETION OF EACH PHASE OF CONSTRUCTION.

- CONTRACTOR SHALL NOTIFY CARROLL COUNTY BUREAU OF RESOURCE MANAGEMENT, ENVIRONMENTAL INSPECTION SERVICES DIVISION AT (410)-386-2210 PRIOR TO BEGINNING ANY WORK. ALL FOREST CONSERVATION PLAN DEVICES MUST BE IN PLACE PRIOR TO ANY CONSTRUCTION.
- I. STREAM BUFFERS SHALL BE IDENTIFIED AT THE CONSTRUCTION SITE AND PROTECTED THROUGH THE INSTALLATION OF HIGHLY VISIBLE, WELL-ANCHORED FENCING (SHOULD DISTURBANCE BE PROPOSED IN THE VICINITY OF THE BUFFER) PRIOR TO ANY LAND CLEARING OR GRADING. SUITABLE FENCING MEASURES INCLUDE BLAZE-ORANGE, PLASTIC, MESH FENCING; TWO OR THREE-STRAND WIRE FENCE WITH HIGHLY VISIBLE FLAGS; OR SNOW FENCING WITH HIGHLY VISIBLE FLAGS ON ANCHOR POSTS. IF A FOREST CONSERVATION AREA, AS REQUIRED BY CHAPTER 150, FOREST CONSERVATION, OF THE CODE, COMPLETELY INCLUDES THE STREAM BUFFER AREA, THEN NO ADDITIONAL FENCING IS REQUIRED. PROTECTIVE FENCING SHALL BE INSTALLED AND INSPECTED BY THE COUNTY PRIOR TO THE ISSUANCE OF ANY GRADING PERMIT.


AFTER CONSTRUCTION HAS BEEN COMPLETED AND THE SITE IS STABILIZED, ALL STREAM BUFFER PROTECTIVE FENCING SHALL BE REMOVED FROM THE SITE FOR PROPER DISPOSAL; HOWEVER, SIGNS SHALL REMAIN IN PLACE AFTER CONSTRUCTION HAS BEEN COMPLETED.


THE DEVELOPER SHALL PROVIDE PERMANENT SIGNS TO IDENTIFY THE WATER RESOURCE PROTECTION EASEMENT AREA. THESE SIGNS SHALL BE INSTALLED AT 100 FEET INTERVALS AROUND THE PERIMETER OF THE EASEMENT. SIGNS SHALL BE CONSTRUCTED OF NON-BIODEGRADABLE MATERIALS AND AFFIXED TO POSTS OF LASTING MATERIALS (E.G., OAK OR METAL STAKES). POSTS SHALL BE FOUR FEET ABOVE GROUND AND TWO FEET BELOW GROUND.


ALL SIGNS MUST BE INSTALLED AT THE TIME OF DEED OF EASEMENT RECORDATION.

4. THE CONTRACTOR SHALL NOT PROCEED TO NEXT PHASE OF CONSTRUCTION UNTIL GIVEN APPROVAL OF PRIOR PHASES.

			CAI	RROLL COUNTY S	GIGNATURE BLOCKS		
		CARROLL COUNT	TY PLANNI	ING AND ZONING COMMISSION			
		BY:			DATE:		
		CARROLL COUN	TY HEALTI	H DEPARTMENT			
		BY:			DATE:		
					RAGE SYSTEMS ARE IN CONFORMANCE		
		CARROLL COUN	CARROLL COUNTY SOIL CONSERVATION DISTRICT				
YOU DIG CALL 0-257-7777 OURSELF, GIVE NG DAYS NOTICE		THIS PLAN IS AP CONSERVATION			NT CONTROL BY THE CARROLL SOIL		
OMPONENTS FOR ETY. ALL CONSTRUCTION DOMPLIANCE WITH THE ETY AND HEALTH ACT OF ES AND REGULATIONS APPURTENANT.		BY:			DATE:		
O CALL MISS UTILITY TO G UTILITIES MARKED 48 ANY CONSTRUCTION.		(COUNTY HEALTH DEPARTMENT COUNTY HEALTH DEPARTMENT DATE: TY WATER SUPPLY AND/ OR COMMUNITY SEWERAGE SYSTEMS ARE IN CONFORMANCE CARROLL COUNTY MASTER PLAN. COUNTY SOIL CONSERVATION DISTRICT IS APPROVED FOR SOIL EROSION AND SEDIMENT CONTROL BY THE CARROLL SOIL TION DISTRICT. DATE: CITY OF WESTMINSTER SIGNATURE BLOCKS VESTMINSTER, DIRECTOR OF PUBLIC WORKS D: DATE: DATE: DATE: CITY OF WESTMINSTER SIGNATURE BLOCKS VESTMINSTER, DIRECTOR OF PUBLIC WORKS D: DATE: D				
		CITY OF WEST	/INSTER,	, DIRECTOR OF PUBLIC WORK	S		
		APPROVED:			DATE:		
		11/14/24					
EERS CERT	9/23/24 ADDRESS COUNTY SWM & WRM (
		6/6/24					
	issociated computations were prepared plicable standards and regulations of	4/12/24		ADDRESS (COUNTY COMMENTS		
	the Owner/Developer.	DATE			REVISION	BY	
	DATE		Ρ				
EXF	PDATE:						
	DATE		•				
	OWNER / DEVELOPER	Surveyed B	у				
has been		Computed E	ly				
h this work		BPR	•	BPR			
understand oproved by		Date:		FEBRUARY 22, 2024			
rk is made.	PENGUIN RANDOM HOUSE LLC	Sheet:		1 OF 9	SURVEYORS - LAND PLANNERS		
	C/O RYNE BARRALL 400 BENNETT CERF DRIVE	Scale:		1" = 150'			
	WESTMINSTER, MD 21157 410-386-7725	BPR Drawing No.:		22-0614	PHONE: (410)-857-9030		
		сс	FILE #	: S-24-0005	FAX: (410)-876-1532		

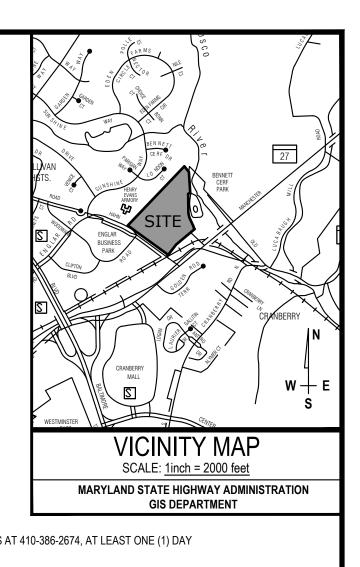

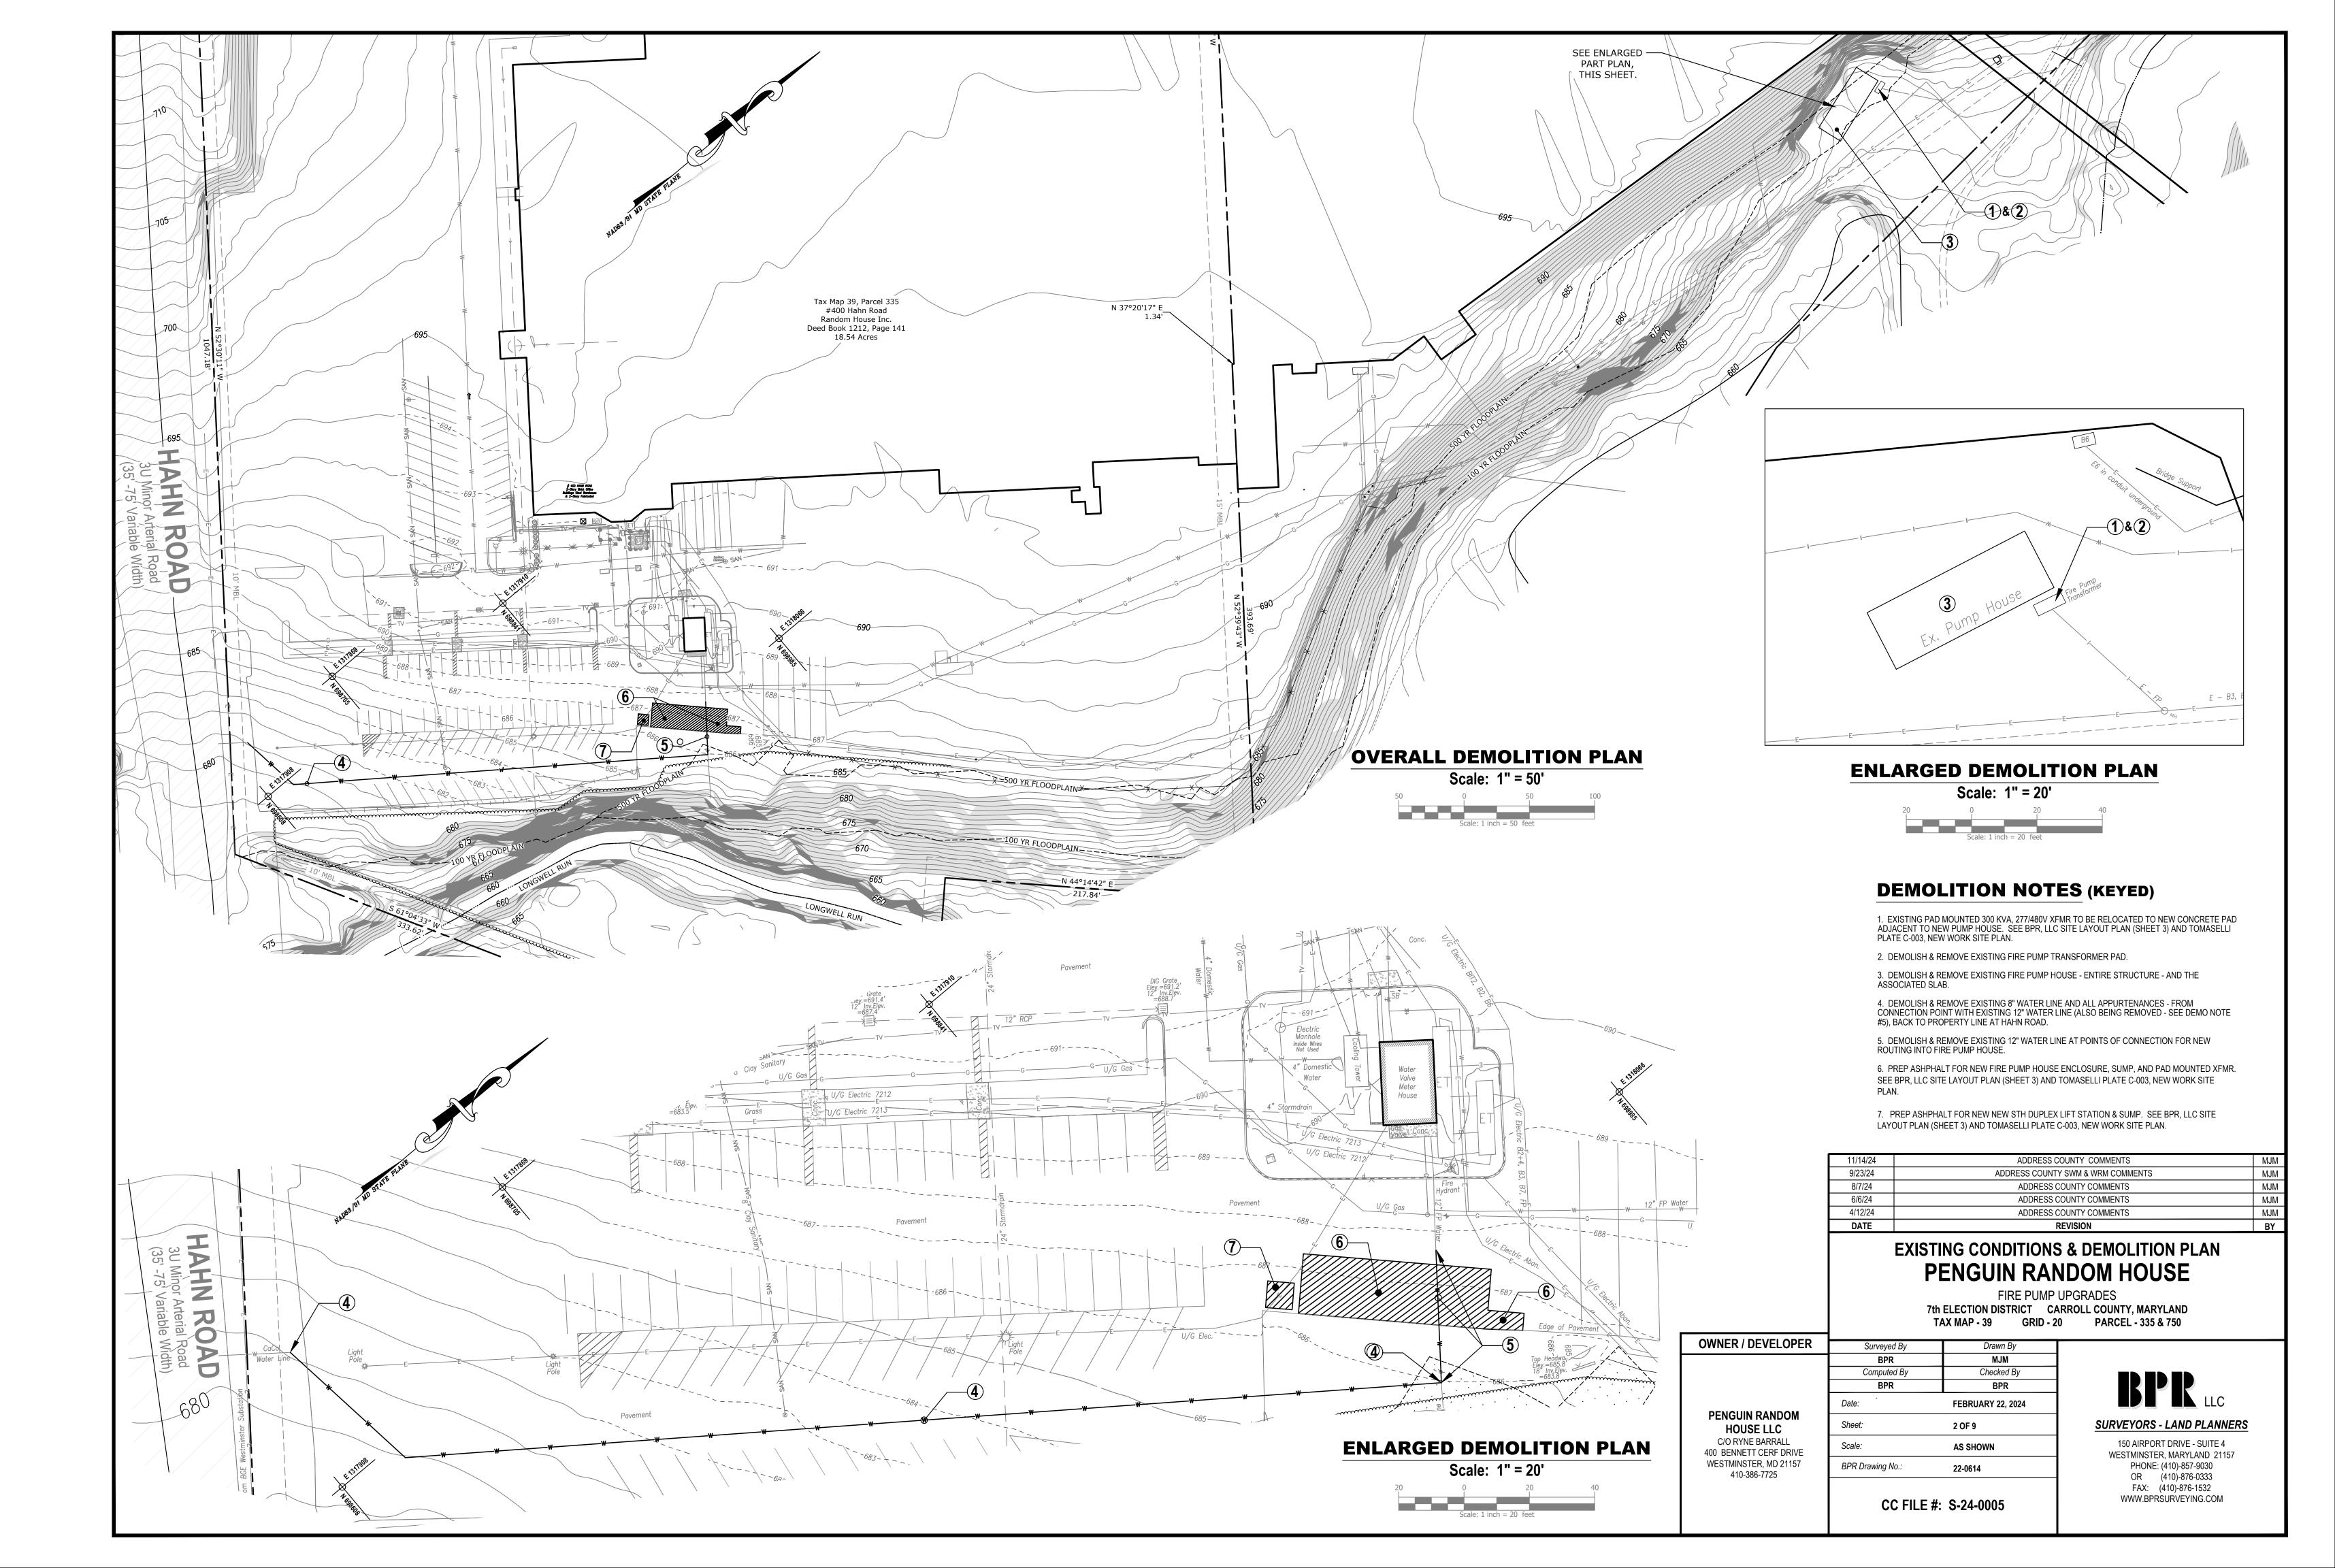

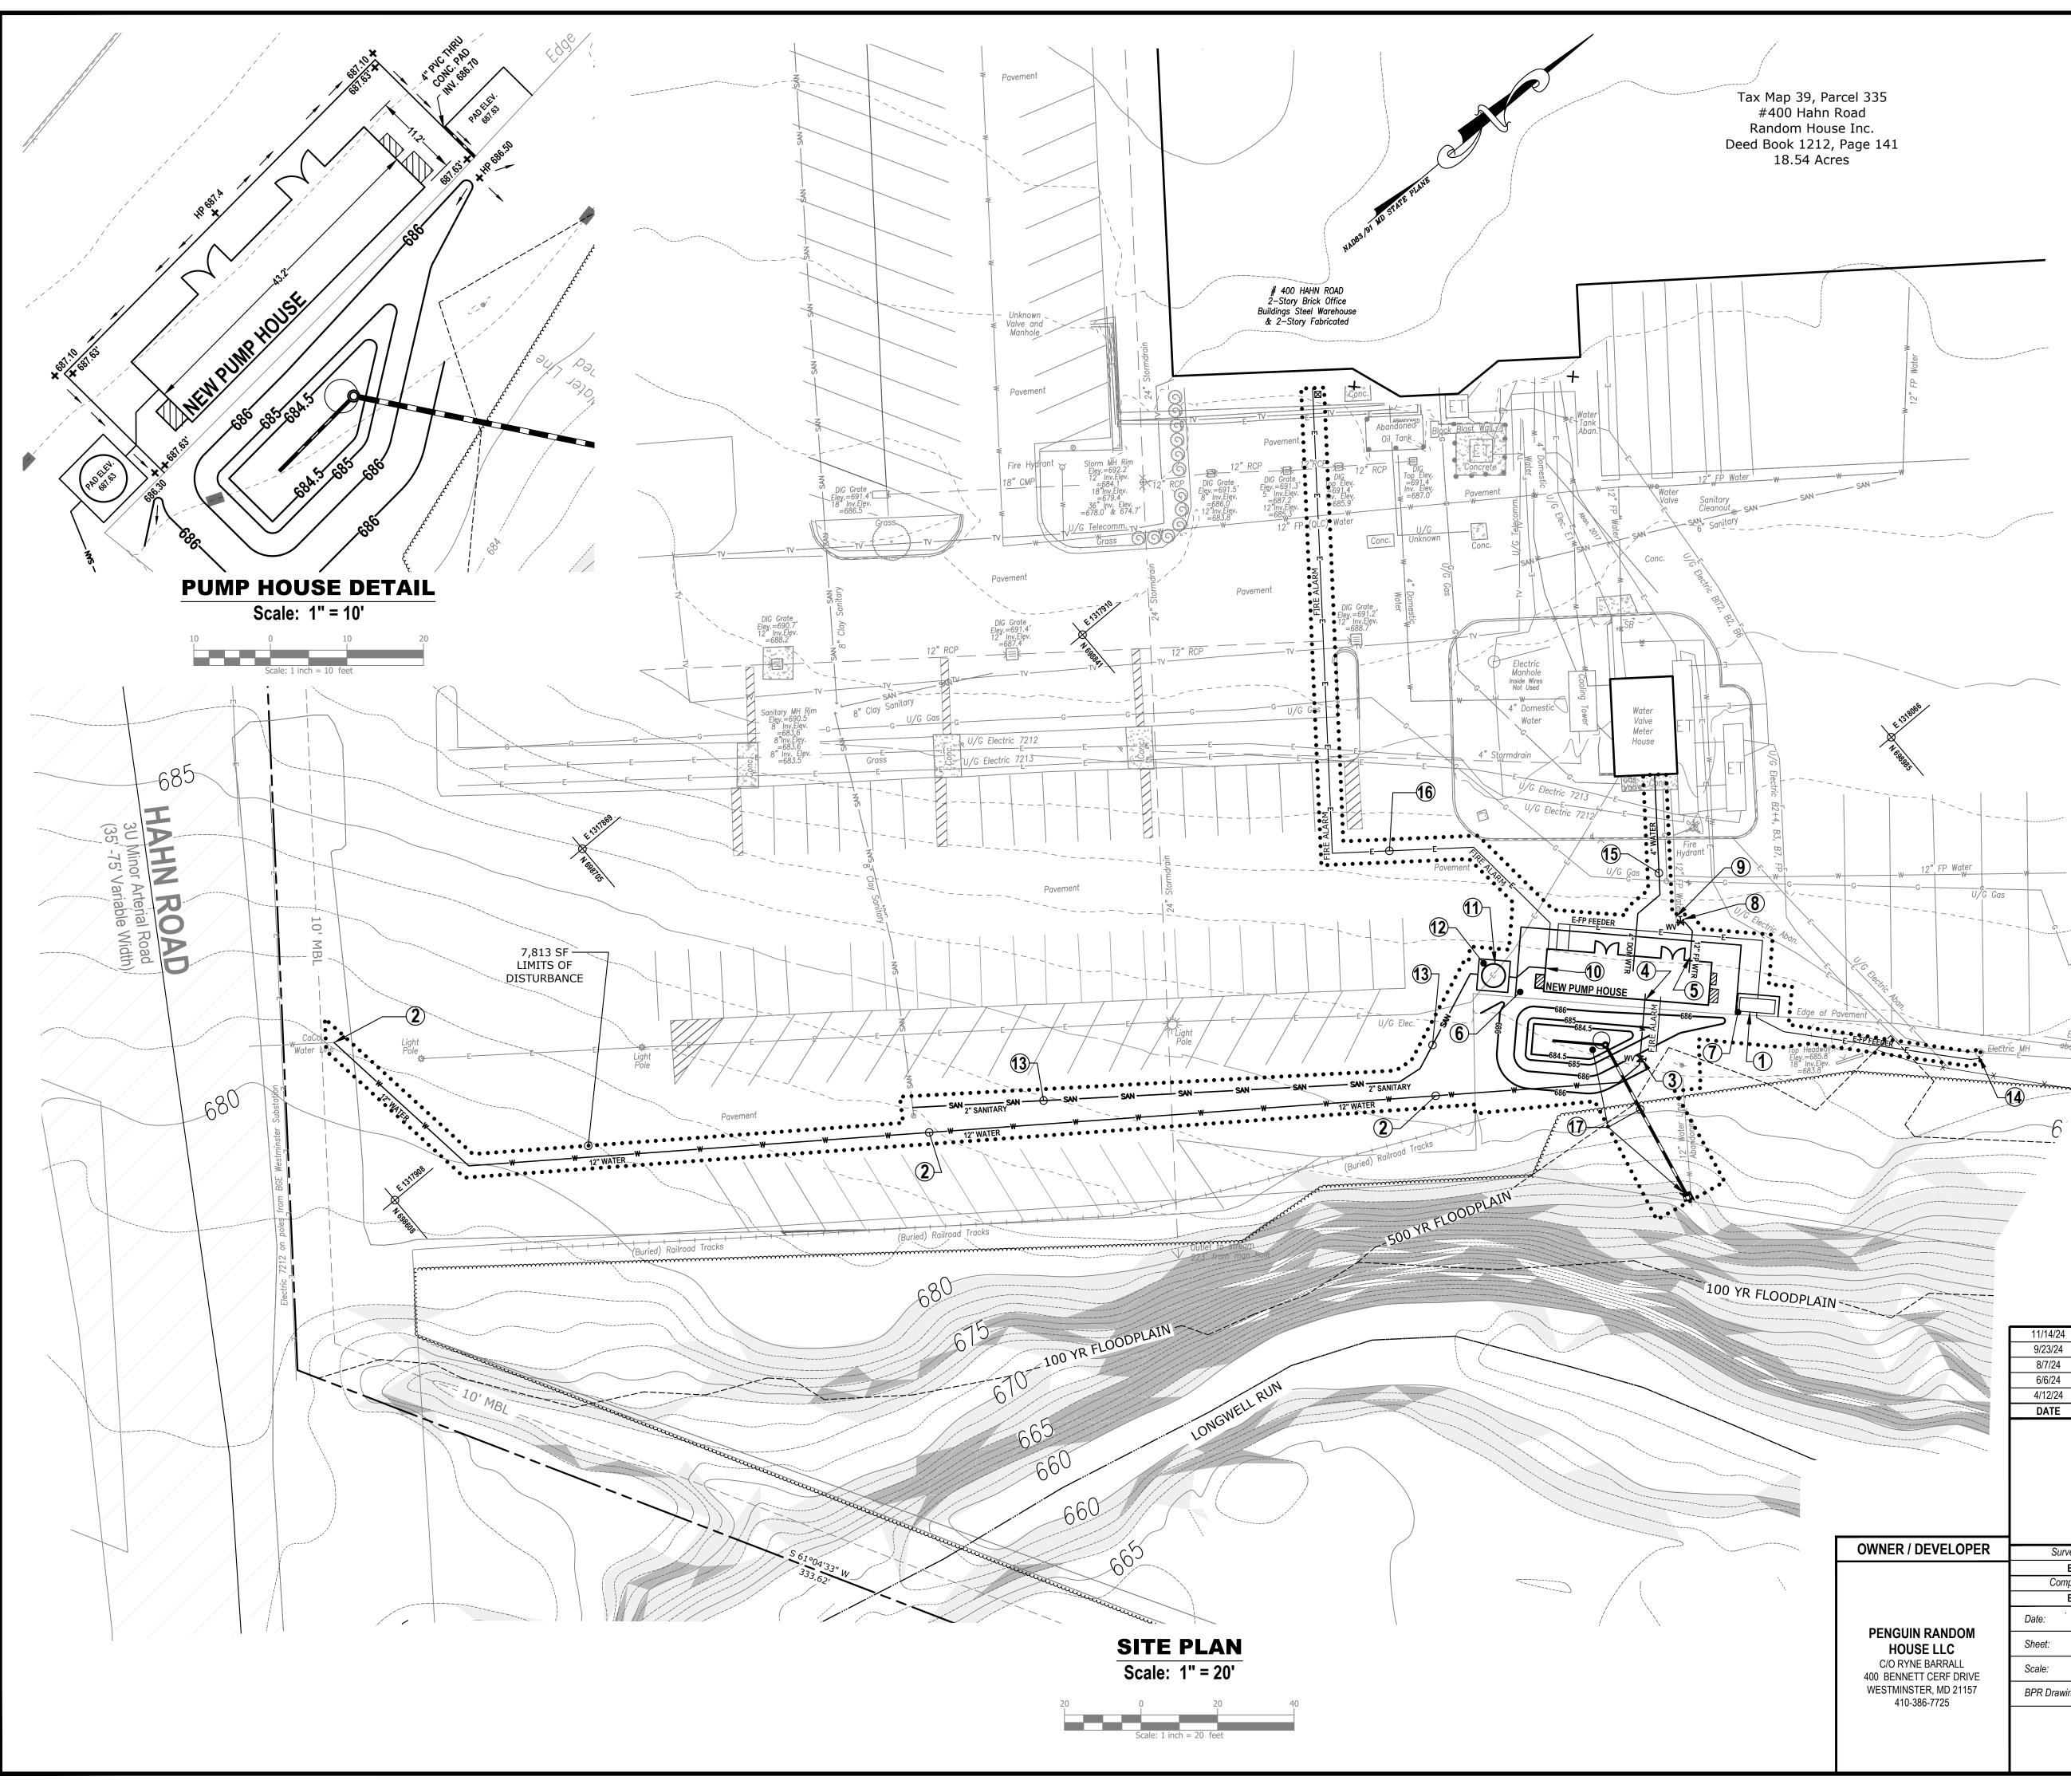

GENERAL NOTES

THE LIMITS OF DISTURBANCE AND THE PAVEMENT SAWCUT/EDGE OF PAVEMENT LINES ARE THE SAME; HOWEVER, FOR GRAPHICAL CLARITY, THE LIMITS OF DISTURBANCE LINE IS SHOWN OFFSET FROM THE PAVEMENT LINE. -NEW PUMP HOUSE CONSTRUCTION

APPROX. 7,873 SF LOD APPROX. 1,262 SF LOD 9,075 SF LOD

**THE LIMITS OF DISTURBANCE LINE IS OFFSET FROM THE ACTUAL LOD FOR GRAPHICAL CLARITY.

- PIPE MAY BE INSTALLED BY TRENCHLESS EXCAVATION USING DIRECTIONAL DRILLING OR TRENCHING EXCEPT WHERE NOTED.
- THE UTILITY WORK SHOWN WITHIN THE LIMITS OF DISTURBANCE SHALL BE CONSTRUCTED IN ACCORDANCE WITH CARROLL COUNTY'S STANDARDS & SPECIFICATIONS. EXISTING ITEMS THAT MUST BE DISTURBED OR REMOVED AS A RESULT OF THE CONTRACTOR'S NORMAL OPERATIONS, INCLUDING CONCRETE OR BRICK SIDEWALK, CURBING, ROADWAY PAVEMENT, ETC, SHOULD BE RESET OR REPLACED IN-KIND AND INSTALLED BACK TO THE EXISTING LINE & GRADE, OR AS DIRECTED BY THE COUNTY INSPECTOR IN THE FIELD.
- 4. THE EDGES OF ASPHALT PAVEMENT SHALL HAVE A BITUMINOUS SEALANT.
- 5. SANITARY SEWER SHALL HAVE A MINIMUM SLOPE OF 1.0%.

-OLD PUMP HOUSE DEMOLITION

6. COORDINATE SANITARY SEWER CONNECTION WITH PUMP HOUSE MANUFACTURER.

CONSTRUCTION NOTES (KEYED)

1. RELOCATED 300 KVA, 277/480V XFMR FIRE PUMP TRANSFORMER.

2. INSTALL NEW 12" CEMENT LINED DUCTILE IRON UNDERGROUND (AWWA C104) OR AWWA C900 PVC.

3. INSTALL NEW 12" POST INDICATOR VALVE WITH INTEGRAL TAMPER SWITCH.

4. INSTALL NEW 12" CEMENT LINED DUCTILE IRON (AWWA C104) OR AWWA C900 PVC INTO NEW FIRE PUMP HOUSE. COORDINATE WITH FIRE PUMP VENDOR FOR EXACT LOCATION OF INCOMING AND INSTALLATION REQUIREMENTS.

5. INSTALL NEW 12" AWWA C900 PVC FROM FIRE PUMP'S DISCHARGE MANIFOLD. COORDINATE WITH FIRE PUMP VENDOR FOR EXACT LOCATION OF DISCHARGE PIPING AND INSTALLATION REQUIREMENTS.

- 6. PROVIDE NEW ±18'-0" x 56'-7" CONCRETE PAD FOR NEW FIRE PUMP ENCLOSURE.
- 7. PROVIDE NEW 5' x 11' CONCRETE PAD FOR NEW FIRE PUMP TRANSFORMER.
- 8. NEW 12" UNDERGROUND GATE VALVE WITH EXTENSION STEM & ROADWAY BOX.
- 9. CONNECT TO EXISTING 12" UNDERGROUND.

10. INSTALL NEW 4" FROM PUMP HOUSE FLOOR DRAIN TO STH PREFABRICATED DUPLEX LIFT STATION. COORDINATE WITH STH FOR EXACT REQUIREMENTS.

11. PROVIDE NEW STH PREFABRICATED FIBERGLASS DUPLEX LIFT STATION, DUPLEX SUMP, NEMA 4X SUMP CONTROLLER, AND ALL REQUIRED APPURTENANCES. COORDINATE POWER WITH STH.

12. PROVIDE NEW 8'-2" X 8'-2" CONCRETE PAD FOR LIFT STATION.

13. INSTALL NEW 2" SANITARY PIPE FROM SUMP & CONNECT TO EXISTING 8" SANITARY MAIN.


14. INTERCEPT & REEED EXISTING "E-FP" FEEDER FROM MANHOLE TO FIRE PUMP ENCLOSURE & TRANSFORMER AS NEEDED.


15. PROVIDE NEW 4" DOMESTIC WATER PIPE. TRANSITION UNDERGROUND PVC/POLYETHYLENE TO NEW TYPE K COPPER AND CONNECT TO EXISTING. PROVIDE NEW 4" SHUTOFF VALVE.

16. NEW FIRE ALARM CONDUIT FROM MAIN FACP IN BLDG #1 AND TO POST INDICATOR VALVE'S TAMPER SWITCH. COORDINATE WITH PRH & FIRE ALARM CONTRACTOR FOR EXACT LOCATION & SIZE. INSTALL NEW TRANSIENT VOLTAGE SURGE SUPPRESSION.

17. NEW SWM MICRO BIORETENTION ESD MEASURE (STD. M-6), PIPING & OUTFALL. SEE SWM GRADING PLAN & ESD MAPPING, NOTES & DETAILS - SHEET 5 OF 6.


ODPLAIN					
		11/14/24	ADDRESS (OUNTY COMMENTS	MJM
		9/23/24	ADDRESS COUNT	Y SWM & WRM COMMENTS	MJM
		8/7/24	ADDRESS (COUNTY COMMENTS	MJM
		6/6/24	ADDRESS (COUNTY COMMENTS	MJM
		4/12/24	ADDRESS (COUNTY COMMENTS	MJM
		DATE		REVISION	BY
				UPGRADES ARROLL COUNTY, MARYLAND 0 PARCEL - 335 & 750	
	OWNER / DEVELOPER	Surveyed By	Drawn By		
		BPR	MJM		
λ.		Computed By	Checked By		
		BPR	BPR		
		Date:	FEBRUARY 22, 2024	BPR LLC	
	PENGUIN RANDOM HOUSE LLC	Sheet:	3 OF 9	SURVEYORS - LAND PLANNERS	
	C/O RYNE BARRALL 400 BENNETT CERF DRIVE	Scale:	1" = 20'	150 AIRPORT DRIVE - SUITE 4 WESTMINSTER, MARYLAND 21157	
	WESTMINSTER, MD 21157 410-386-7725	BPR Drawing No.:	22-0614	PHONE: (410)-857-9030	
		CC FILE #	: S-24-0005	OR (410)-876-0333 FAX: (410)-876-1532 WWW.BPRSURVEYING.COM	

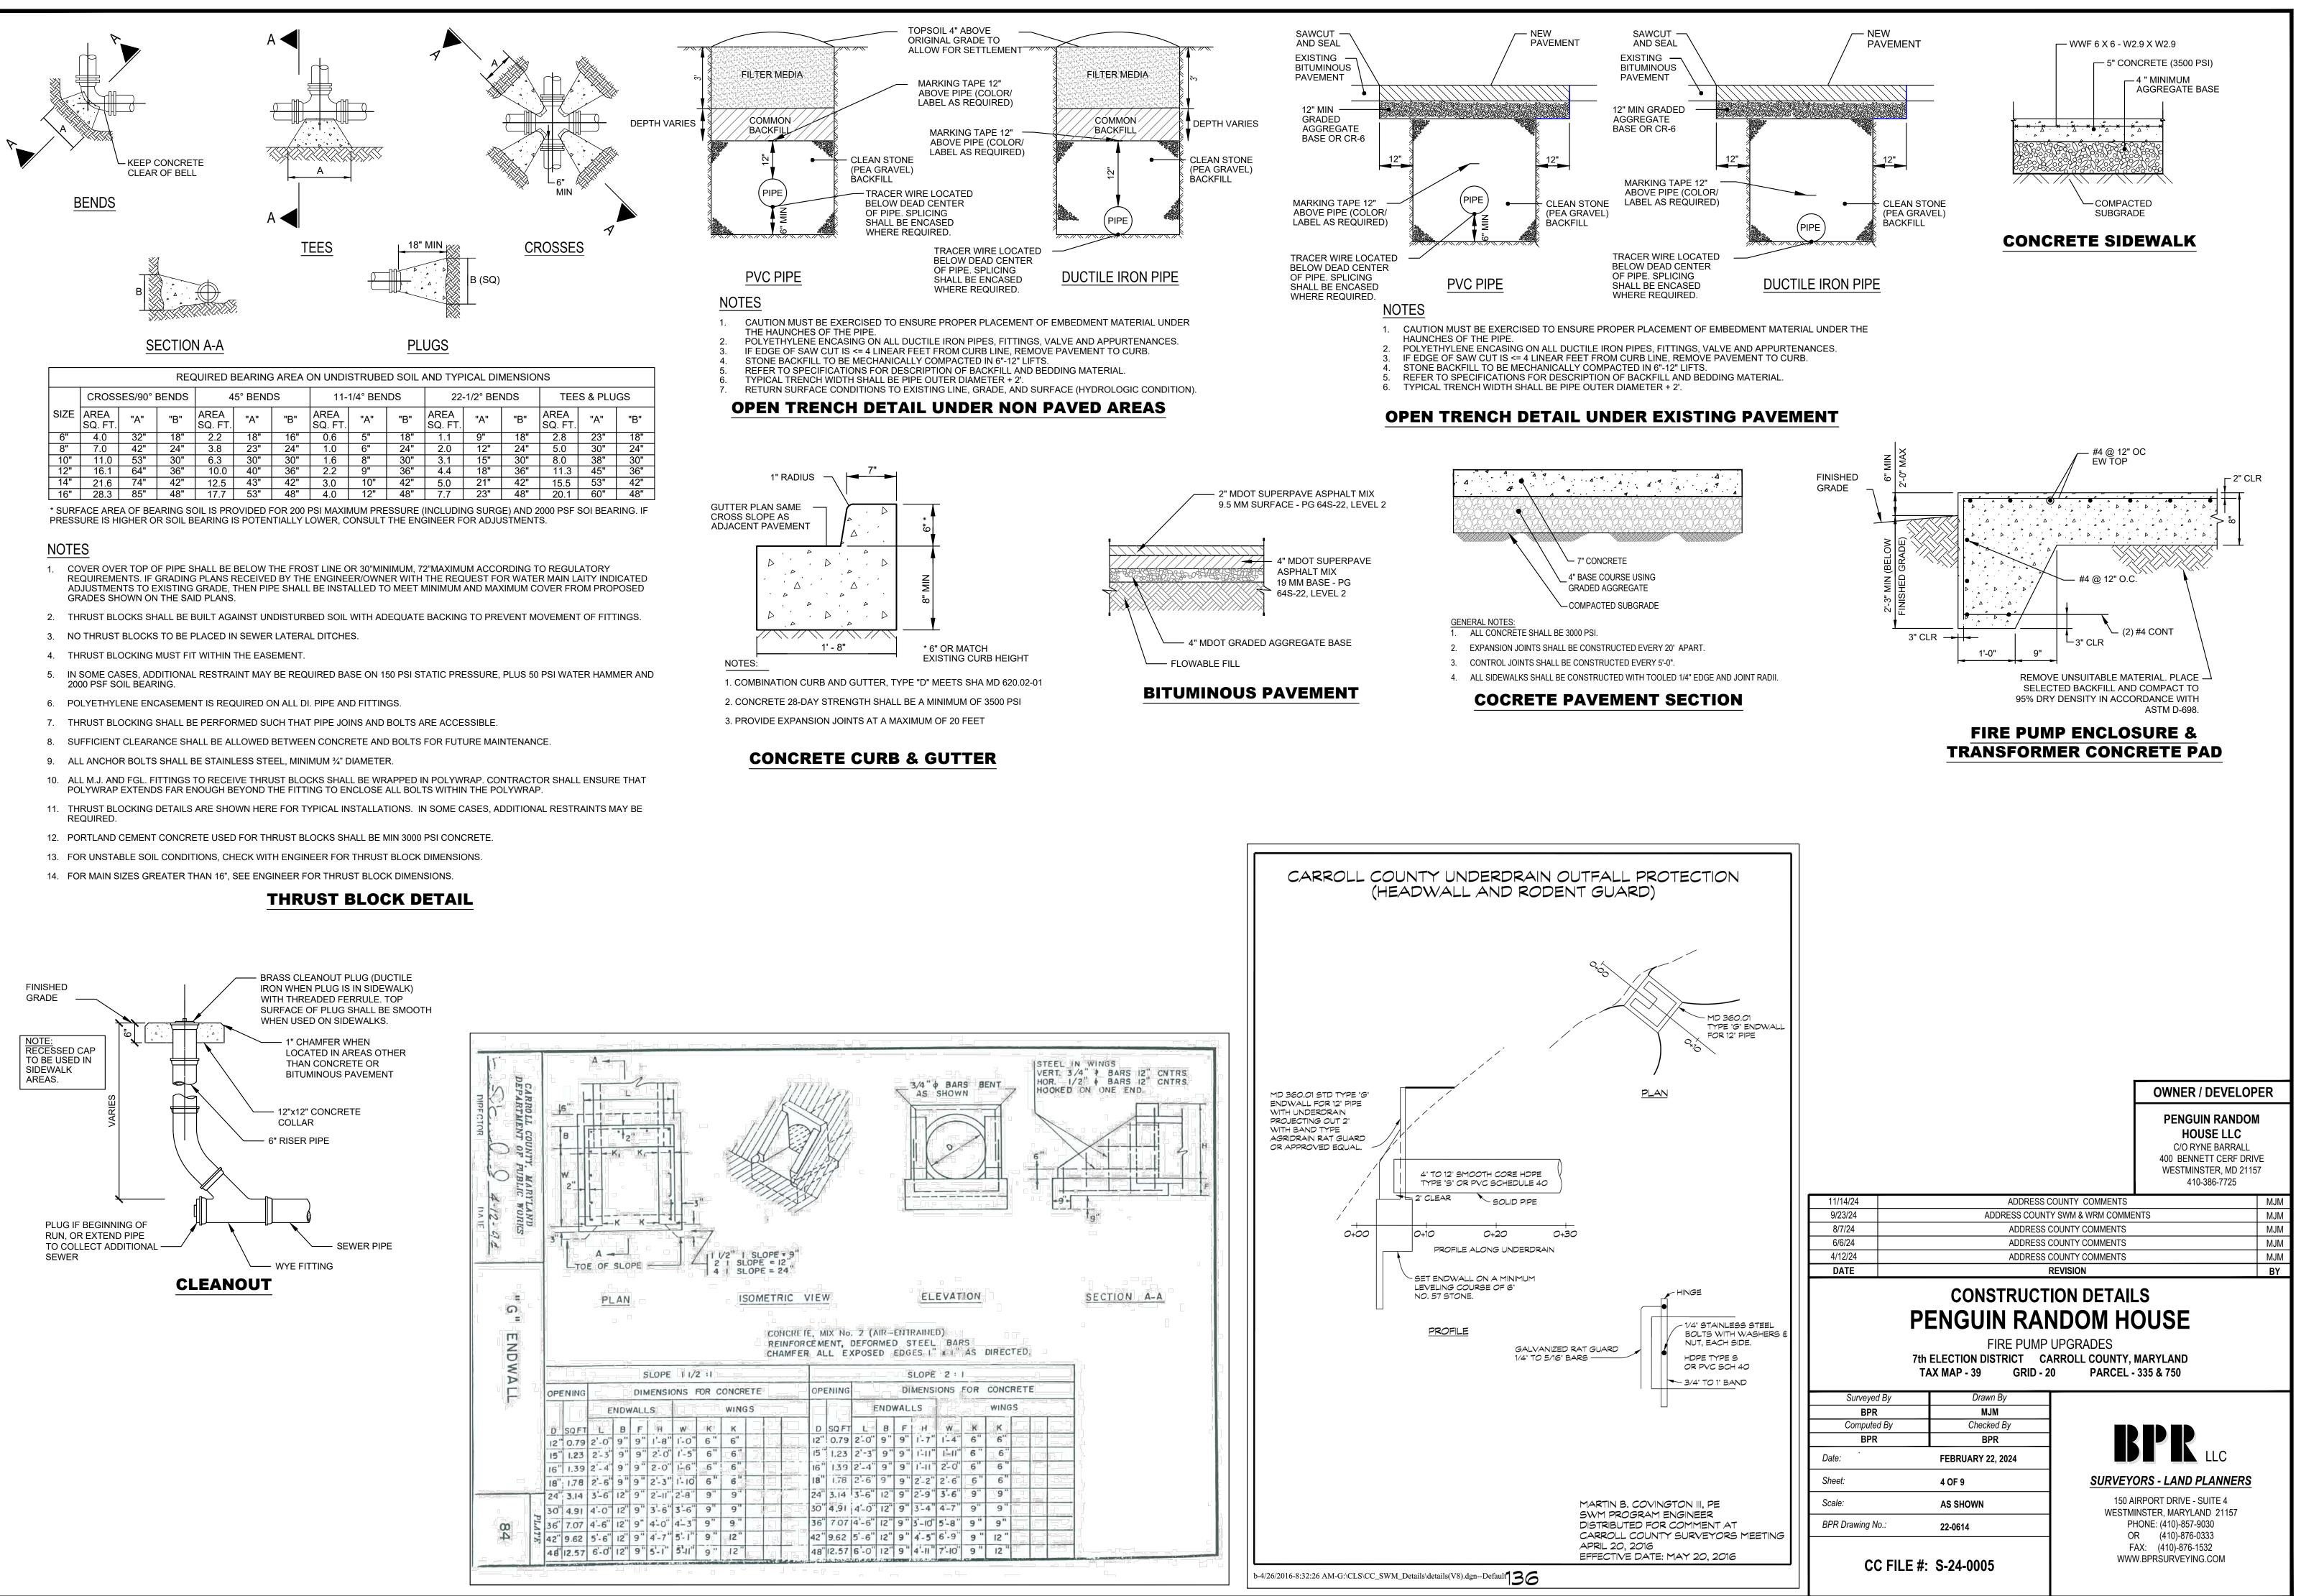

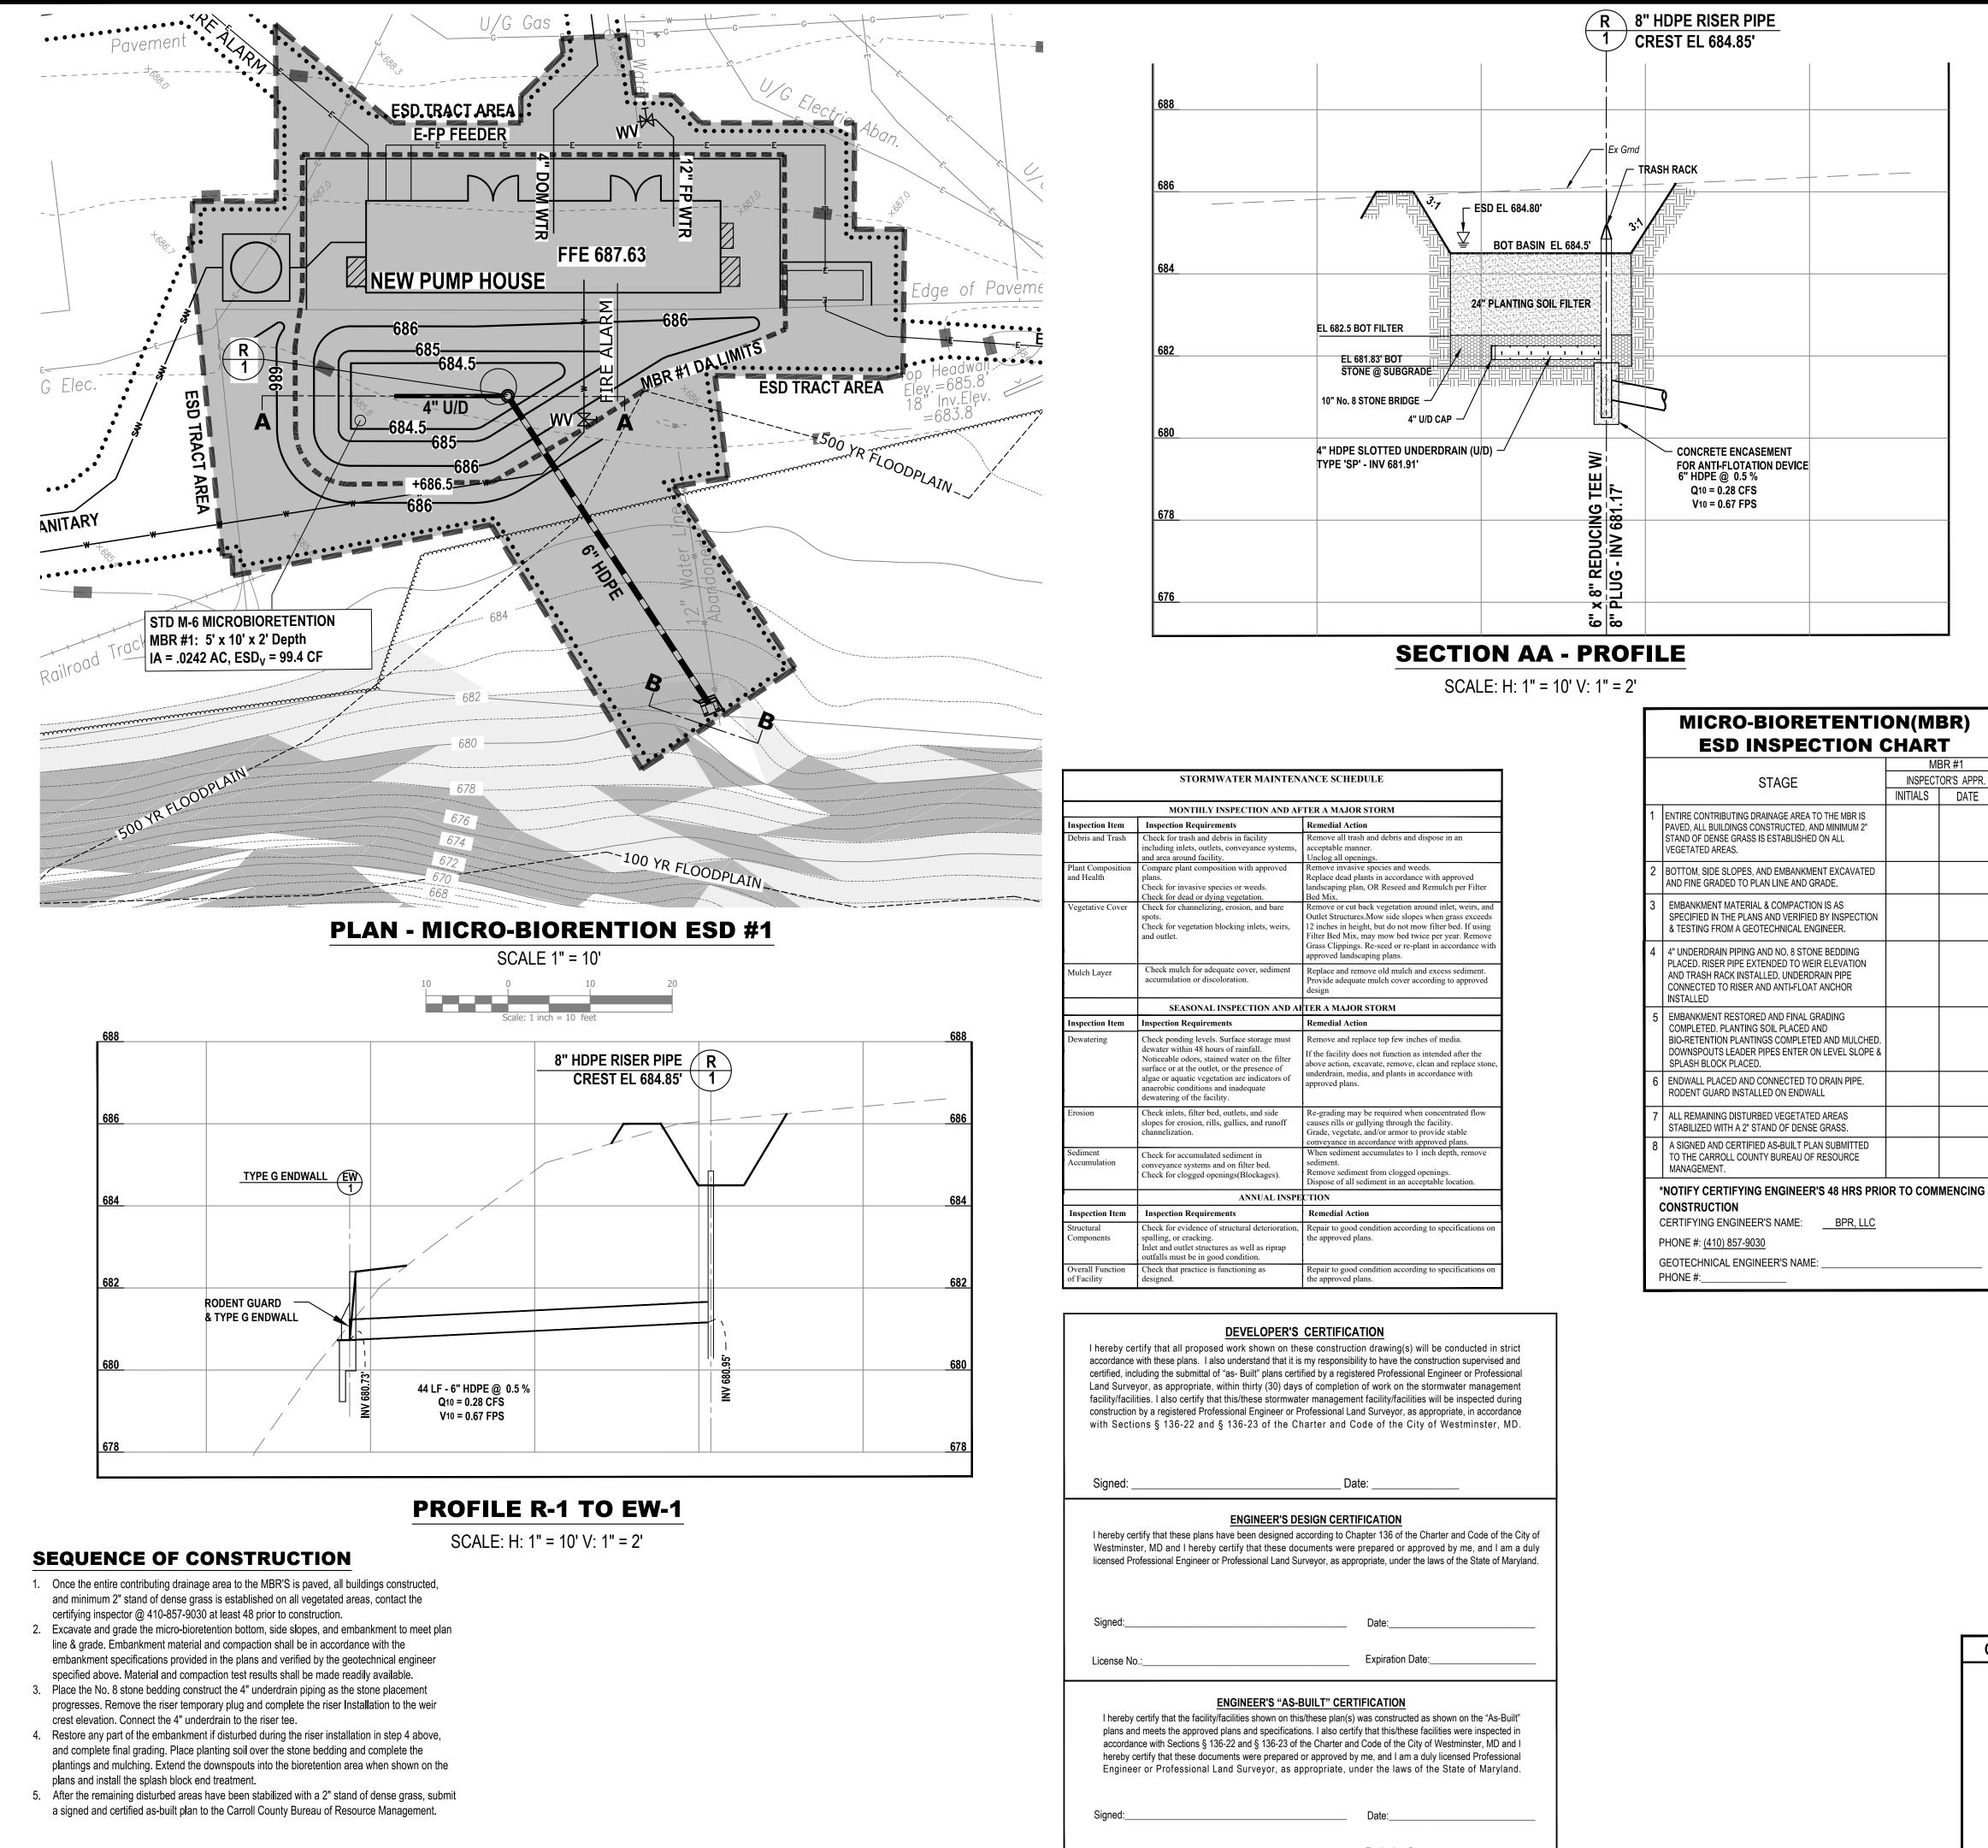

License No.:

Expiration Date:

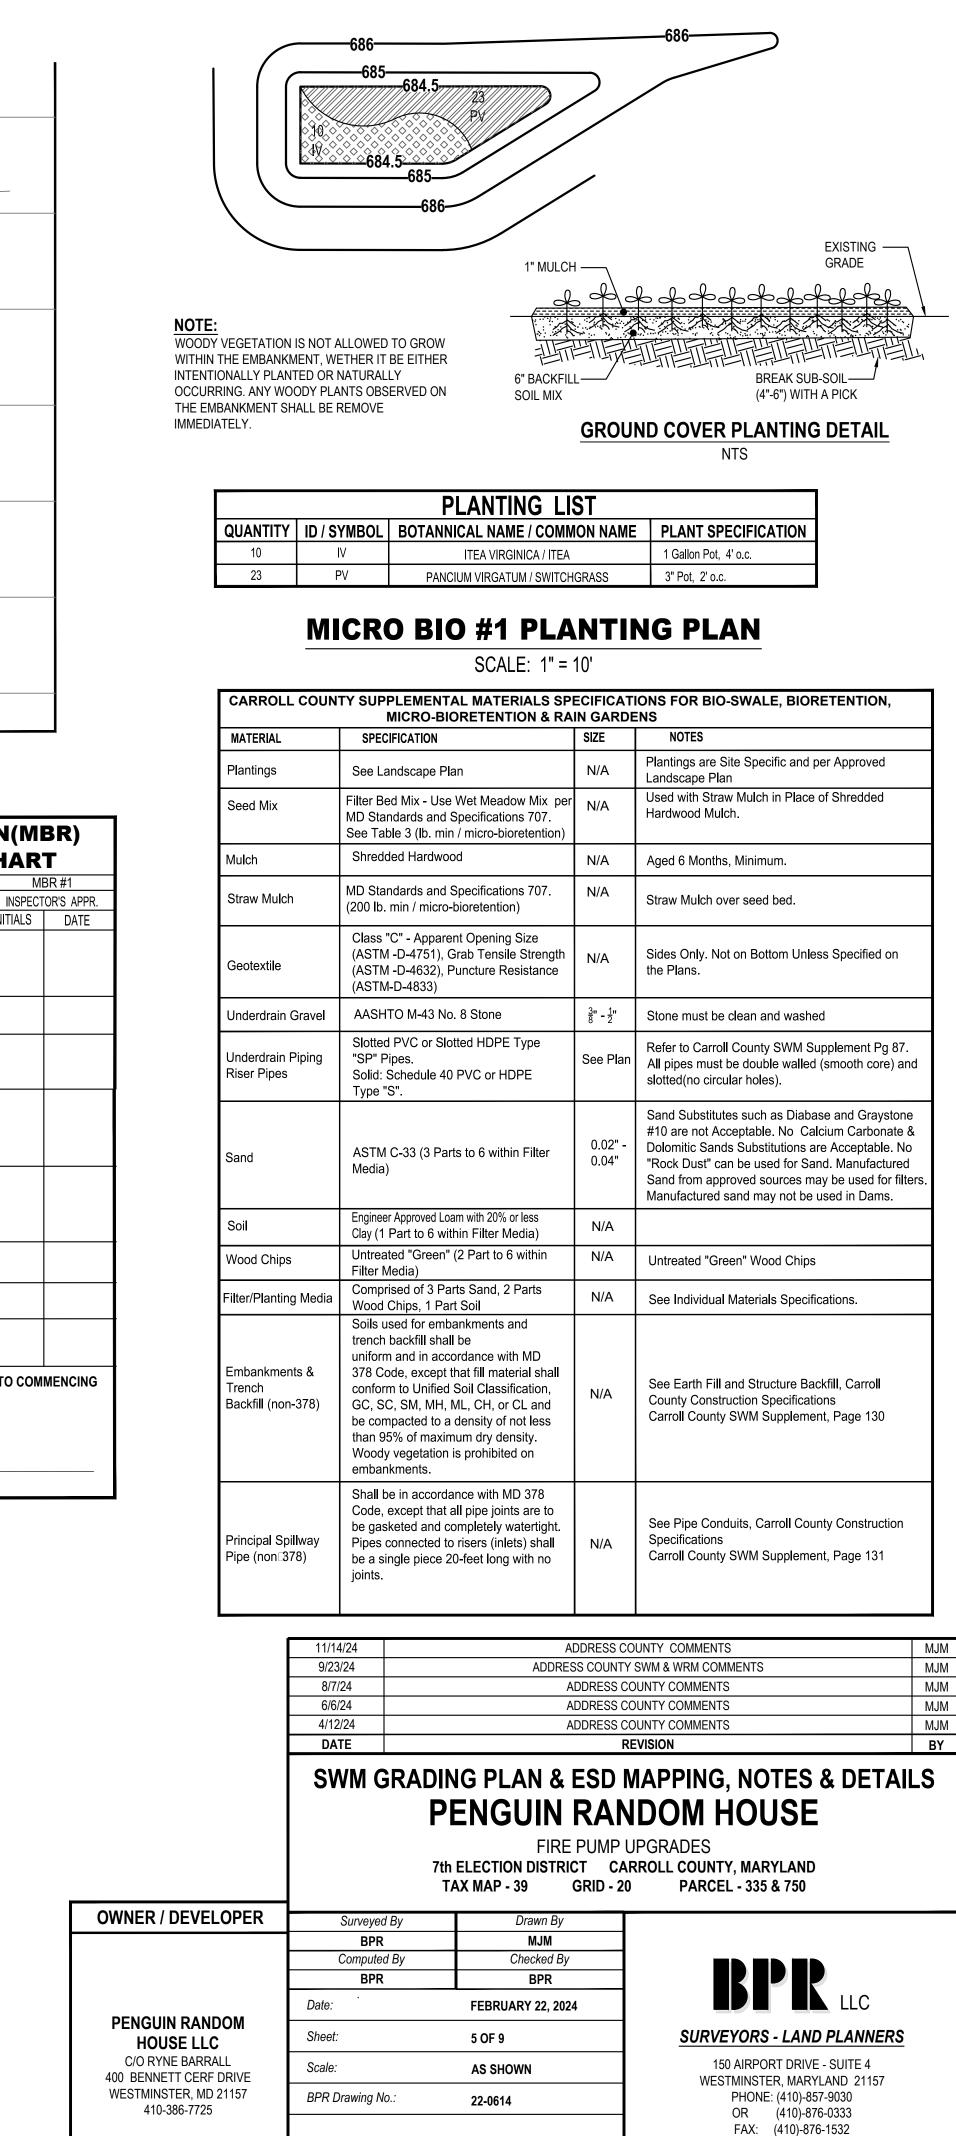

INITIALS DATE

CC FILE #: S-24-0005

WWW.BPRSURVEYING.COM

MONTHLY INSPECTION							
Inspection Item	Inspection Requirements	Remedial Action					
Vegetative Cover and Erosion	Check for vegetation over 4" in height. Check the Soil Restoration area for channelizing and bare spots.	Mow grass/remove trees and shrubs. re-grade if the concentrated flow is causing rills or gullying on the surface. re-seed as necessary.					
!	SEASONAL INSPECTION AND AFTE	R A MAJOR STORM					
Inspection Item	Inspection Requirements	Remedial Action					
Inflow	Ensure sheet flow from pavement to grass area.	Remove debris and vegetation, regrade and re-seed as necessary to ensure sheet floe from pavement.					
Dewatering	Check for soft areas and/or soil saturated to the surface.	If necessary, excavate, remove, and replace the soil and re-seed.					
	ANNUAL INSPECTIO	DN					
Inspection Item	Inspection Requirements	Remedial Action					
Overall Function	Check that grass areas remain and have not been compacted or paved.	Repair to good condition according to specifications on the approved plans.					

	PAVEMENT REMO		
	STAGE		BR #1 'OR'S APPR. DATE
1	PAVEMENT AND GRAVEL BASE REMOVED AND DISPOSED OF OFFSITE, MINIMUM 6"		
2	SUBSOIL BROKEN UP TO 20" IN DEPTH. TILL OR MIX IN 10" MINIMUM TOPSOIL BUT AS MUCH AS NECESSARY TO BRING THE SURFACE TO 4" ABOVE ORIGINAL GRADE.		
3	SOIL RESTORED AND FINAL GRADING COMPLETED. PLANTING SOIL PLACED AND SEEDED AND MULCHED.		
4	A SIGNED AND CERTIFIED AS-BUILT PLAN SUBMITTED TO THE CARROLL COUNTY BUREAU OF RESOURCE MANAGEMENT.		
C	NOTIFY CERTIFYING ENGINEER'S 48 HRS PRIC CONSTRUCTION CERTIFYING ENGINEER'S NAME: <u>BPR, LLC</u>	OR TO COM	MENCING
F	PHONE #: (410) 857-9030		
	GEOTECHNICAL ENGINEER'S NAME: PHONE #:		


UTILITY TRENCHING INSPECTION **CHART - PAVED AREAS**

	STAGE	INSPECT	OR'S APPR.
		INITIALS	DATE
1	EXISTING BITUMINOUS PAVING SAWCUT 12" BEYOND EDGE OF TRENCH IN PAVED AREAS.		
2	TRENCH EXCAVATED TO A WIDTH OF PIPE OUTER DIAMETER +2'.		
3	PVC PIPE INSTALLED ON MINIMUM 6" CLEAN STONE BACKFILL. DUCTILE IRON PIPE INSTALLED ON TRENCH SUBGRADE. TRACER WIRE LOCATED BELOW DEAD CENTER OF PIPE. SPLICING SHALL BE ENCASED WHERE REQUIRED		
4	TRENCH BACKFILLED WITH CLEAN STONE BACKFILL. MARKING TAPE PLACED 12" ABOVE PIPE.		
5	UTILITY TRENCHING RETURNED TO EXISTING LINE & GRADE.		
6	A SIGNED AND CERTIFIED AS-BUILT PLAN SUBMITTED TO THE CARROLL COUNTY BUREAU OF RESOURCE MANAGEMENT.		
0 () () ()	NOTIFY CERTIFYING ENGINEER'S 48 HRS PRIC CONSTRUCTION CERTIFYING ENGINEER'S NAME:BPR, LLC HONE #: (410) 857-9030 GEOTECHNICAL ENGINEER'S NAME: HONE #:	OR TO COM	MENCING

THE

UTILITY TRENCHING INSPECTION **CHART - UNPAVED AREAS**

	TOR'S APPR.
ALS	DATE
СОМ	
	>OM

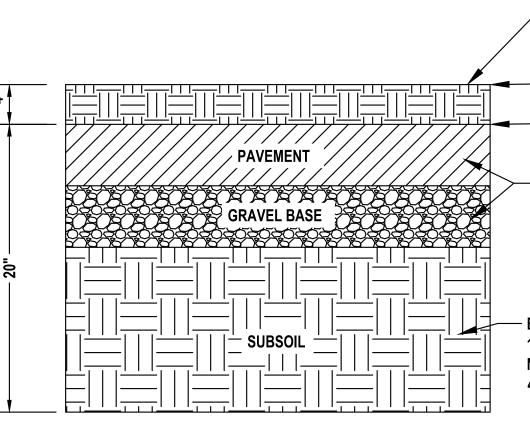




Heavy Duty Bar Guards 糝

Keeps out the big chunks.

- Provides maximum flow rates.
- Allows small trash to pass.
- An excellent choice in any situation where a low-profile, high-capacity intake is required.
 Constructed of ¹/₄" rod on 4" and 6", ⁵/₁₆" rod on 8",
- ³/₈" rod on 10", and ¹/₂" rod on 12" through 36".
- Available in durable black or yellow powder coat finish for years of service. Please specify color when ordering.

All intakes require periodic maintenance.

Size	Bar Diameter	Number Of Bars	
4"	1/4"	6	
6"	¹ /4"	8	
8"	⁵ / ₁₆ "	9	
	8" B	AR GUAR	D

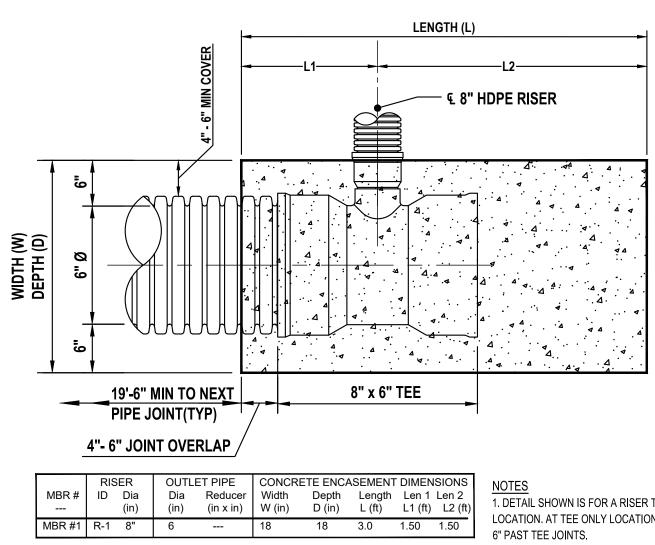

- 2" DENSE GRASS ESTABLISHED


- GRADE AT END OF CONSTRUCTION

- EXISTING GRADE

- REMOVE AND DISPOSE OF OFFSITE, MIN 6"

- BREAK UP TO 20" DEPTH. TILL OR MIX IN 10" MINIMUM TOPSOIL BUT AS MUCH AS NECESSARY TO BRING THE SURFACE TO 4" ABOVE ORIGINAL GRADE

PAVEMENT REMOVAL "URBAN SOIL RESTORATION" DETAIL EXISTING FIRE PUMP HOUSE NTS

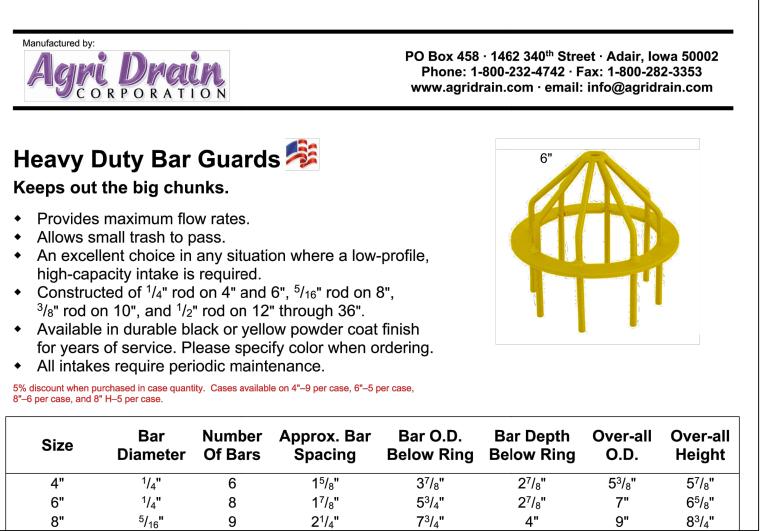

D FOR MICRO-BIORETENTION RISER PIPE R-1

1. DETAIL SHOWN IS FOR A RISER TEE W/ REDUCER TYPICAL LOCATION. AT TEE ONLY LOCATIONS, CONCRETE SHALL EXTEND 4" -2. FITTING DIMENSIONS ARE FROM "ADVANCED DRAINAGE SYSTEMS", AND ARE FOR THE PURPOSES OF ESTIMATING CONRETE ENCASEMENT SIZE ONLY. ACTUAL DIMENSIONS MAY VARY SLIGHTLY. 3. MINIMUM PIPE LENGTH TO NEXT JOINT FROM EITHER SIDE OF FITTING JOINTS IS 20'-0".

CONCRETE ENCASEMENT FOR ANTI-FLOATATION DETAIL (@8" HDPE RISER FOR MICROBIORETENTION #1) NTS

STORMWATER FACILITY DATA TA	ABLE
OWNED & MAINTAINED BY STRUCTURE CLASSIFICATION WATERSHED RECEIVING STREAM CLASSIFICATION TOTAL AREA OF LOTS DISTURBED AREA	Property Owners Non-Structural ESD's: M-6 #02130907 Liberty Reservo Use I-P 33.13 ac. 0.1291 ac.
ESD PRACTICE	M-6 MICRO-BIORETENTIC
CENTROID COORDS	N 560477 E 1382615
DRAINAGE AREA	0.0420 ac
IMPERVIOUS AREA	0.0242 ac.
PE DEPTH (REQ'D / PROV'D)	2.0" / 2.3"
ESDv (REQ'D / PROV'D)	55.9 cf / 82.8 cf

ir	
ΟN	


	11/14/24	ADDRESS CO	DUNTY COMMENTS	MJM
	9/23/24	ADDRESS COUNTY	SWM & WRM COMMENTS	MJM
	6/6/24		OUNTY COMMENTS	MJM
	4/12/24		OUNTY COMMENTS	MJM
	DATE	R	EVISION	BY
	P 7t	ENGUIN RAN	RROLL COUNTY, MARYLAND	
OWNER / DEVELOPER	Surveyed By	Drawn By		
	BPR	MJM		
	Computed By	Checked By		
	BPR	BPR	BPR LLC	
	Date:	FEBRUARY 22, 2024		
PENGUIN RANDOM HOUSE LLC	Sheet:	7 OF 9	SURVEYORS - LAND PLANNERS	
C/O RYNE BARRALL 400 BENNETT CERF DRIVE	Scale:	AS SHOWN	150 AIRPORT DRIVE - SUITE 4 WESTMINSTER, MARYLAND 21157	
WESTMINSTER, MD 21157 410-386-7725	BPR Drawing No.:	22-0614	PHONE: (410)-857-9030 OR (410)-876-0333	
	CC FILE #	ŧ: S-24-0005	FAX: (410)-876-0333 FAX: (410)-876-1532 WWW.BPRSURVEYING.COM	

- that have been in temporary vegetation for more than 6 months. 2. STANDARDS: The following notes shall conform to Section B-4 of the "2011 MARYLAND STANDARDS AND SPECIFICATIONS FOR SOIL EROSION AND SEDIMENT CONTROL" the National Resource Conservation Service and the Maryland Association of Soil Conservation
- incorporating the lime and fertilizer into this loosened layer of soil. See section B-4-2. of Maryland or a recognized commercial laboratory. Minimum soil conditions shall meet the requirements of section B-4-2-A-2-a, otherwise soil amendments or topsoil will need to be in section B-4-2-B. Soil amendments must meet the requirements as set forth in section B-4-2-C and must be applied as indicated by the soils tests.
- i) N = 45 lb. per acre (1 lb. per 1000 sq.ft.) P205 = 90 lb. per acre (2 lb. per 1000 sq.ft.)
- and will be applied along with seed or immediately after seeding

SEED MIXTURE (FOR HARDINESS ZONE 7-B) (FROM TABLE 25)				FERTILIZER RATE (10-20-20)			LIME
SPECIES	APPLICATION RATE (lb/ac)	SEEDING DATES	SEEDING DEPTHS	N	P205	K20	RATE
TALL FESCUE TALL FESCUE	120 3	3/1 - 5/15 8/15 - 11/15					
				90 lb/ac (2.0 LB/ 1000 SF)	175 lb/ac (4 LB/ 1000 SF)	175 lb/ac (4 LB/ 1000 SF)	2 TONS/ (100 LB 1000 SF

- fertilizer into this loosened layer of soil. See section B-4-2

SEED MIXTURE (FOR HARDINESS ZONE 6-(FROM TABLE 26) ERTILIZER RATE (10-10-10) LIME RATE APPLICATION SEEDING RATE (Ib/ac) DATES SPECIES BARLEY OR RYE 150 1 3/1 \ 5/15 8/15 \ 10/15 600 lb/ac (15 lb/1,000 sf) 2 TONS/ac (100 lb/1,000 sf)

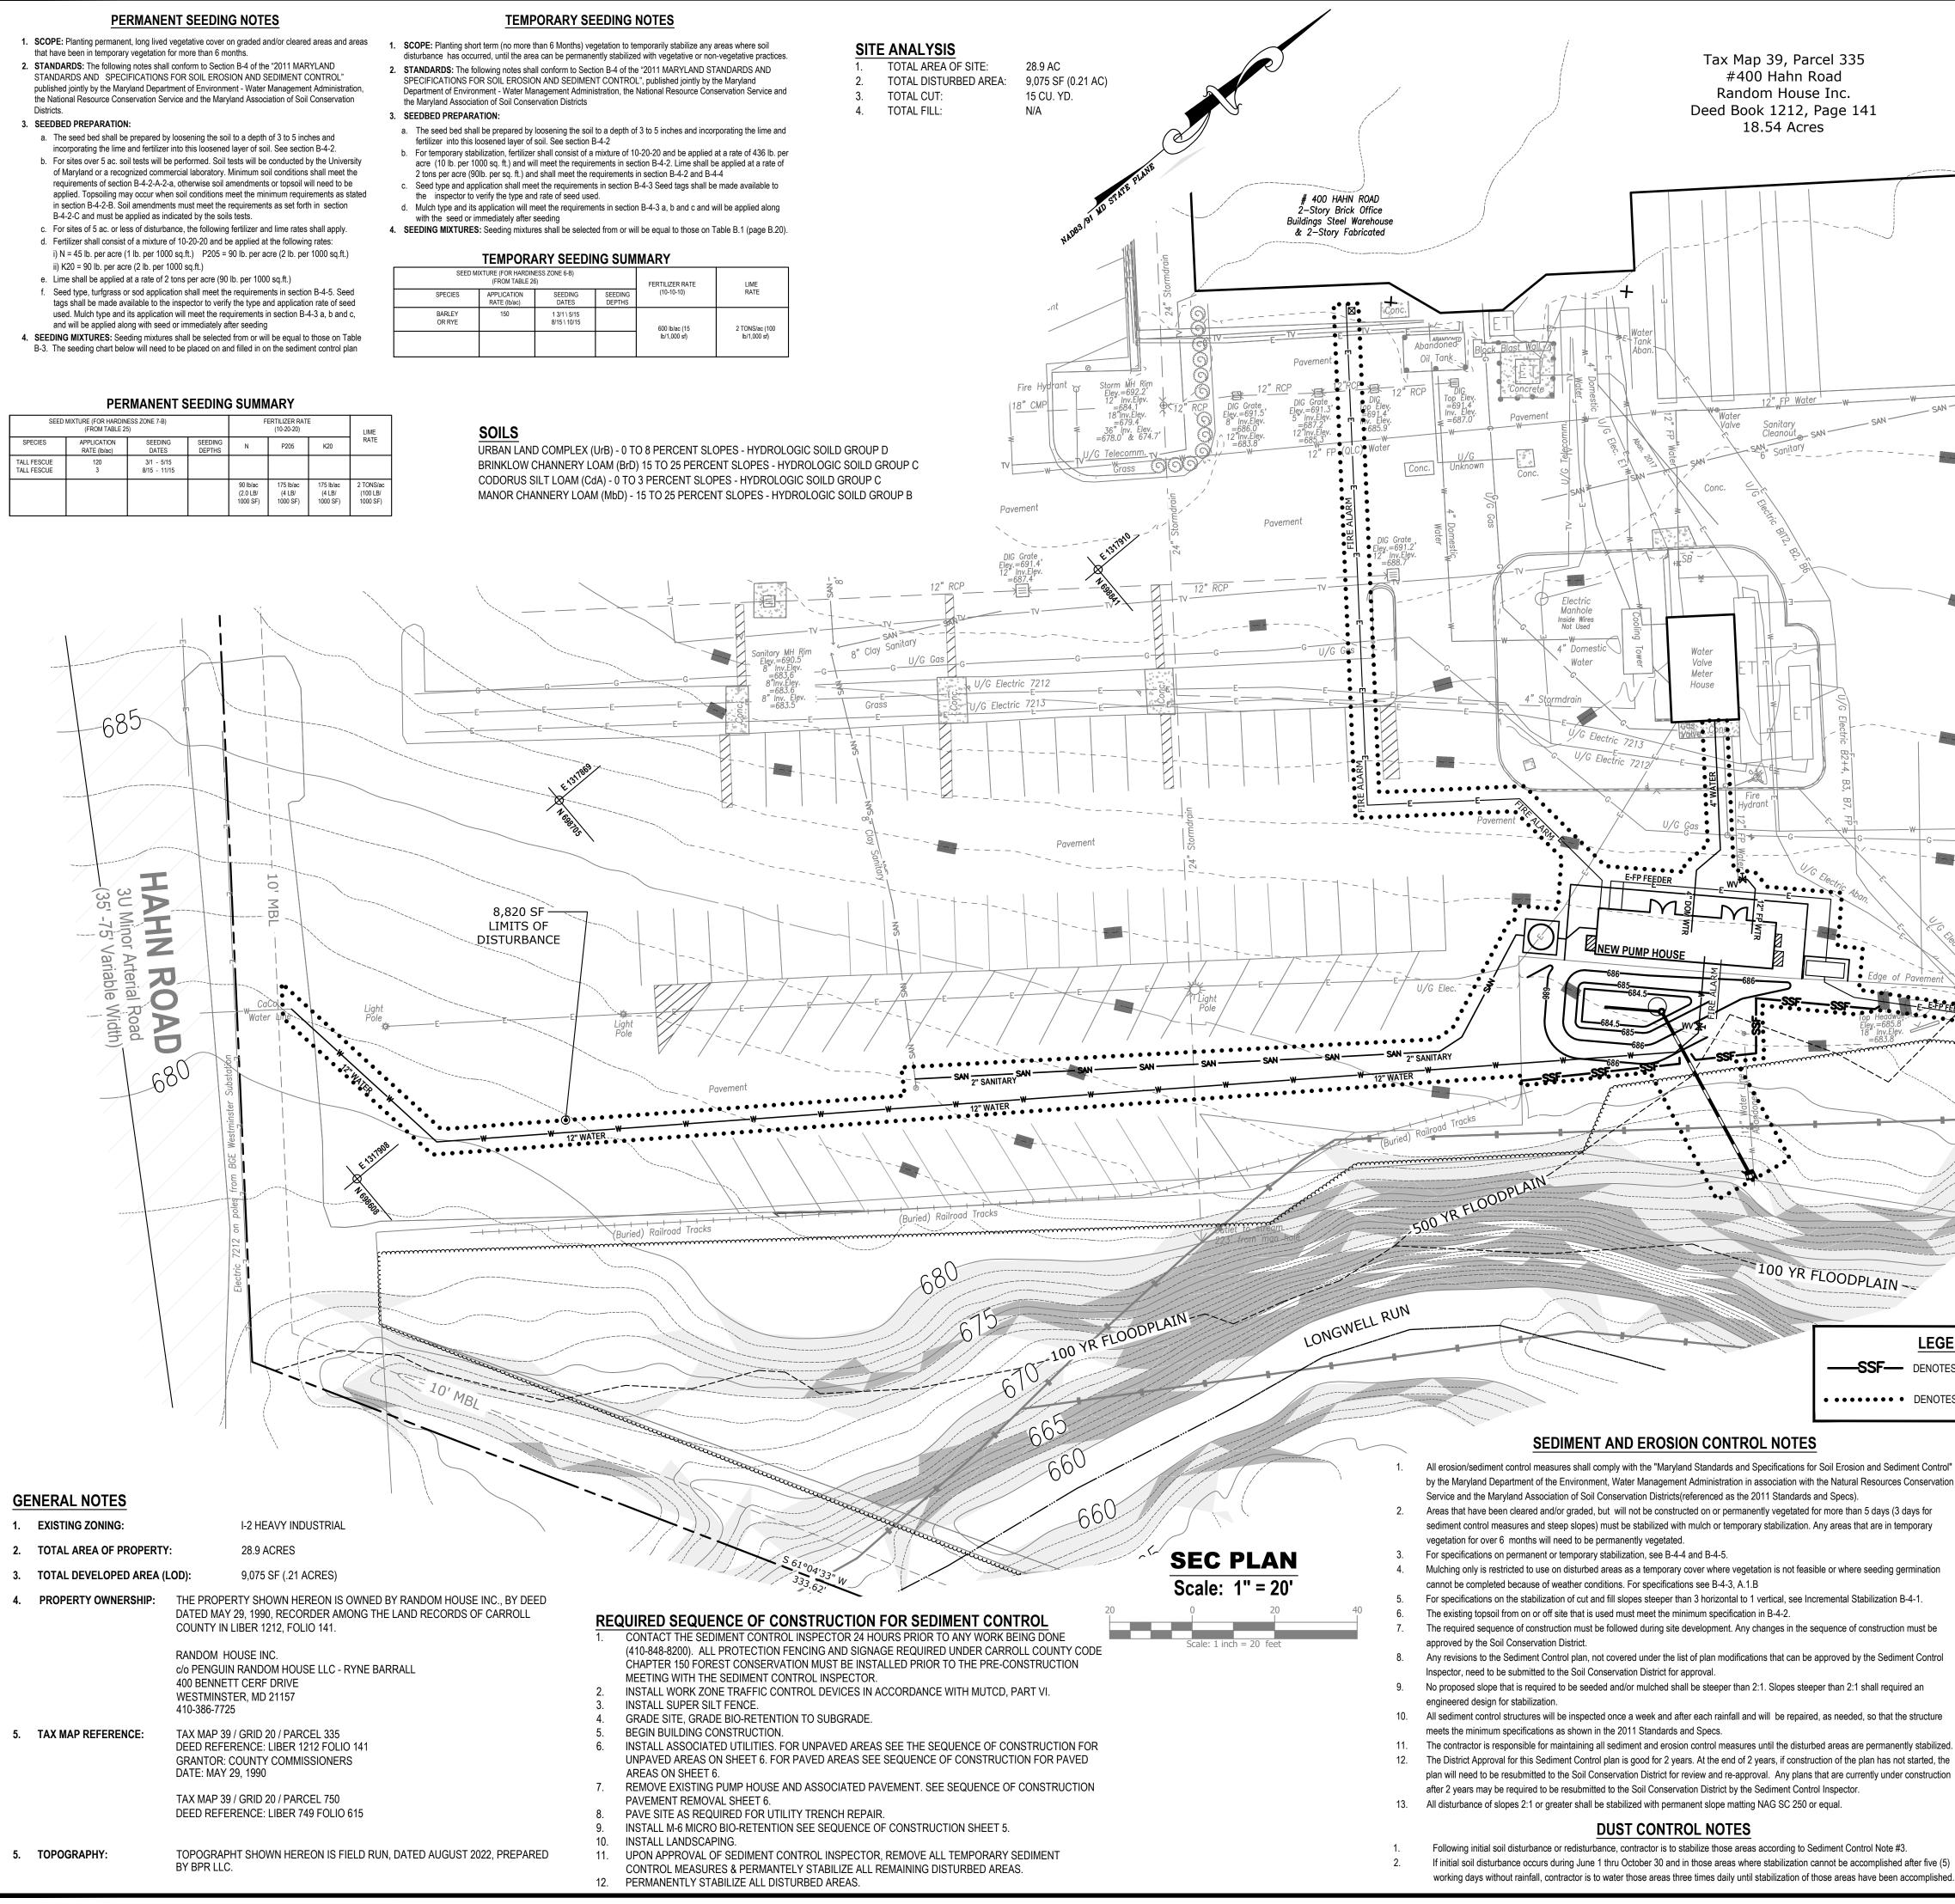

	Γ	DE	TAIL E-	3 SUPER SILT	FENCE	STANDARD SYMBOL	
		10 FT MAX.					
		GROUND SURFACE					
	12" FP Water W		6 IN DIAMETI GALVANIZI STEEL (JMINUM POS	ED WOVEI DR	ANIZED CHAIN LINK FENCE N SLIT FILM GEOTEXTILE	WITH	
W SAN			WOVEN SL 	HAIN LINK FENCING IT FILM GEOTEXTILE W D GEOTEXTILE AND N LINK FENCE 8 IN MIN. INTO GROUND CROSS SECTI			
		LENGTH SPAC INTO THE GR	INCH DIAMET CED NO FUR OUND.	CATIONS TER GALVANIZED STEEL PO THER THAN 10 FEET APAF	DSTS OF 0.095 INCH WALL RT. DRIVE THE POSTS A M	INIMUM OF 36 INCHES	от
	E 1378066	 INCHES IN HE FASTEN WOVI UPSLOPE SID SECTION. EME WHERE ENDS FOLDED, AND 	EIGHT SECUR EN SLIT FILM E OF CHAIN BED GEOTEX OF THE GEO STAPLED T	ELY TO THE FENCE POST GEOTEXTILE AS SPECIFIE LINK FENCE WITH TIES SF TILE AND CHAIN LINK FEN DTEXTILE COME TOGETHER O PREVENT SEDIMENT BY		RINGS. ALS, SECURELY TO THE AT THE TOP AND MID ES INTO THE GROUND. ERLAPPED BY 6 INCHES,	
		 EXTEND BOTH ENDS OF THE SUPER SILT FENCE A MINIMUM OF FIVE HORIZONTAL FEET UPSLOPE AT 45 DEGREES TO THE MAIN FENCE ALIGNMENT TO PREVENT RUNOFF FROM GOING AROUND THE ENDS OF THE SUPER SILT FENCE. PROVIDE MANUFACTURER CERTIFICATION TO THE INSPECTION/ENFORCEMENT AUTHORITY SHOWING THAT GEOTEXTILE USED MEETS THE REQUIREMENTS IN SECTION H-1 MATERIALS. REMOVE ACCUMULATED SEDIMENT AND DEBRIS WHEN BULGES DEVELOP IN FENCE OR WHEN SEDIMENT REACHES 25% OF FENCE HEIGHT. REPLACE GEOTEXTILE IF TORN. IF UNDERMINING OCCURS, REINSTALL CHAIN LINK FENCING AND GEOTEXTILE. 					
	Y FP Water	MARYLA U.S. DEPARTME IATURAL RESOURCE	ENT OF AGRIC			EDIMENT CONTROL EPARTMENT OF ENVIRONMEI NAGEMENT ADMINISTRATION	
e of Pavement	8011		FUL SPE CON ENV BEF	RTIFY THAT THIS PLAN OF SOIL ER LEST EXTEND AND ALL STRUCTURE LLED OUT IN THIS PLAN, AND ISTRUCTION PROJECT WILL HAVE IRONMENT APPROVED TRAINING P ORE BEGINNING THE PROJECT.	VNER / DEVELOPER DSION AND SEDIMENT CONTROL WIL SWILL BE INSTALLED TO THE DESIG THAT ANY RESPONSIBLE PERSO A CERTIFICATION OF ATTENDANCE ROGRAM FOR THE CONTROL OF SC I ALSO AUTHORIZE PERIODIC ON- CT PERSONNEL AND COOPERATING	ON AND SPECIFICATIONS, AS DNNEL INVOLVED IN THIS AT A DEPARTMENT OF THE DIL EROSION AND SEDIMENT SITE EVALUATION BY THE	
adwall	Electric MH		Owr	ner / Developer		Date	
				SOIL CONSERVATION DISTRICT THIS PLAN IS APPROVED FOR SOIL EROSION AND SEDIMENT CONTROL BY THE CARROLL SOIL CONSERVATION DISTRICT.			
			A	pproved:Ca	arroll SCD	_ Date:	
IN			PERSONAL	KNOWLEDGE OF THE SITE C	ENGINEER DSION AND SEDIMENT CONTR CONDITIONS AND HAS BEEN D CARROLL SOIL CONSERVAT	DESIGNED TO THE STANDAR	RDS
DENOTES SI	-		Consultant _	Randall A. Petkus, P.E. MD PE #15820 Expiration I			
Sediment Control" urces Conservation		11/14/24 9/23/24 8/7/24 6/6/24 4/12/24	ADDRESS COUNTY COMMENTS ADDRESS COUNTY SWM & WRM COMMENTS ADDRESS COUNTY COMMENTS ADDRESS COUNTY COMMENTS ADDRESS COUNTY COMMENTS			MJM MJM MJM MJM	
ys (3 days for in temporary		DATE REVISION BY SEDIMENT EROSION CONTROL PLAN PENGUIN RANDOM HOUSE					
ing germination tion B-4-1. uction must be			7th	FIRE PUM	P UPGRADES CARROLL COUNTY, MAR	RYLAND	
ediment Control	OWNER / DEVELOPER	Surveye BPR		Drawn By MJM	MJM		
required an hat the structure		Compute BPR	-	Checked By BPR			
nanently stabilized.		Date:		FEBRUARY 22, 2024		LLC	
as not started, the under construction	HOUSE LLC C/O RYNE BARRALL 400 BENNETT CERF DRIVE	Scale:		6 OF 9 1" = 20'		ORT DRIVE - SUITE 4	
	400 BENNETT CERF DRIVE WESTMINSTER, MD 21157 410-386-7725	BPR Drawing N	lo.:	22-0614	PHONE	ER, MARYLAND 21157 E: (410)-857-9030 (410)-876-0333	
ote #3. ished after five (5)		C	C FILE #:	S-24-0005	FAX:	(410)-876-1532 RSURVEYING.COM	

